

## DATE ASSIGNED\_\_\_\_ **APPLICATION FOR** HISTORIC AREA WORK PERMIT HISTORIC PRESERVATION COMMISSION 301.563.3400

HAWP#\_\_

FOR STAFF ONLY:

Date

#### **APPLICANT:**

| Name:   | E-mail: _  | E-mail:   |  |  |  |
|---|--|---|--|--|--|
| Address:  | City:  | Zip:  |  |  |  |
| Daytime Phone:  | Tax Acco   | Tax Account No.:  |  |  |  |
| AGENT/CONTACT (if applicab  | le):   |   |  |  |  |
| Name:   | E-mail: _  | E-mail:   |  |  |  |
| Address:  |  | Zip:  |  |  |  |
| Daytime Phone: Cont   |  | ntractor Registration No.:  |  |  |  |
| LOCATION OF BUILDING/PRE  | MISE: MIHP # of Historic Property  | <b>y</b>  |  |  |  |
| map of the easement, and docu<br>Are other Planning and/or Hear   | n/Land Trust/Environmental Ease<br>umentation from the Easement Ho   | s Required as part of this Application?   |  |  |  |
| Building Number:  | Street:  |   |  |  |  |
| Town/City:  | Nearest Cross Street: _  |   |  |  |  |
| Lot: Block:   | Subdivision: P   | Parcel:   |  |  |  |
| for proposed work are submode accepted for review. Checonstruction Addition Demolition Grading/Excavation I hereby certify that I have the and accurate and that the cons | itted with this application. Income k all that apply:  Deck/Porch Fence Hardscape/Landscape Roof authority to make the foregoing a struction will comply with plans re | verify that all supporting items omplete Applications will not Shed/Garage/Accessory Structure Solar Tree removal/planting Window/Door Other: application, that the application is corrected and approved by all necessary ition for the issuance of this permit. |  |  |  |

Signature of owner or authorized agent

# HAWP APPLICATION: MAILING ADDRESSES FOR NOTIFING [Owner, Owner's Agent, Adjacent and Confronting Property Owners] Owner's mailing address Owner's Agent's mailing address Adjacent and confronting Property Owners mailing addresses

| Description of Property: Please describe the building and surrounding environment. Include information on significant structures, landscape features, or other significant features of the property: |
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| Description of Work Proposed: Please give an overview of the work to be undertaken:  |
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| Work Item 1:                      |                |
|-----------------------------------|----------------|
| Description of Current Condition: | Proposed Work: |
|                                   |                |
| Work Item 2:                      |                |
| Description of Current Condition: | Proposed Work: |
| Work Item 3:                      |                |
| Description of Current Condition: | Proposed Work: |

## HISTORIC AREA WORK PERMIT CHECKLIST OF APPLICATION REQUIREMENTS

|                                       | Required<br>Attachments   |              |                         |                            |                |                |                                   |
|---------------------------------------|---------------------------|--------------|-------------------------|----------------------------|----------------|----------------|-----------------------------------|
| Proposed<br>Work                      | I. Written<br>Description | 2. Site Plan | 3. Plans/<br>Elevations | 4. Material Specifications | 5. Photographs | 6. Tree Survey | 7. Property<br>Owner<br>Addresses |
| New<br>Construction                   | *                         | *            | *                       | *                          | *              | *              | *                                 |
| Additions/<br>Alterations             | *                         | *            | *                       | *                          | *              | *              | *                                 |
| Demolition                            | *                         | *            | *                       |                            | *              |                | *                                 |
| Deck/Porch                            | *                         | *            | *                       | *                          | *              | *              | *                                 |
| Fence/Wall                            | *                         | *            | *                       | *                          | *              | *              | *                                 |
| Driveway/<br>Parking Area             | *                         | *            |                         | *                          | *              | *              | *                                 |
| Grading/Exc<br>avation/Land<br>scaing | *                         | *            |                         | *                          | *              | *              | *                                 |
| Tree Removal                          | *                         | *            |                         | *                          | *              | *              | *                                 |
| Siding/ Roof<br>Changes               | *                         | *            | *                       | *                          | *              |                | *                                 |
| Window/<br>Door Changes               | *                         | *            | *                       | *                          | *              |                | *                                 |
| Masonry<br>Repair/<br>Repoint         | *                         | *            | *                       | *                          | *              |                | *                                 |
| Signs                                 | *                         | *            | *                       | *                          | *              |                | *                                 |

## Holness Residence 7210 Spruce Avenue Takoma Park, MD. 20912

-Plans conform with IRC 2021 -All wood in contact with soil or masonry foundations will meet the ASTM standard A 153 and A653, class 185. -All framing lumber to be SPF#2 unless indicated otherwise. -Design criteria used are as follows: -Roof load -30lbs/sf. -Roof and floor dead load-10lbs/sf. -Seismic design category B. -Termite damage subjectivity-moderate to heavy. -Winter design temperature-15 degrees F, -9 degrees C. -Subjectivity to damage from weather-heavy. -Subjectivity to decay -moderate. -Floor live load in non-sleeping areas-40lbs/sf. -Floor live load in sleeping areas- 30lbs/sf. -Wind speed-90mph (3 sec. gust method) 90 mph 40 m/s. -Frost line depth-24". -Flood hazard-Yes. -Subfloors- 3/4" APA subfloor/underlayment rated, tongue and groove, glued and nailed to joists.
-Roof sheathing-12/" OSB with spacers. -Roofing-2151b per square asphalt shingles over 151b. felt.

STRUCTURAL NOTES SOIL BEARING AND WATER CONDITION: ASSUMED SOIL BEARING CAPACITY OF 1500 PSF (MIN.) WITH A LATERAL PRESSURE OF 60 PSF. LIVE LOADS: ROOF...... FLOOR..... STAIRWAY..... FLOOR 40 PSF 15 MIND LOAD ..... BACKFILL: SHALL NOT BE PLACED AGAINST WALLS UNTIL SLABS ON GRADE FOUNDATIONS: BOTTOMS OF THE ALL EXTERIOR FOOTINGS SHALL BE A MINIMUM OF 2'-6" BELOW FINISH GRADE. ALL FOOTINGS SHALL BE AS SHOWN ON FOOTING PLANS AND PROJECT 12" INTO UNDISTURBED EX'G. NATURAL GROUND HAVING ALLOWABLE BEARING CAPACITY AS PER SOIL CONSULTANT'S RECOMMENDATIONS, DEPTHS AND SIZES OF ALL FOOTINGS SHALL BE VERIFIED IN THE FIELD. DEPTHS SHALL BE SUBJECT TO CHANGE IF SOIL CONDITIONS ARE OTHER THAN ASSUMED. IF SOIL CONDITIONS ARE OTHER THAN ASSUMED. CONCRETE: ALL CONCRETE CONSTRUCTION SHALL CONFORM TO THE LATEST A.C.I. CODE 3 18. 28-DAY CONCRETE STRENGTH SHALL BE AS FOLLOWS: F'C= 2,500 PSI FOR FOOTINGS, INTERIOR SLABS ON GRADE AND FILL IN CONCRETE BLOCKS. F'C= 3,000 PSI FOR EXTERIOR SLABS ON GRADE. F'C= 4,000 PSI FOR PRECAST CONCRETE UNITS. ALL ROOFING MATERIALS TO HAVE ICE DAMMING PROTECTION. WOOD SPECIES AND GRADE: HEM-FIR (SURFACED DRY OR SURFACED GREEN USED AT 19% MAX. No. 2 OR BETTER WITH THE FOLLOWING DESIGN VALUES: Fb = 1,150 PSI (SINGLE MEMBER) 75 PSI Fc = 825 PSI E = 1,400,000 PSI LAMINATED VENEER LUMBER: MICRO-LAM LUMBER OR BETTER WITH THE FOLLOWING DESIGN PROPERTIES: Fv = 285 PSI Fc = 2,700 PSI E = 2,000,000 PSI VERTICAL LOAD TRANSFER: ALL STRUCTURAL POSTS MUST BE VERTICALLY ALIGNED AND BLOCKED TO PROVIDE CONTINUOUS BEARING TO FOUNDATION.

### COPE OF MORK:

1-DEMO EXISTING LANDING SECTION AND STAIRS. 2-CONSTRUCT NEW LANDING SECTION AND HANDICAP RAMP.

## INDEX

COVER SHEET
FLOOR PLANS
ELEV, FRAMING, SECT. AND DETAILS
A001

Holness Residence
1210 Spruce Avenue


 Date:
 3/19/25


 Drawn By:
 A&LK LOML

Scale: 1/4"=1'-0"

Sheet Number:

Cover Page

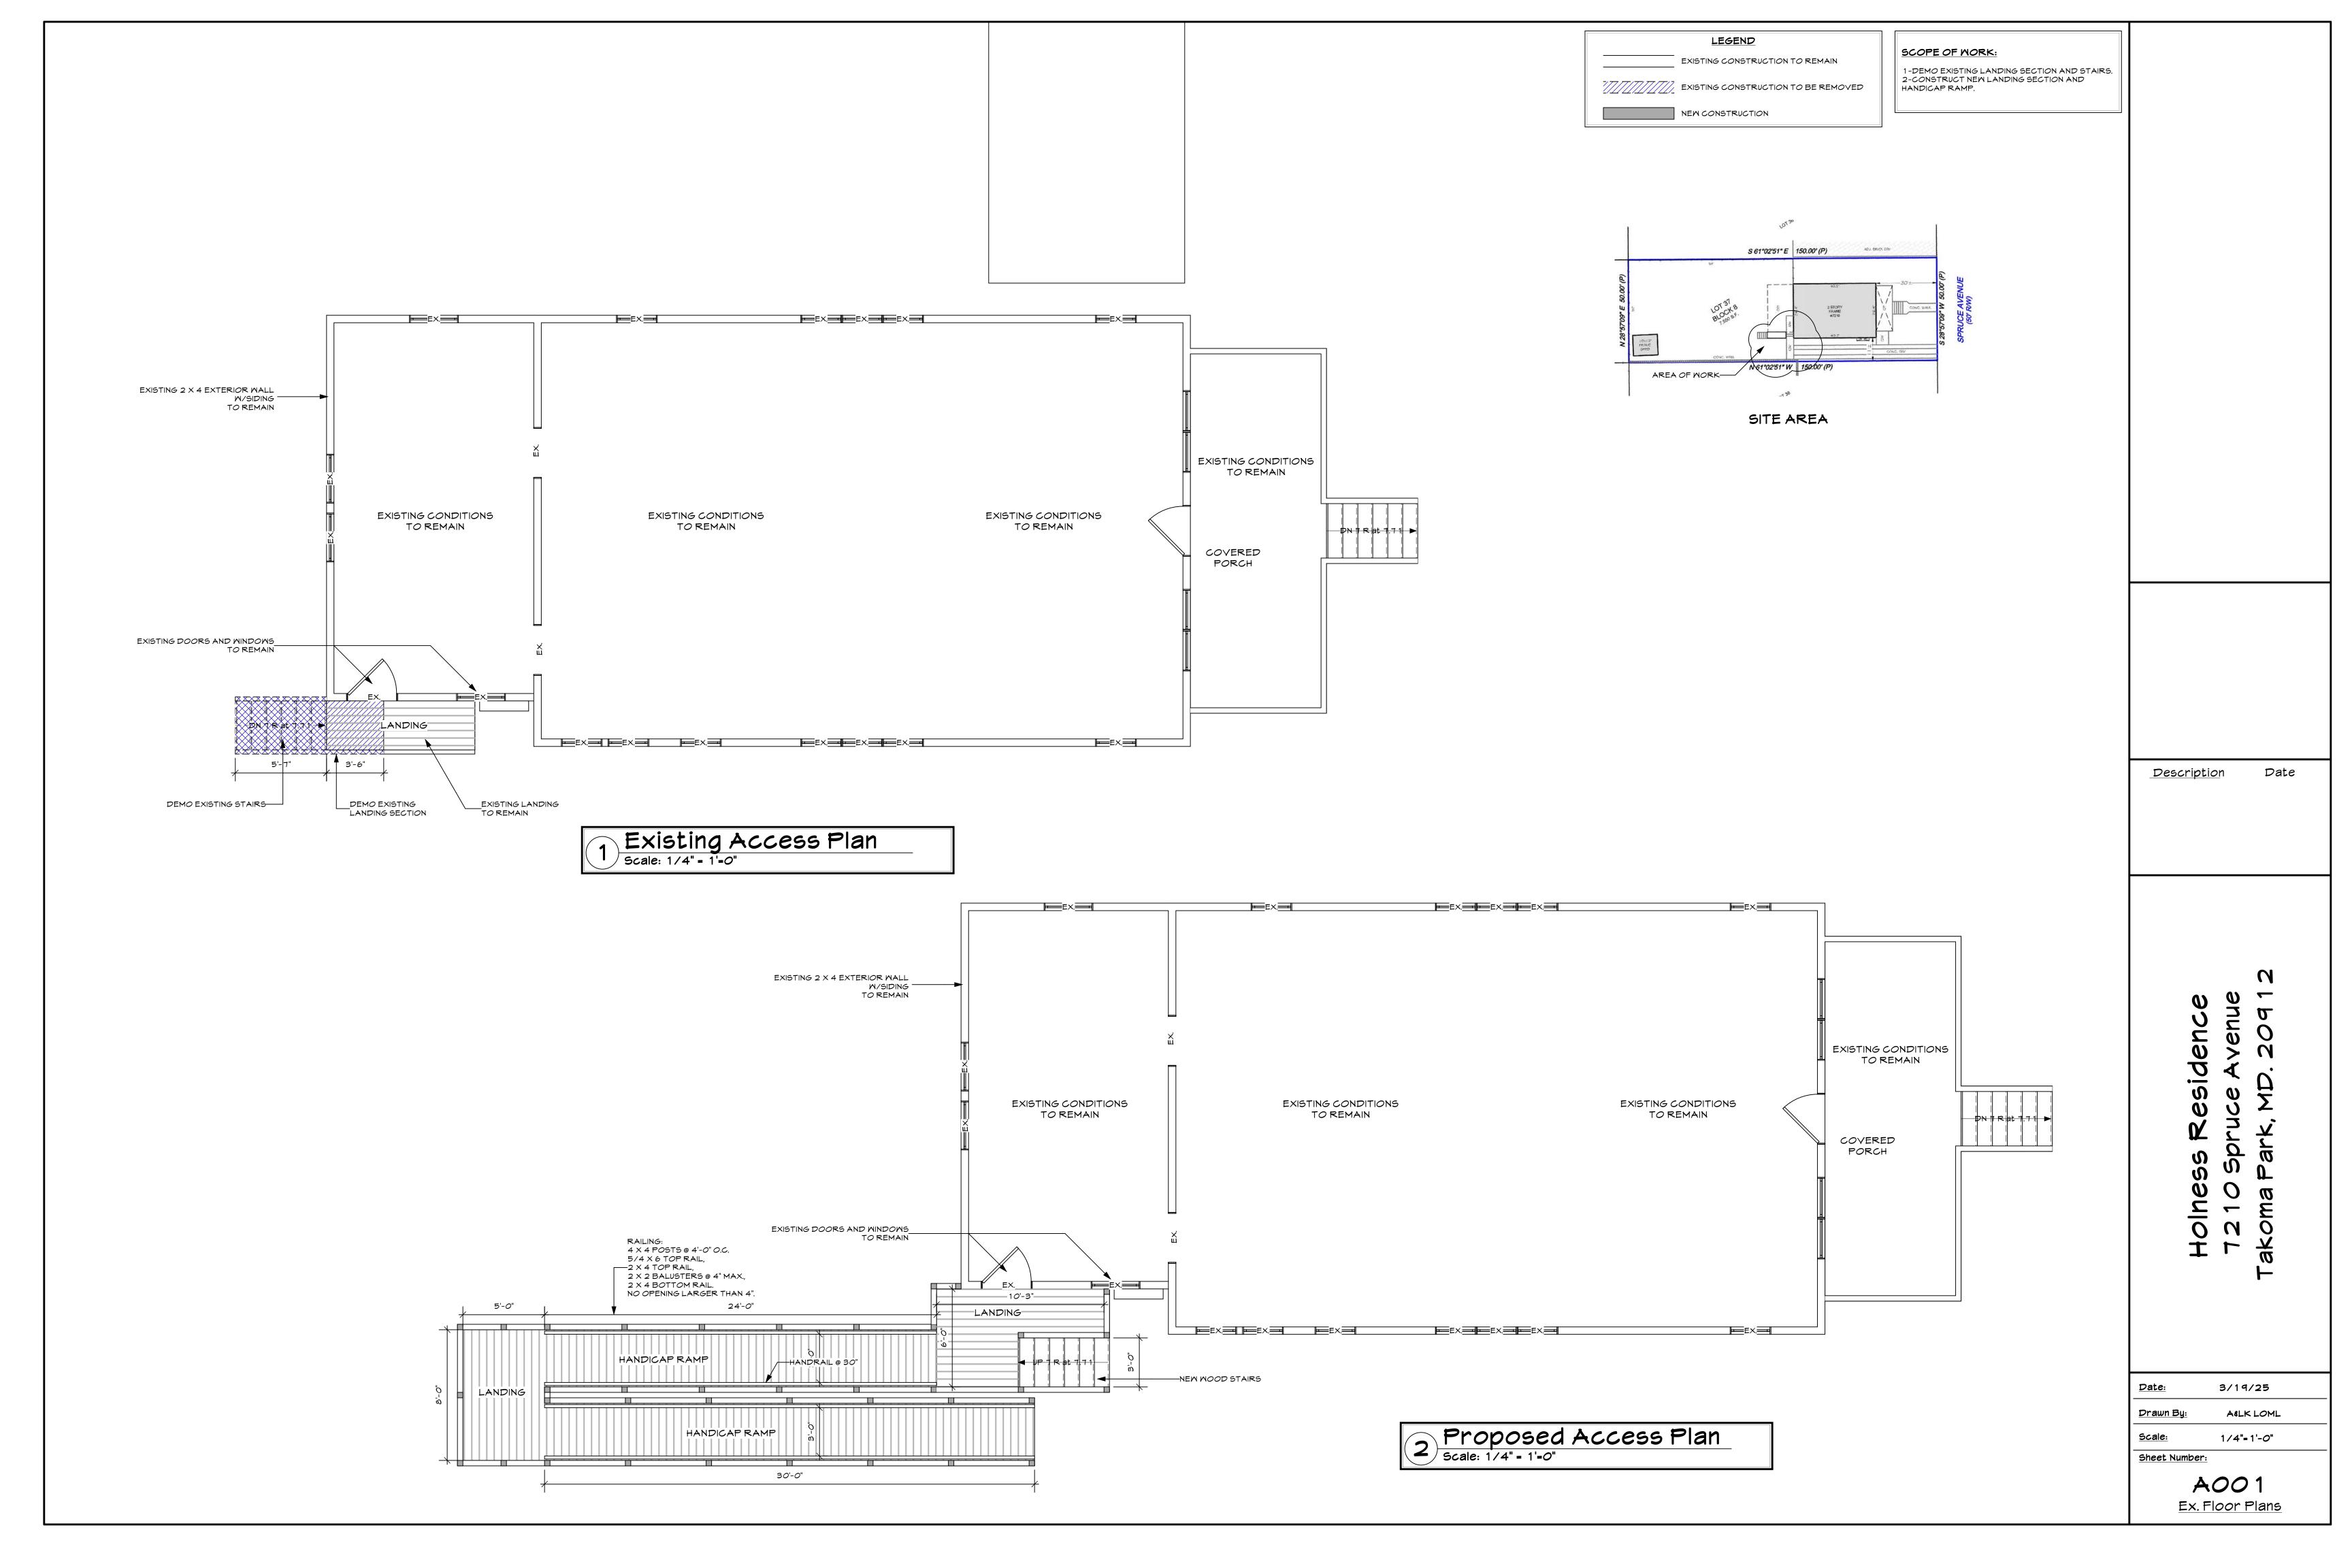

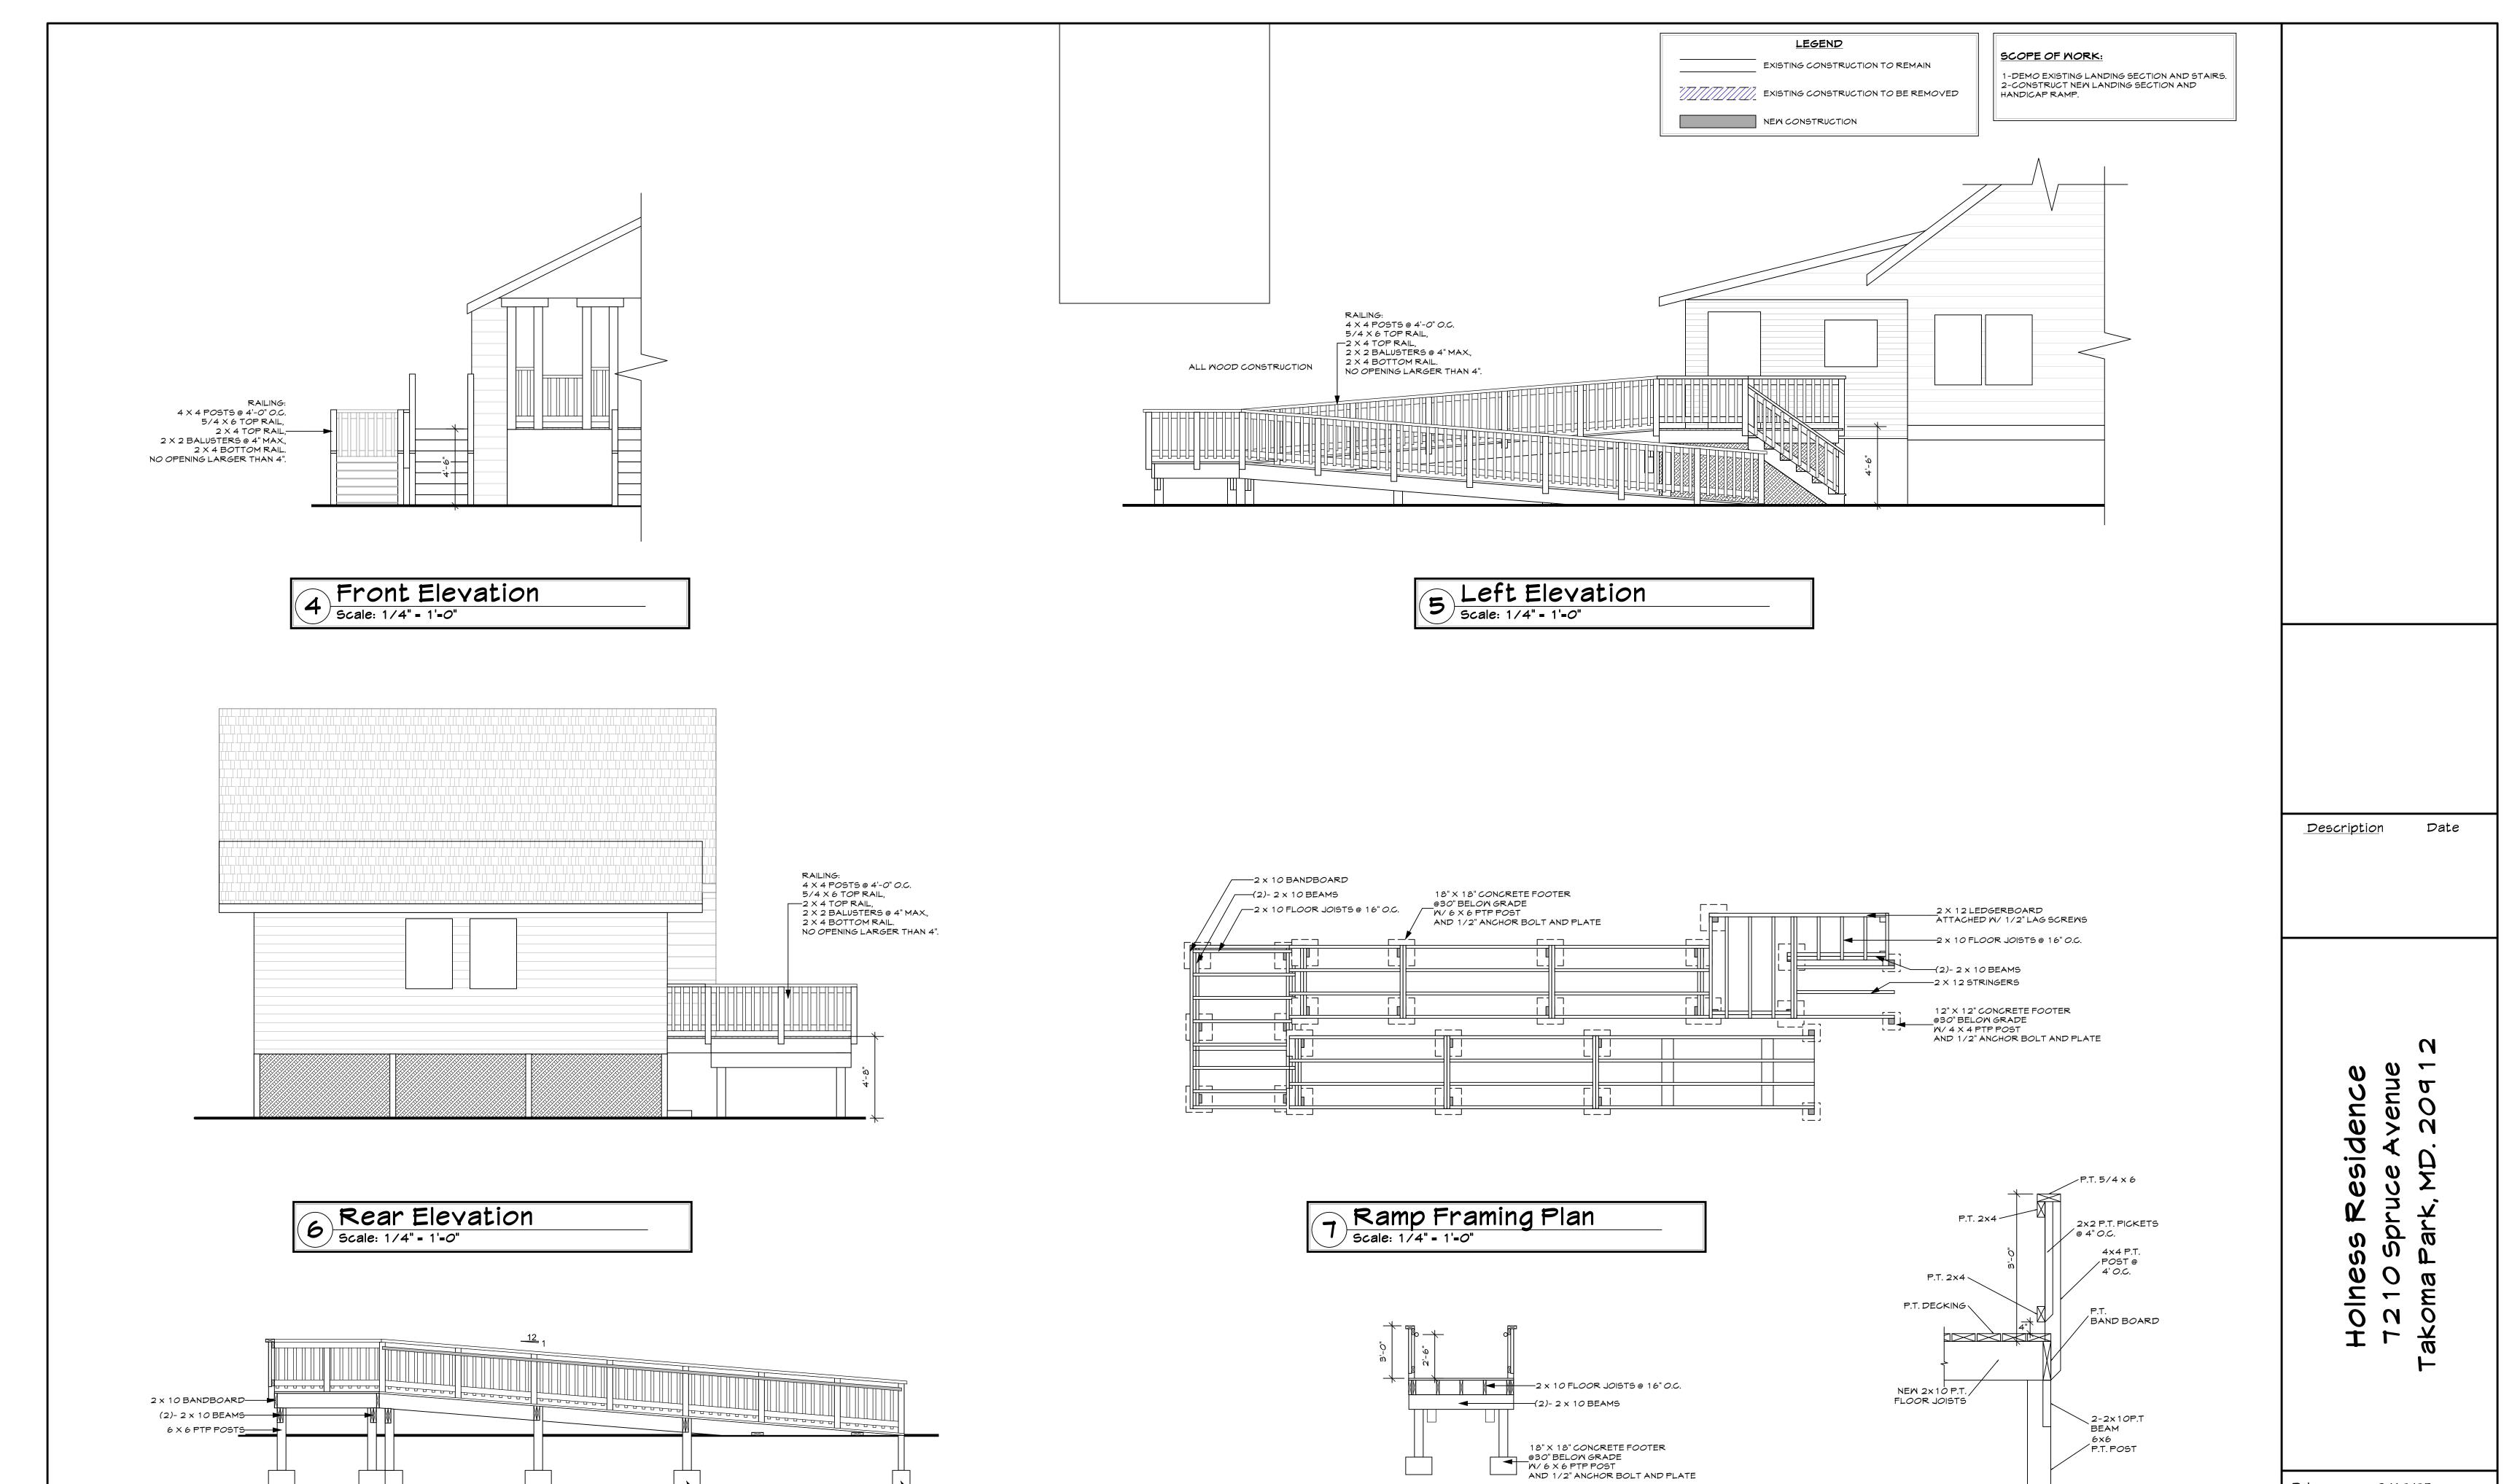

9 Landing Section
Scale: 1/4" - 1'-0"

18" X 18" CONCRETE FOOTER \_\_@30" BELOW GRADE

AND 1/2" ANCHOR BOLT AND PLATE

8 Ramp Section
Scale: 1/4" - 1'-0"

12" X 12" CONCRETE FOOTER \_\_@30" BELOW GRADE

W/4 X 4 PTP POST AND 1/2" ANCHOR BOLT AND PLATE Date: 3/19/25

Drawn By: A&LK LOML

Scale: 1/4"-1'-0"

Sheet Number:

AOO2

Prop Basement Plan













