Preliminary Consultation MONTGOMERY COUNTY HISTORIC PRESERVATION COMMISSION STAFF REPORT

Address: 9220 Damascus Hills Lane, Damascus Meeting Date: 5/8/2024

Resource: Master Plan Site #11/21 **Report Date:** 5/1/2024

(Rezin Bowman Farm)

Applicant: Daniel Ferenczy **Public Notice:** 4/24/2024

Review: Preliminary Consultation Tax Credit: Partial

Permit No.: 1067141 Staff: Chris Berger

PROPOSAL: Partial demolition, building addition, roof alteration

STAFF RECOMMENDATION

Staff recommends that the applicant make any revisions based upon the HPC's comments and return with a HAWP application.



Figure 1: The Rezin Bowman Farm Master Plan Site boundaries are shaded in red.

PROPERTY DESCRIPTION

SIGNIFICANCE: Master Plan Site #11/21, Rezin Bowman Farm

STYLE: Farmstead
DATE: circa 1827-1939

Excerpt from Damascus-Goshen Historic Resources Master Plan Amendment:

The Rezin Bowman Farm was established at the headwaters of Great Seneca Creek. The farmstead is significant for its collection of buildings that represent an evolution of construction. By 1850, Aden Bowman (1787-1868) owned 520 acres of land and resided on this farm. He built the bank barn sometime after he acquired this land in 1827. Typical of successful farmers of the era, he grew a principal crop of tobacco, had diverse livestock, and grew corn, oats and wheat. His son, Rezin H. inherited the farm that he maintained through the century. The center cross gable dwelling represents a house type that was popular in Montgomery County from the post-Civil War era through the early 20th century. Claude Burdette continued the farm by introducing dairy cows, housed in the 16-cow dairy barn built by 1939.



Figure 2: The site map of the Rezin Bowman Farm that was included in the Damascus-Goshen Historic Resources Master Plan Amendment.



Figure 3: This 2023 CONNECTExplorer photo facing south shows the front and right-side elevations of the Farmhouse. The looped driveway is to the left, and the blue line is the property boundary.



Figure 4: This 2023 CONNECTExplorer photo facing north shows the rear and left-side elevations of the Farmhouse. The looped driveway is to the right, and the blue line is the property boundary.

BACKGROUND

The County Council adopted in 2009 the *Master Plan for Historic Preservation: Damascus-Goshen Historic Resources*, which included the Rezin Bowman Master Plan Historic Site (#11/21).

In 2021, Historic Preservation Office staff worked with the County's Department of Housing and Community Affairs (DHCA) and Department of Permitting Services (DPS) to issue an abatement order for the house. Housing code inspectors found nine violations, and the house was condemned and found unfit for human habitation.

On March 3, 2022, the HPC provided a preliminary consultation on the farmhouse for the following work items: 1

¹ The staff report for the Preliminary Consultation is available here: https://montgomeryplanning.org/wp-

- Extend the foundation of the existing rear addition 5-by-6 feet to accommodate a proposed new mudroom entrance.
- Rebuild a former rear deck, with the new proposed deck being 12-by-24 feet.
- Replace the existing sheathing and wooden clapboard siding with lime plaster.
- Remove the existing rear addition roof and alter the rear addition, creating a two-story rear addition with living (moss and succulent covered) roof.

At the preliminary consultation, the HPC was generally supportive of the applicant's proposal and provided the following comments and recommendations to ensure compatibility and consistency with the applicable guidelines and Standards:

- Additional details and better drawings should be submitted with the formal HAWP submission to
 provide clarity on the proposed rear addition, the proposed addition's roof form, and the proposed
 green roofing.
- Although not specified in the previous submission, there were concerns about the proposed number of lites for the replacement windows on the house. 2-over-2 double-hung windows to match the existing/original windows were noted as the appropriate option.
- There were concerns regarding the proposed straw and lime plaster treatment on the original house, with some preferring in-kind replacement of the existing wood clapboard siding.
 - Several commissioners commented that the most significant character-defining feature of the historic house is its form and massing (including the traditional L-shaped configuration and the center cross gable on the front elevation), and they supported the proposed straw and lime plaster treatment throughout.
 - Alternative suggestions included retaining the wood clapboard siding on the original house and only using the straw and lime plaster treatment on the addition or applying wood clapboard siding to match the existing over the proposed lime plaster on the original house, if practicable.

Next, the HPC approved HAWP #981848 as part of the consent agenda at its May 4, 2022, meeting for the following work:²

- Extend the foundation of the existing rear addition 5-by-6 feet to accommodate a proposed new mudroom entrance.
- Replace the existing sheathing and wooden clapboard siding with lime plaster.
- Remove the existing rear addition roof and alter the rear addition, creating a two-story rear addition.
 - Materials for the proposed addition include a living (moss and succulent covered) roof, wood casement windows, wood trim, and lime plaster siding.
- Comprehensive rehabilitation of the historic house, including repair of the existing attic windows, installation of new 2/2 double hung TDL wood windows, installation of new wood paneled doors, and in-kind repair of the existing standing seam metal roof.

None of the work was completed.

<u>content/uploads/2022/02/II.A-9220-Damascus-Hills-Lane-Damascus-Preliminary-Consultation.pdf</u> Link to March 2, 2022, HPC meeting audio/video transcript:

https://mncppc.granicus.com/player/clip/2561?publish_id=f9e5e2b8-9b0e-11ec-972b-0050569183fa&redirect=true

content/uploads/2022/04/I.E-9220-Damascus-Hills-Lane-Damascus-981848.pdf

Link to May 4, 2022, HPC meeting audio/video transcript:

http://mncppc.granicus.com/MediaPlayer.php?publish_id=c9bae72c-cc7d-11ec-bbb4-0050569183fa

² The staff report for HAWP #981848 is available here: https://montgomeryplanning.org/wp-

PROPOSAL

The applicant wrote the following under the description of work proposed:

For this HAWP we are proposing a complete farmhouse rehabilitation while retaining the original architectural features of the home. We will ensure the massing of the main block, front facade, clapboard siding, and historic window shape, size, and dimension are retained and clearly discernible. We will ensure the deteriorated clapboard siding is removed and replaced with real wood clapboard.

We are proposing the following:

- 1. Extend Rear addition by 5'x6' to accommodate a mudroom, and re-attach a 12'x24' rear deck.
- 2. Remove and replace deteriorated unpainted clapboard wood siding.
- 3. Remove the rear shed addition; replace with two-story frame and standing seam metal roof.

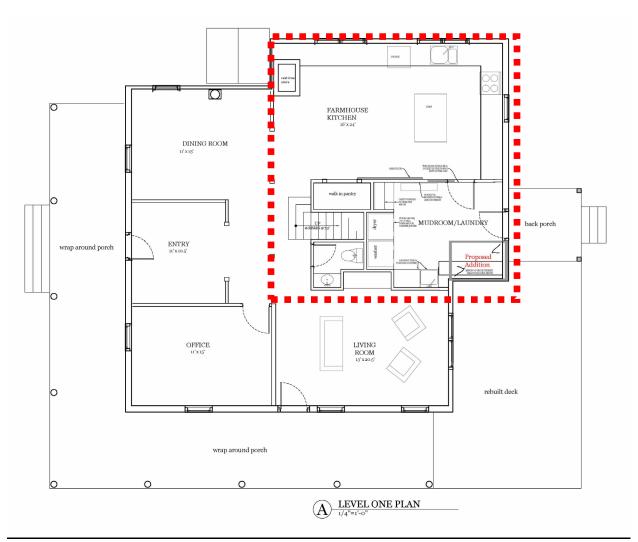


Figure 5: The proposed floor plan shows the new construction outlined in red.

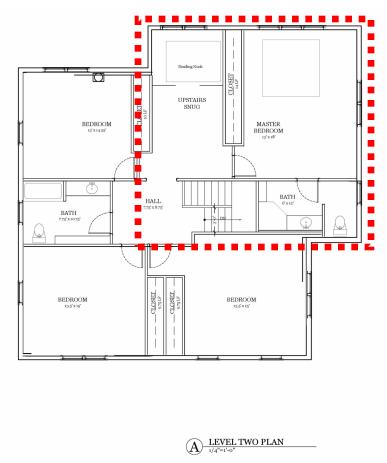


Figure 6: The proposed floor plan shows the new construction outlined in red.

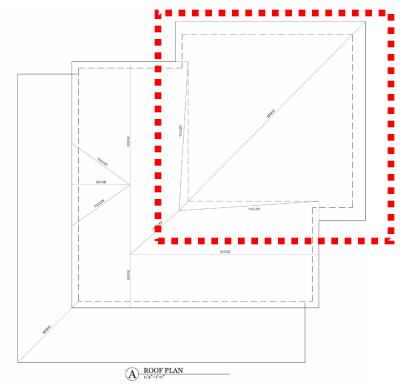


Figure 7: The proposed roof plan shows the new construction outlined in red.



Figure 8: The front elevation in 2021 and the proposed. The applicant appears to propose the removal of the gable window and chimney



Figure 9: The right-side elevation in 2021 and the proposed. The applicant proposes fenestration alterations and a rear addition, outlined in red.



Figure 10: The rear elevation in 2021 and the proposed. The applicant proposes to demolish the existing shed-roofed addition and build a new two-story addition in its place, outlined in red. He also proposed fenestration alterations on the portion of the building to be retained.

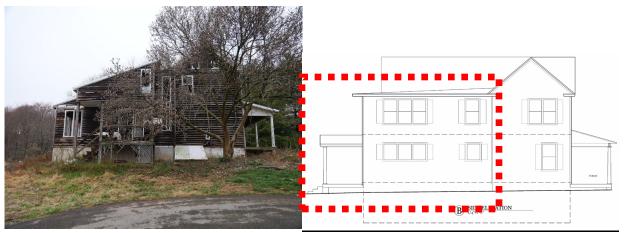


Figure 11: The left-side elevation in 2021 and the proposed. The applicant proposes demolition, fenestration alteration, and an addition to the rear, outlined in red.

APPLICABLE GUIDELINES

When reviewing alterations and new construction at Master Plan Sites several documents are to be utilized as guidelines to assist the Commission in developing their decision. These documents include Montgomery County Code Chapter 24A (Chapter 24A), the Damascus-Goshen Historic Resources Master Plan Amendment (Amendment), and the Secretary of the Interior's Standards for Rehabilitation (Standards). The pertinent information in these documents is outlined below.

Montgomery County Code Chapter 24A-8

- (b) The commission shall instruct the director to issue a permit, or issue a permit subject to such conditions as are found to be necessary to ensure conformity with the purposes and requirements of this chapter, if it finds that:
 - (1) The proposal will not substantially alter the exterior features of an historic site or historic resource within an historic district; or
 - (2) The proposal is compatible in character and nature with the historical, archeological, architectural or cultural features of the historic site or the historic district in which an historic resource is located and would not be detrimental thereto or to the achievement of the purposes of this chapter;

Damascus-Goshen Historic Resources Master Plan Amendment

The Amendment includes the following statement regarding the Rezin Bowman Farm:

The setting includes the dwelling house, corn crib, bank barn, dairy barn, and milk house. Since the dwelling house has had many alterations, additional changes should be reviewed with leniency by the Historic Preservation Commission.

Secretary of the Interior's Standards for Rehabilitation

- 2. The historic character of a property shall be retained and preserved. The removal of historic materials or alteration of features and spaces that characterize a property shall be avoided.
- 9. New additions, exterior alterations, or related new construction shall not destroy historic materials that characterize the property. The new work shall be differentiated from the old and shall be compatible with the massing, size, scale, and architectural features to protect the historic integrity

III.A

- of the property and its environment.
- 10. New additions and adjacent or related new construction shall be undertaken in such a manner that if removed in the future, the essential form and integrity of the historic property and its environment would be unimpaired.

STAFF DISCUSSION

Staff is generally supportive of the applicant's proposal for demolition and new construction on the rear and replacement of the wood siding. The house has experienced many alterations in the past, and per the *Amendment* the HPC is to be lenient in its review of additional changes. In accordance with Chapter 24A-8, the work will not substantially alter the exterior features of the historic site. Staff finds that these work items will not alter or remove character-defining features and/or materials of the subject property, in accordance with *Standards* #2 and 9. Further, these alterations could be removed in the future, leaving the essential form and integrity of the historic property and its environment unimpaired, per *Standard* #10.

The rear shed-roofed addition to be removed and replaced with a two-story addition is a non-original feature. Staff finds the size, scale, and massing of the new construction is appropriate for the historic resource. Staff does have concerns about the low roof pitch on the addition and seeks input from the HPC on an alternative. Staff recommends either a flat membrane roof or a standing seam cross gable roof that matches the pitches of the existing cross-gable roofs.

According to the applicant, none of the fenestration is salvageable. Photos from 2021 show the house with 2/2 wood sash windows on the front elevation and a wood front door; 2/2 wood sash and paired casement windows on the right-side elevation with a wood side entry door; casement windows, both paired and individual, and sliding glass doors on the rear elevation; and paired and individual casement and sash windows on the left-side elevation.

The plans included as part of this application show new 1/1 windows on the front elevation (*Figure 8*). Most of the windows will be in the same location as the existing, but the plans do not show the retention of the decorative window in the gable end. Staff does not support removal of that character-defining feature and recommends the applicant either restore the window or have a new window fabricated that matches the design of the previous. The photos from 2021 show broken panes, but the sashes are intact so staff recommends the windows be restored if they are intact. (Staff notes that window restoration is eligible for the county's 25 percent Historic Tax Credit.) If repair is not possible for some of the windows, then the replacement windows should match the previous 2/2 design. The applicant has not provided details on the front door; staff recommends the applicant install a period-appropriate wood-paneled door. The brick chimney integrated into the roof should also be retained.

On the right-side elevation, the applicant proposes shifting the location of the door; reconfiguring some of the window openings, removing the window in the gable end, and adding additional windows (*Figure 9*). Staff supports replacement of the paired casement window on the second floor, but only with a 2/2 wood sash window. Staff also supports reinstallation of a 2/2 sash window on the second floor in the location evident in the 1973 aerial (*Figure 12*). Staff does not support the removal, reconfiguration, and addition of other windows on this elevation. The applicant has not provided details on the door proposed for the elevation. Staff also seeks a wood-frame door in the existing door's location, but not in the new proposed location. As with the front elevation, the existing windows on the right-side elevation should be repaired. If replacement is necessary then the windows should be 2/2.



Figure 12: This image from Vintage Aerial shows the right-side elevation in 1973.

On the existing construction of the rear elevation, the applicant proposes removal of the window in the gable end and replacement of the sliding doors and paired casement windows with paired sash windows (*Figure 10*). On the proposed addition, the applicant proposes installation of paired sash and casement or awning windows and a new door with gabled roof. Staff does not support any of the window proposals. The existing window in the gable end should be retained and restored. Any newly installed windows on both the existing building and proposed addition should be 2/2 and be placed individually and match the rhythm of the existing sash windows.

Staff supports the basic design of the new covered entry on the rear elevation. Its gable roof and fascia returns reflect the design on the existing residence. The porch floor and stairs can be either wood or wood composite. The columns may also be a composite material. The roof should be standing-seam metal to match the existing roofing material. The piers should be either structural stone or stone cladding to match the material of the building's original foundation.

On the left-side elevation, staff does not support the triple window groupings and seeks individual windows on the addition (*Figure 11*). Staff opposes any new window openings or infills on the existing construction, and the sash windows should remain 2/2.

Staff encourages the applicant to install traditionally mounted wood shutters to flank the sash windows on the front and right-side elevation and be sized appropriately for the particular window.

At the existing wraparound front porch, staff encourages the applicant to restore the existing wood columns. The porch floor and stairs are missing, so the replacement floor should be wood tongue and groove laid perpendicular to the wall of the house. The piers appear to be pebbledash, and staff would support replacement with either structural stone or stone cladding to match the material of the building's

original foundation. The porch fascia includes painted beadboard infill, and staff encourages the applicant to retain that unique material. It does not appear balustrade and railings are necessary to meet residential building code, but if the applicant seeks to install them a simple wood design would be appropriate.

Staff supports replacement of the wood siding. The unpainted lap siding has a 5-inch reveal. It is not original to the home's construction and is unpainted, so it does not appear to be salvageable. Staff recommends the replacement lap siding be painted wood.

No plans were provided for the deck, but staff supports the proposed location at the right-side and rear elevations and its connection to the existing wraparound porch. Staff supports the proposed unfinished black locust decking.

Items to Include in HAWP Application

Staff recommends the following items be included in the HAWP application:

- Detailed as-built elevations that include material callouts, dimensions, and roof pitches.
- Detailed elevations for the proposed construction that include material callouts, dimensions, roof pitches, and detailed designs for proposed features.
- A window and door schedule that corresponds to the elevations. The aluminum clad window grilles shall be either full divided lite or simulated divided lite with permanent exterior and interior grilles.
- A detailed site plan for the area approximate to the residence that includes the existing and proposed hardscaping and proposed HVAC equipment.
- Specification sheets for all proposed building features, including the doors, windows, siding, trim, shutters, roofing, porch flooring; railings; hardscaping, lighting, HVAC equipment, and gutters and downspouts.

STAFF RECOMMENDATION

Staff recommends that the applicant make any revisions based upon the HPC's comments and return with a HAWP application.

Staff requests feedback from the HPC on:

- The rear addition's siting, size, scale, and massing.
- The proposed roof pitch on the addition and potential alternative roof types.
- The replacement window and door design and materials.
- The grouping, removal, and placement of the windows.
- The proposed shutters and potential alternatives.
- Appropriate replacement materials at the existing wraparound porch.
- Appropriate materials at the proposed rear porch.
- Any other comments.



APPLICATION FOR HISTORIC AREA WORK PERMIT HISTORIC PRESERVATION COMMISSION 301.563.3400

DATE ASSIGNED____

Date

FOR STAFF ONLY:

HAWP#_

APPLICANT:

Name:			-mail:					
Address:			City:	Zip:				
Daytime Phone: _			ax Account No.:					
AGENT/CONTACT	T (if applicable	e):						
Name:		E	E-mail:					
Address:			Dity:	Zip:				
Daytime Phone: _			Contractor Registration No.:					
LOCATION OF BU	JILDING/PREM	IISE: MIHP # of Historic	Property					
map of the easen Are other Plannin	nent, and docur g and/or Hearir Variance, Recor ormation.	mentation from the Easeing Examiner Approvals /rd Plat, etc.?) If YES, incl	ment Holder suppo Reviews Required a ude information on	as part of this Application?				
Town/City:		Nearest Cross	Street:					
Lot:	Block:	Subdivision:	Parcel:	_				
for proposed we be accepted for New Const Addition Demolition Grading/Ex I hereby certify the	ork are submit review. Check ruction kcavation hat I have the a d that the const	Deck/Porch Fence Hardscape/Landsca Roof uthority to make the fore	on. Incomplete A Shed, Solar Tree r ape Windo Other egoing application, plans reviewed and	pplications will not /Garage/Accessory Structure				

Signature of owner or authorized agent


HAWP APPLICATION: MAILING ADDRESSES FOR NOTIFING [Owner, Owner's Agent, Adjacent and Confronting Property Owners] Owner's mailing address Owner's Agent's mailing address Adjacent and confronting Property Owners mailing addresses

Description of Property: Please describe the building and surrounding environment. Include information on significant structures, landscape features, or other significant features of the property:
Description of Work Proposed: Please give an overview of the work to be undertaken:

Work Item 1:	
Description of Current Condition:	Proposed Work:
Work Item 2:	
Description of Current Condition:	Proposed Work:
Work Item 3:	
Description of Current Condition:	Proposed Work:

HISTORIC AREA WORK PERMIT CHECKLIST OF APPLICATION REQUIREMENTS

	Required Attachments						
Proposed Work	I. Written Description	2. Site Plan	3. Plans/ Elevations	4. Material Specifications	5. Photographs	6. Tree Survey	7. Property Owner Addresses
New Construction	*	*	*	*	*	*	*
Additions/ Alterations	*	*	*	*	*	*	*
Demolition	*	*	*		*		*
Deck/Porch	*	*	*	*	*	*	*
Fence/Wall	*	*	*	*	*	*	*
Driveway/ Parking Area	*	*		*	*	*	*
Grading/Exc avation/Land scaing	*	*		*	*	*	*
Tree Removal	*	*		*	*	*	*
Siding/ Roof Changes	*	*	*	*	*		*
Window/ Door Changes	*	*	*	*	*		*
Masonry Repair/ Repoint	*	*	*	*	*		*
Signs	*	*	*	*	*		*

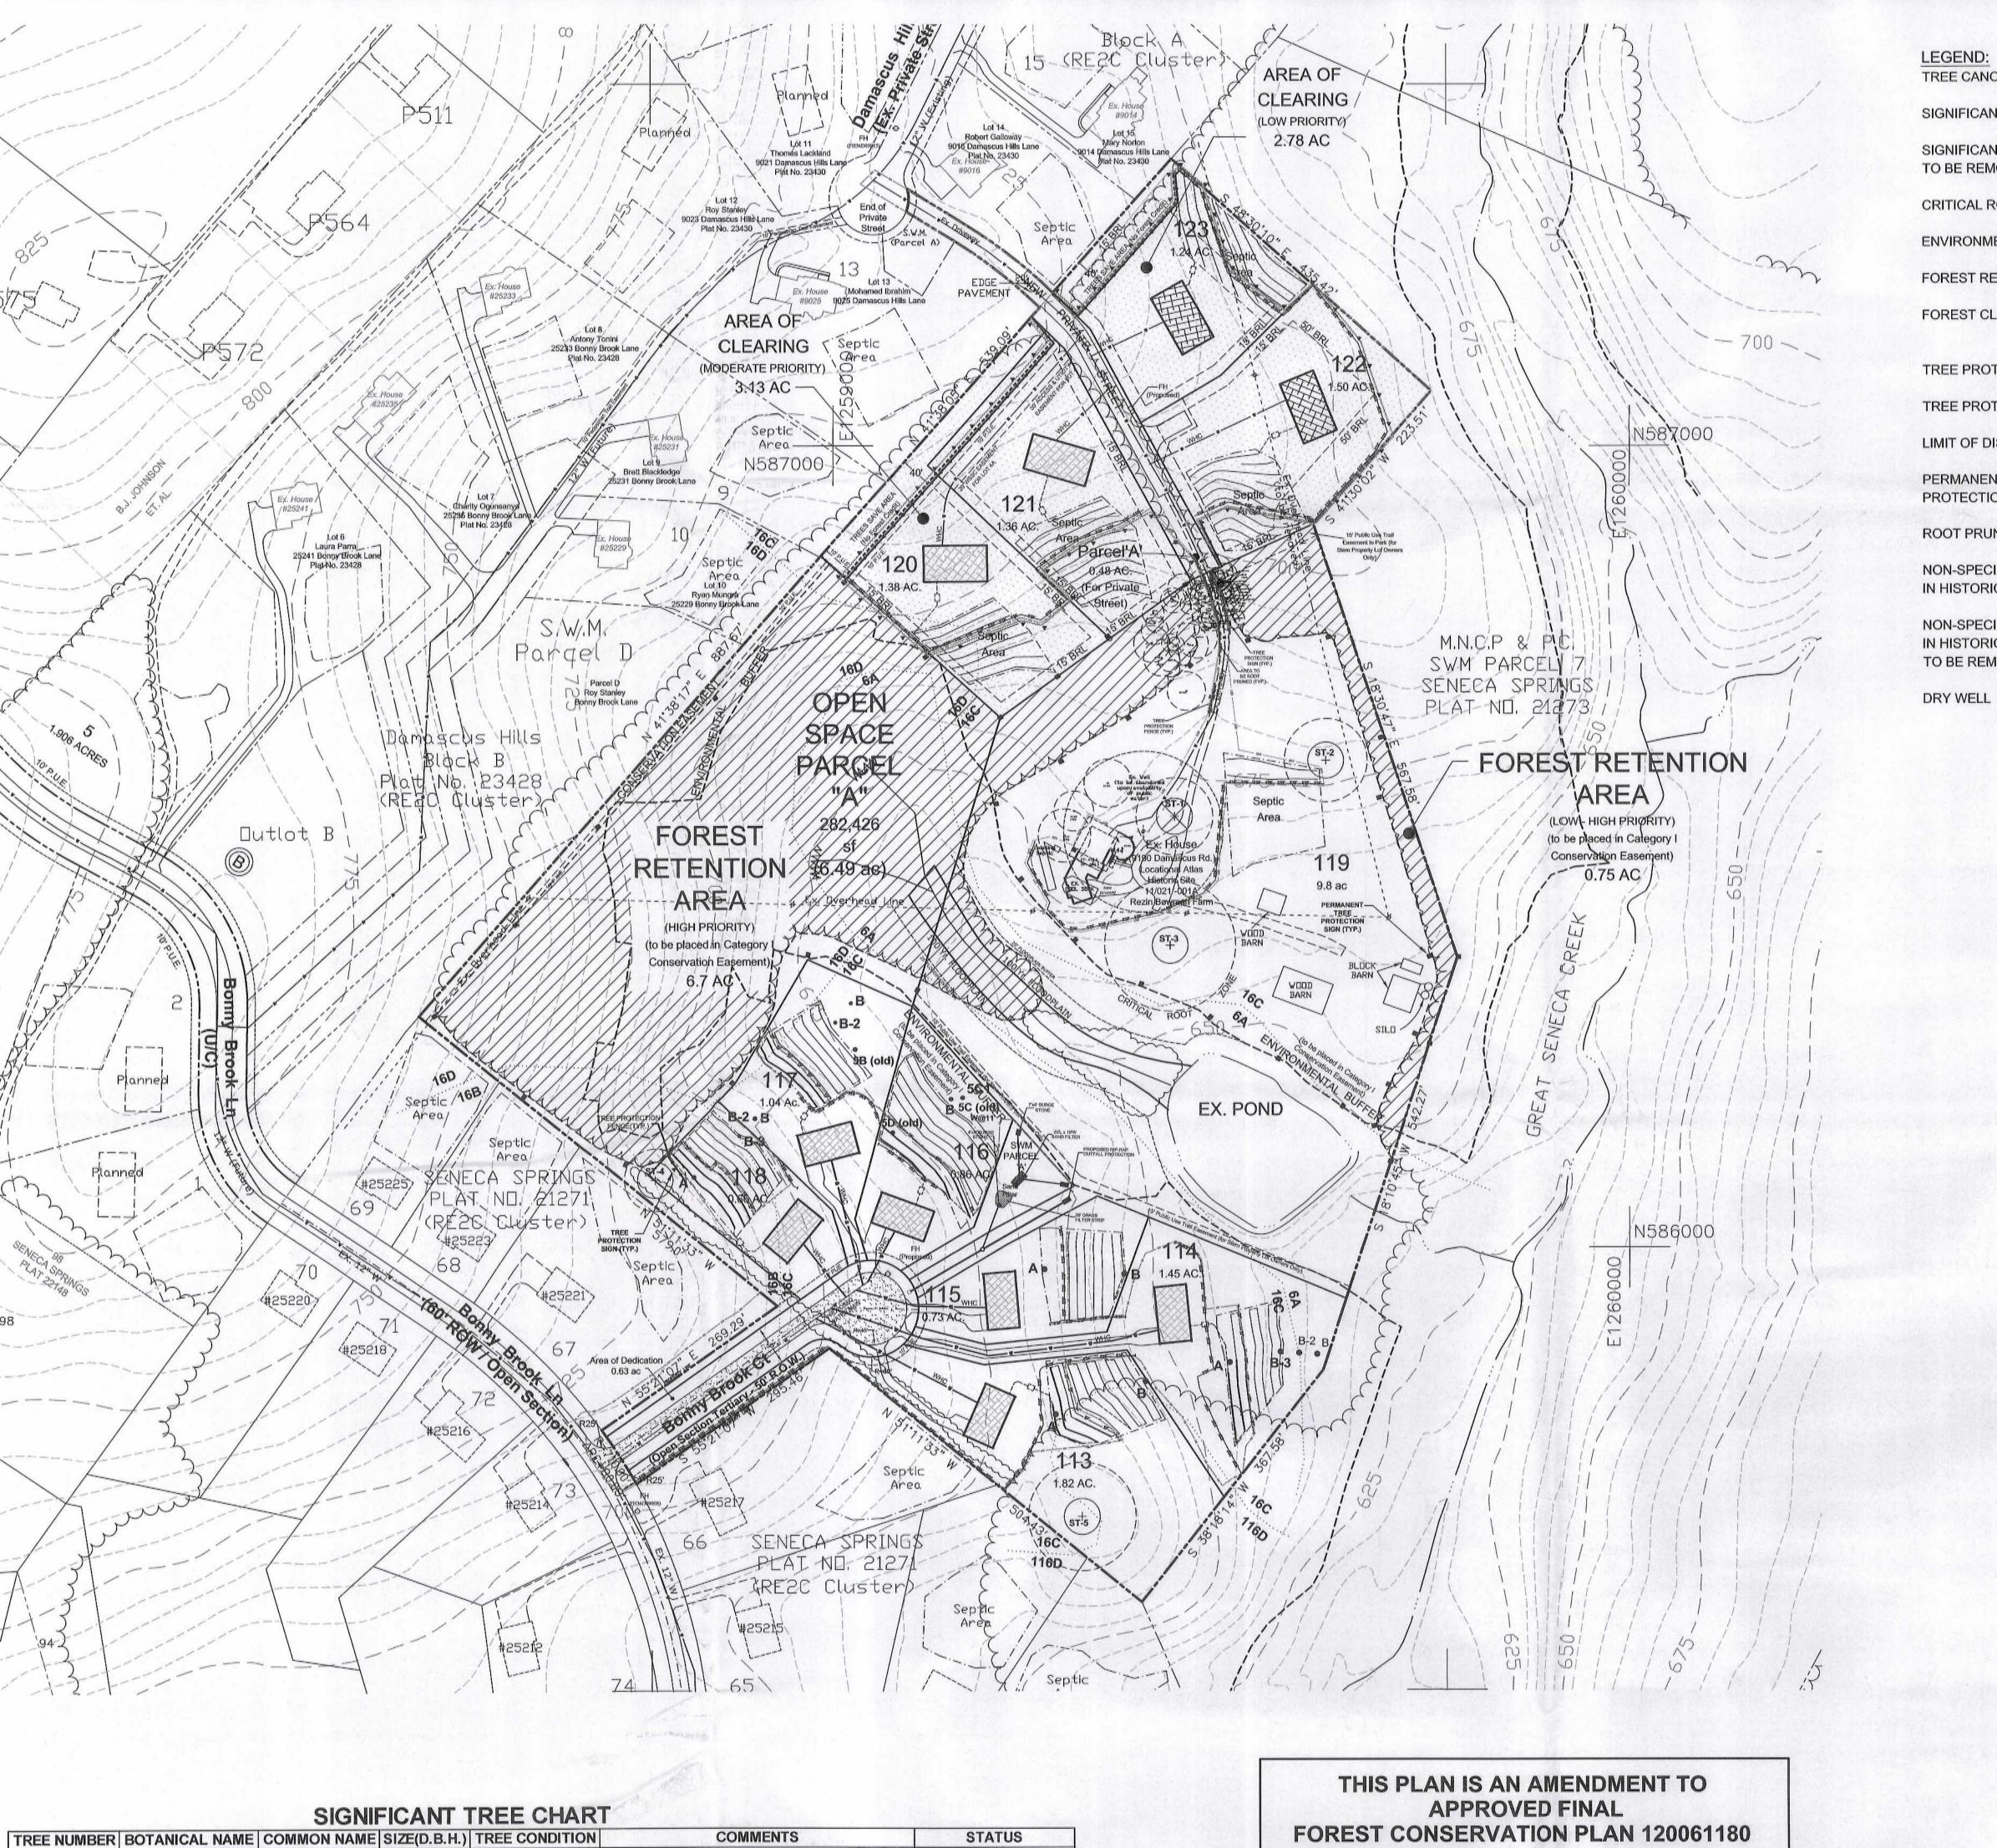

TREE CANOPY + ST-2 SIGNIFICANT TREE (★) ST-2 SIGNIFICANT TREE TO BE REMOVED CRITICAL ROOT ZONE _____ **ENVIRONMENTAL BUFFER** FOREST RETENTION AREA FOREST CLEARING AREA TREE PROTECTION SIGN TREE PROTECTION FENCE LIMIT OF DISTURBANCE PERMANENT TREE PROTECTION SIGN ~~~~~~ ROOT PRUNE $_{ imes}$ ST-A NON-SPECIMEN TREE IN HISTORIC SETTING \times ST-A NON-SPECIMEN TREE IN HISTORIC SETTING (TBR) TO BE REMOVED DRY WELL

NOTES:

1. AREA OF PROPERTY - 29.392 ACRES

2. EXISTING ZONING - RE2C

3. METHOD OF DEVELOPMENT PROPOSED - CLUSTER

4. MINIMUM LOT SIZE PERMITTED (Cluster) - 25,000 SF 5. NUMBER OF LOTS PERMITTED (@0.4 du/ac) - 11

6. NUMBER OF LOTS SHOWN - 11

7. SITE TO BE SERVED BY PUBLIC WATER / ON-SITE SEPTIC SYSTEMS

8. EXISTING SEWER & WATER SERVICE CATEGORIES: S-6, W-3 9. LOCATED IN GREAT SENECA CREEK WATERSHED

10. SITE LOCATED ON WSSC GRID SHEETS: 236NW09 / 235NW09

11. UTILITY SERVICE TO BE PROVIDED BY: Verizon, WSSC, Potomac Edison

FOREST CONSERVATION WORKSHEET

SENECA SPRINGS NET TRACT AREA: A. Total tract area ... 29.39 B. Land dedication acres (parks, county facility, etc.) ... 0.00 C. Land dedication for roads or utilities (not being constructed by this plan) .. 0.00 D. Area to remain in commercial agricultural production/use .

0.00 E. Other deductions (specify) 0.00 F. Net Tract Area .. 29.39 LAND USE CATEGORY: (from Trees Technical Manual) Input the number "1" under the appropriate land use, limit to only one entry. G. Afforestation Threshold . $0.20 \times F =$ 5.88 H. Conservation Threshold .. 7.35 $0.25 \times F =$ EXISTING FOREST COVER: I. Existing forest cover .. 13.36 J. Area of forest above afforestation threshold 7.48 K. Area of forest above conservation threshold= 6.01 BREAK EVEN POINT: L. Forest retention above threshold with no mitigation= 8.55 M. Clearing permitted without mitigation . 4.81 PROPOSED FOREST CLEARING: N. Total area of forest to be cleared . 5.91 O. Total area of forest to be retained . PLANTING REQUIREMENTS: P. Reforestation for clearing above conservation threshold= Q. Reforestation for clearing below conservation threshold= R. Credit for retention above conservation threshold . Total reforestation required . Total afforestation required U. Credit for landscaping (may not exceed 20% of "S")= V. Total reforestation and afforestation required ..



THE MARYLAND-NATIONAL CAPITAL PARK AND PLANNING COMMISSION

Final Forest Conservation Plan


Plan No. 12006/18A

DEVELOPER'S CERTIFICATE The Undersigned agrees to execute all the features of the Approved Final Forest Conservation Plan No. 12006118A including, financial bonding, forest planting, maintenance, and all other applicable agreements. Seneca Ridge Development LLC Developer's Name: Printed Company Name

Contact Person or Owner: Eric Anderson PO Box 101525 Arlington, VA 22210

Phone and Email:

PREPARED FOR: SENECA RIDGE DEVELOPMENT LLC PO BOX 101525 **ARLINGTON, VA 22210** 202-812-1034

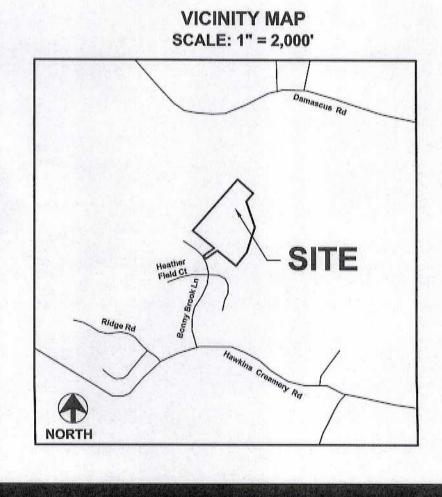

								FINAL F	OREST CO	NSERVATIO	ON PLAN									
ACREAGE OF TRACT	ACREAGE OF TRACT REMAINING IN AGRICULTURE USE	ACREAGE OF ROAD AND UTILITY R.O.W. NOT TO BE IMPROVED	ACREAGE OF EXISTING FOREST RETE	ESI	JSE CATEGORY	CONSERVATION THRESHOLD	AFFORESTATION THRESHOLD	FOREST WITHIN WETLANDS TO BE RETAINED	FOREST WITHIN WETLANDS TO BE CLEARED	FOREST WITHIN WETLANDS TO BE PLANTED	FOREST WITHIN 100-YEAR FLOODPLAIN TO BE RETAINED	FOREST WITHIN 100-YEAR FLOODPLAIN TO BE CLEARED	FOREST WITHIN 100-YEAR FLOODPLAIN TO BE PLANTED	FOREST WITHIN STREAM BUFFER TO BE RETAINED	FOREST WITHIN STREAM BUFFER TO BE CLEARED		FOREST WITHIN PRIORITY AREAS TO BE CLEARED	FOREST WITHIN PRIORITY AREAS TO BE PLANTED	STREAM BUFFER- LINEAR FEET	STREAM BUFFER- AVERAGE WIDTH

0.0 AC

0.00 AC 0.40 AC 0.00 AC

AMENDMENT # 12006118A: TO CONVERT THE

PREVIOUSLY APPROVED OUTLOT INTO 4

LOTS, BRINGING THE TOTAL LOTS TO 11.

1.30 AC

0.00 AC

0.00 AC

4.14 AC

0.00 AC

0.00 AC

0.00 AC

To be removed

To be retained

To be retained

To be retained

To be retained

Trunk covered with Poison Ivy, decay in trunk, dead limbs

and decay in canopy

Dead limbs in canopy

Multi-stem

25% = 7.32 AC 20%= 5.85 AC

Poor - Dead

Good

Good

Good

Good

MEDIUM DENSITY

Robinia pseudoacacia

Acer rubrum

Liriodendron tulipifera

Quercus alba

Red Maple

White Oak

13.36 AC

54.8"

45.0"

Sheet 1 of 5


Revisions

06/30/2015 01/08/2016

07/03/2017

11/01/2017

SEN

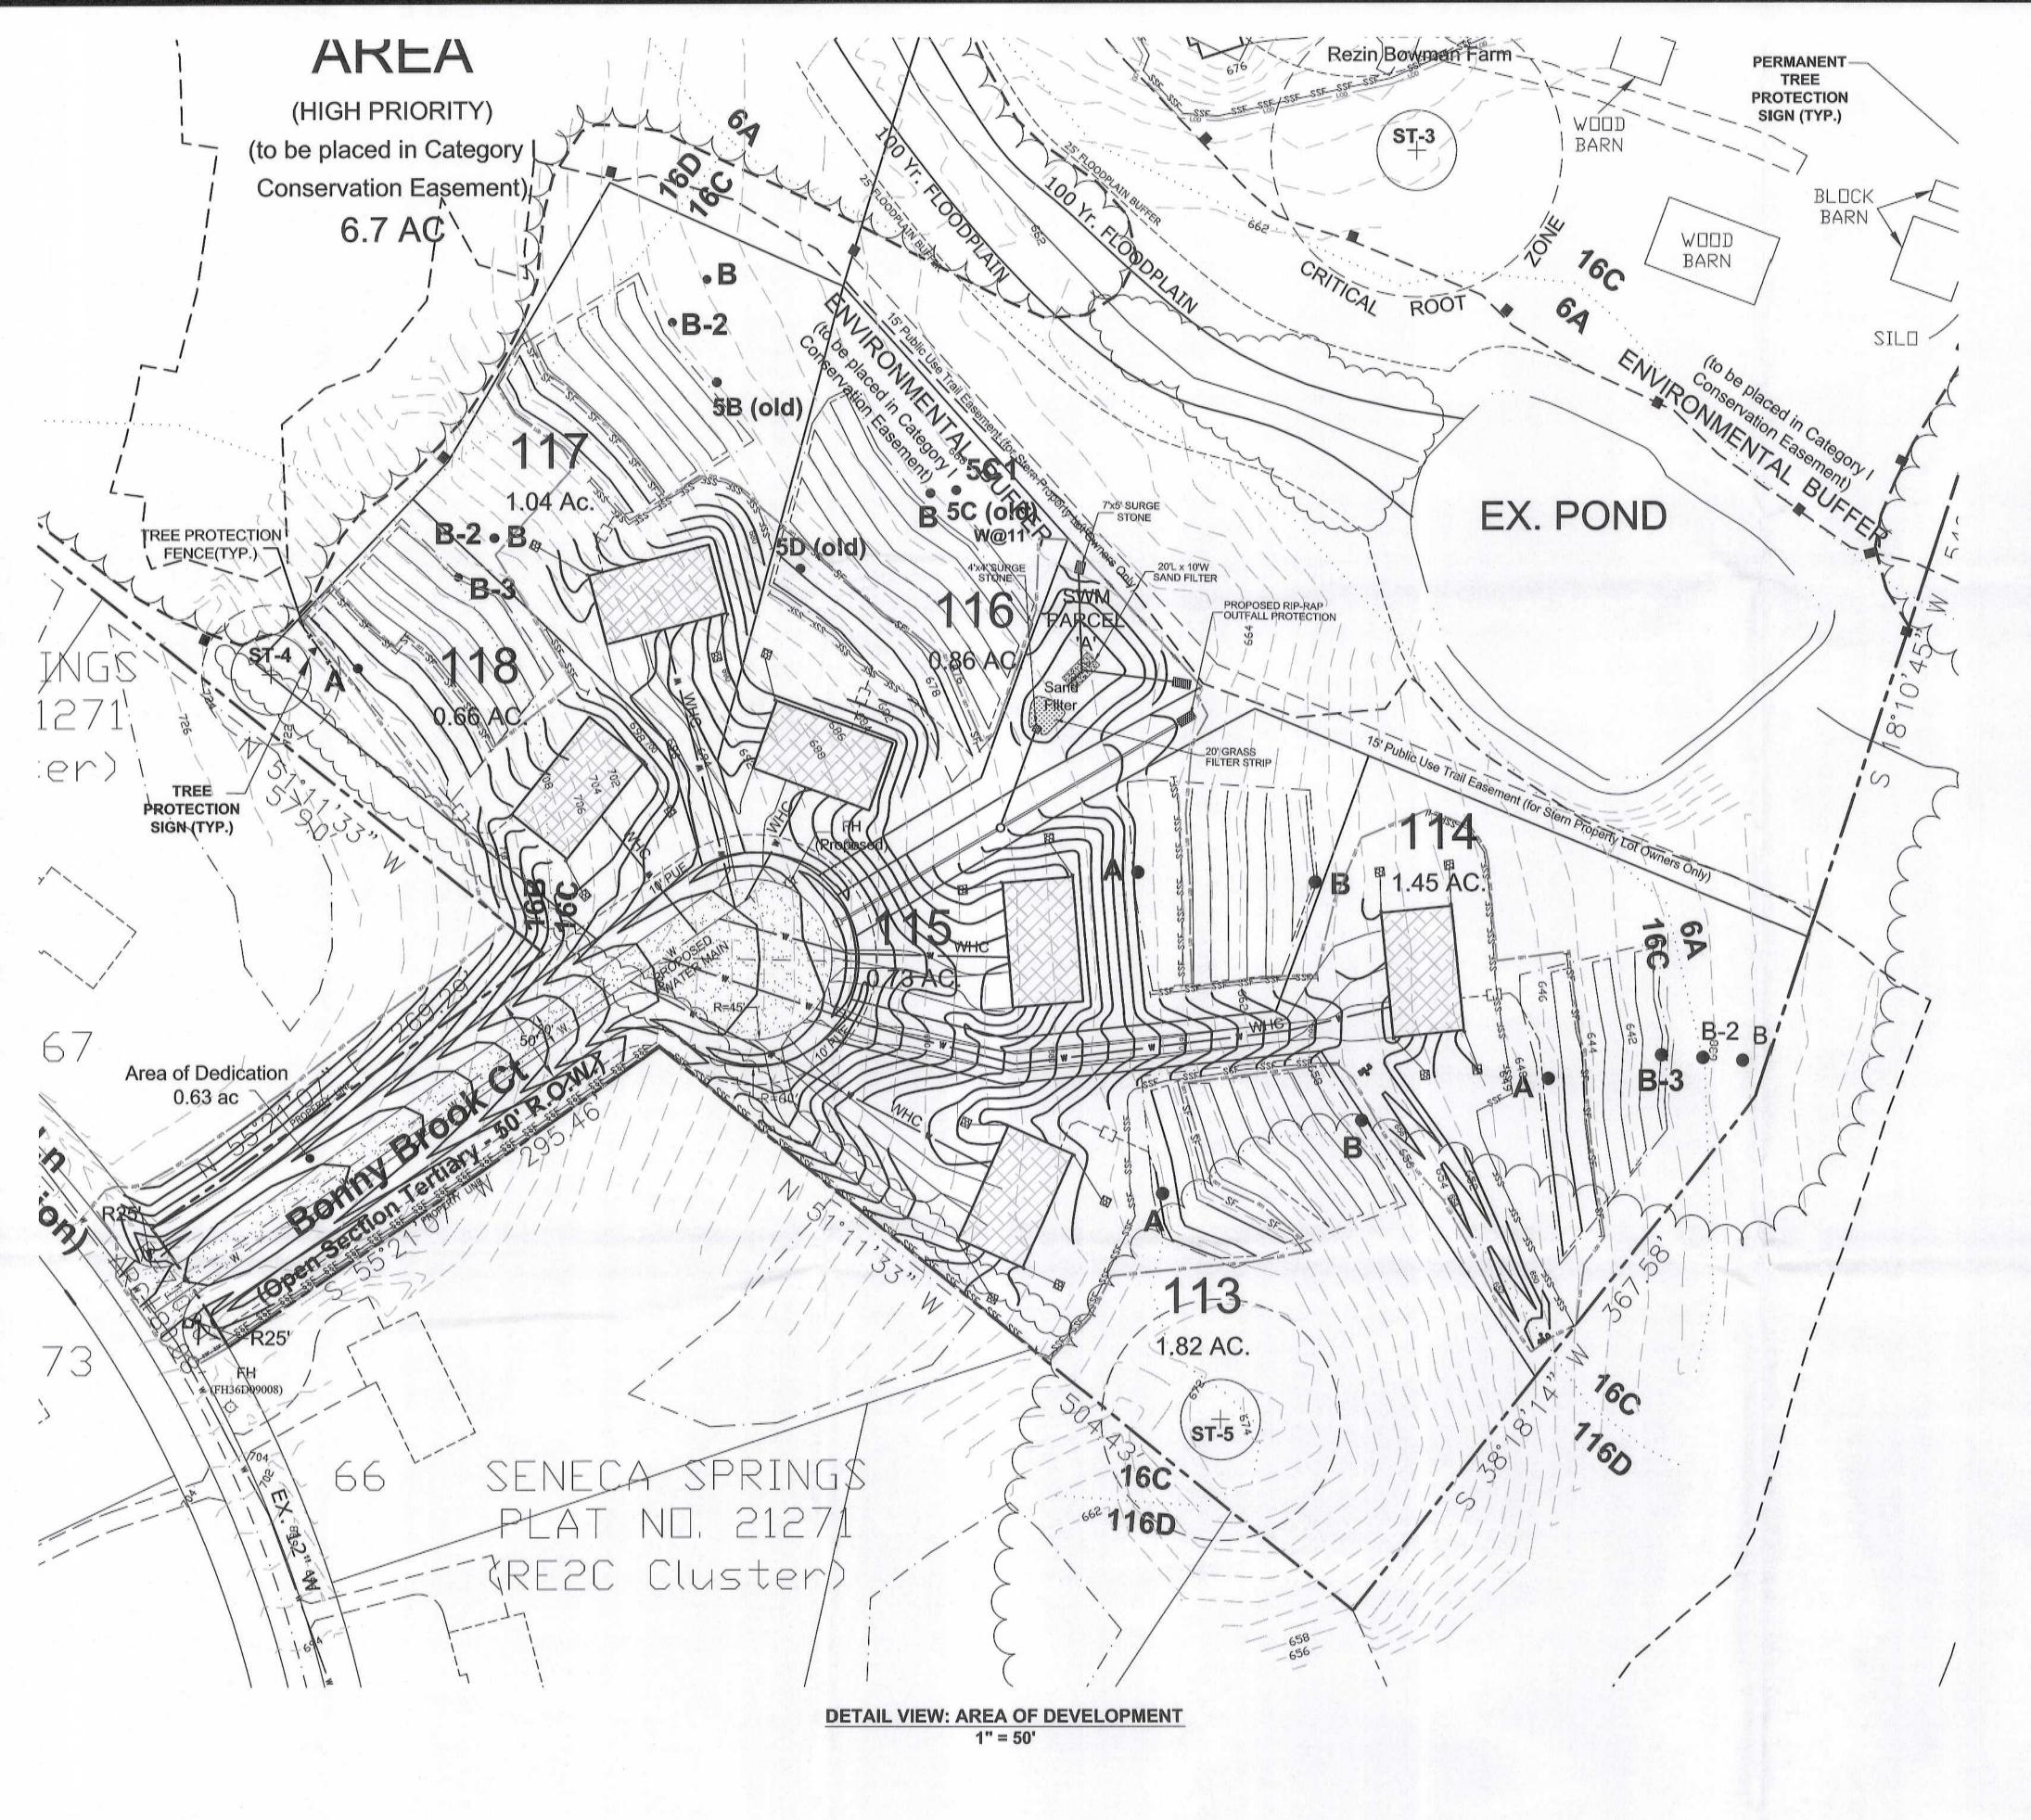

Sequence of Events for Property Owners Required to Comply With Forest Conservation and/ or **Tree-Save Plans**

1. An on-site pre-construction meeting is required after the limits of disturbance have been staked and flagged, but before any clearing or grading begins. The property owner shall contact the Montgomery County Planning Department inspection staff before construction to verify the limits of disturbance and discuss tree protection and tree care measures. The developer's representative, construction superintendent, ISA certified arborist or MD license tree expert that will implement the tree protection measures, forest conservation inspector, and Department of Permitting Services (DPS) sediment control inspector should attend this pre-construction meeting.

- 2. No clearing or grading shall begin before stress-reduction measures have been implemented. Appropriate measures may include, but are not limited to:
- a. Root pruning
- b. Crown Reduction or pruning
- c. Watering d. Fertilizing
- e. Vertical mulching f. Root aeration matting
- Measures not specified on the forest conservation plan may be required as determined by the M-NCPPC inspector in coordination with the arborist.

3. A Maryland licensed tree expert or an International Society of Arboriculture certified arborist must perform all stress reduction measures. Documentation of stress reduction measures must be either observed by the forest conservation inspector or sent to the inspector at 8787 Georgia Avenue, Silver Spring, MD 20910. The forest conservation inspector will determine the exact method to convey the stress reductions measures during the pre-construction meeting.

- 4. Temporary tree protection devices shall be installed per the Forest Conservation Plan/Tree Save Plan and prior to any construction activities. Tree protection fencing locations should be staked prior to the pre-construction meeting. The forest conservation inspector, in coordination with the DPS sediment control inspector, may make field adjustments to increase the survivability of trees and forest shown as saved on the approved plan. Temporary tree protect devices may include:
- a. Chain link fence (four feet high)
- b. Super silt fence with wire strung between the support poles (minimum 4 feet high)
- c. 14 gauge 2 inch x 4 inch welded wire fencing supported by steel T-bar posts (minimum 4 feet high) with high visibility flagging.
- 5. Temporary protection devices shall be maintained and installed by the contractor for the duration of construction project and must not be altered without prior approval from the forest conservation inspector. No equipment, trucks, materials, or debris may be stored within the tree protection fence areas during the entire construction project. No vehicle or equipment access to the fenced area will be permitted. Tree protection shall not be removed without prior approval of the forest conservation inspector.
- 6. Forest retention area signs shall be installed as required by the forest conservation inspector, or as shown approved plan.
- 7. Long-term protection devices will be installed per the Forest Conservation Plan/Tree Save Plan and attached details. Installation will occur at the appropriate time during the construction project. Refer to the plan drawing for long-term protection measures to be

During Construction

8. Periodic inspections by the forest conservation inspector will occur during the construction project. Corrections and repairs to all tree protection devices, as determined by the forest conservation inspector, must be made within the timeframe established by the inspector. Post-Construction

9. After construction is completed, an inspection shall be requested. Corrective measures

- a. Removal and replacement of dead and dying trees
- b. Pruning of dead or declining limbs c. Soil aeration
- d. Fertilization
- e. Watering
- f. Wound repair g. Clean up of retention areas
- 10. After inspection and completion of corrective measures have been undertaken, all temporary protection devices shall be removed from the site. No additional grading, sodding, or burial may take place.

Inspections:

All field inspections must be requested by the applicant. Inspections must be conducted as follows:

Tree Save Plans and Forest Conservation Plans without Planting Requirements

1) After the limits of disturbance have been staked and flagged, but before any clearing or grading begins.

2) After necessary stress reduction measures have been completed and the protection measures have been installed, but before any clearing or grading

3) After completion of all construction activities to determine the level of compliance with the provisions of the forest conservation plan;

Additional Requirements for Plans with Planting Requirements

4) Before the start of any required reforestation and afforestation planting 5) After required reforestation and afforestation planting has been completed to verify that the planting is acceptable and prior to the start of the maintenance 6) At the end of the maintenance period to determine the level of compliance with the provisions of the planting plan and, if appropriate, release of the performance bond.

> LEGEND: \sim TREE CANOPY + ST-2 SIGNIFICANT TREE SIGNIFICANT TREE ⊛ ST-2 TO BE REMOVED CRITICAL ROOT ZONE _____ **ENVIRONMENTAL BUFFER** FOREST RETENTION AREA FOREST CLEARING AREA TREE PROTECTION SIGN TREE PROTECTION FENCE X LOD ____ LIMIT OF DISTURBANCE PERMANENT TREE PROTECTION SIGN ~~~~~~ ROOT PRUNE $_{ imes}$ ST-A NON-SPECIMEN TREE IN HISTORIC SETTING imes ST-A NON-SPECIMEN TREE IN HISTORIC SETTING (TBR) TO BE REMOVED DRY WELL THE MARYLAND-NATIONAL CAPITAL PARK AND PLANNING COMMISSION Final Forest Conservation Plan APPROVAL Plan No. 1200611814


Conservation Plan No.	es to execute all the features of the Approved Final Fores 12006118A including, financial bonding nance, and all other applicable agreements.
Developer's Name:	Seneca Ridge Development LLC
	Printed Company Name
Contact Person or Own	ner: Eric Anderson
	Printed Name
Address:	PO Box 101525 Arlington, VA 22210
Phone and Email:	202-812-1034
Signature:	2. AAL

THIS PLAN IS AN AMENDMENT TO APPROVED FINAL **FOREST CONSERVATION PLAN 120061180**

AMENDMENT # 12006118A: TO CONVERT THE PREVIOUSLY APPROVED OUTLOT INTO 4 LOTS, BRINGING THE TOTAL LOTS TO 11.

Revisions 06/30/2015 01/08/2016 07/03/2017 11/01/2017


Sheet 2 of 5

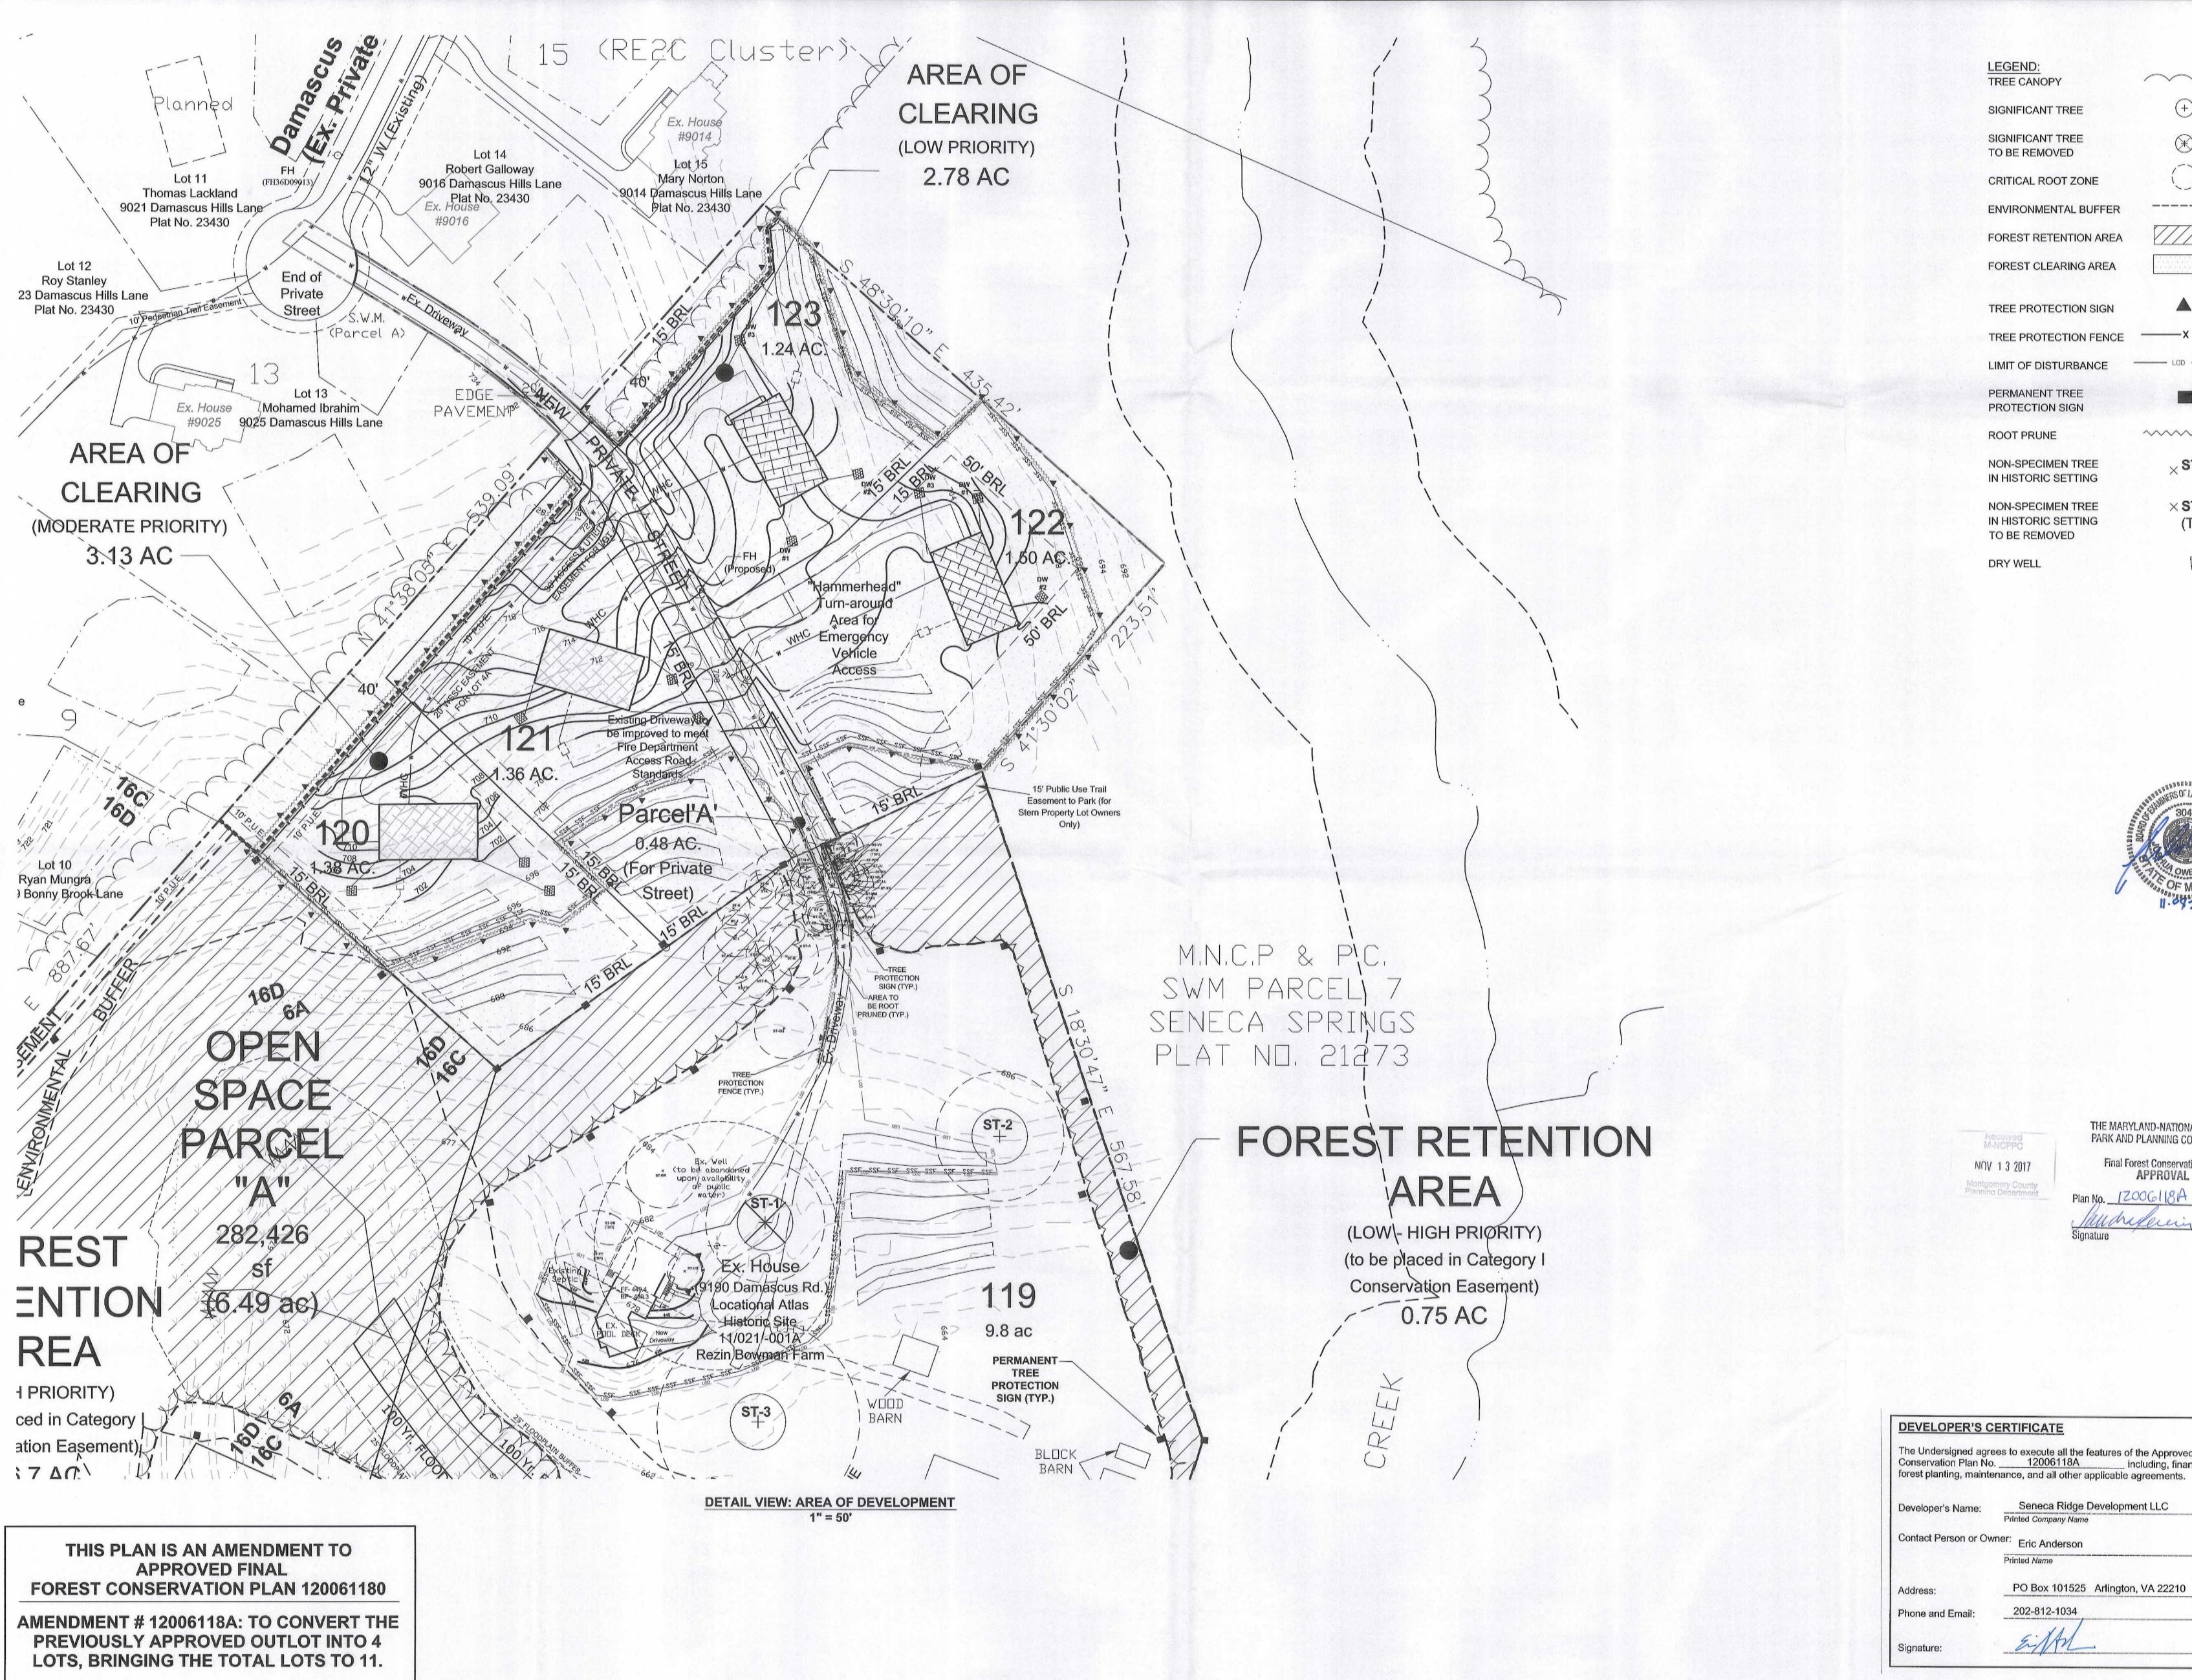

LEGEND: TREE CANOPY

 \sim + ST-2

11/01/2017

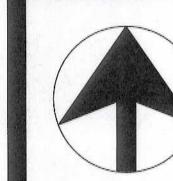

Sheet 3 of 5

06/30/2015 01/08/2016 07/03/2017

⊛ ST-2

~~~~~~~

TREE PROTECTION SIGN

TREE PROTECTION FENCE

PERMANENT TREE

**ROOT PRUNE** 

imes ST-A NON-SPECIMEN TREE IN HISTORIC SETTING

NON-SPECIMEN TREE IN HISTORIC SETTING TO BE REMOVED

imesST-A (TBR)

**DRY WELL** 

[23]


Final Forest Conservation Plan APPROVAL

Plan No. 120061181A

DEVELOPER'S CERTIFICATE

The Undersigned agrees to execute all the features of the Approved Final Forest Conservation Plan No. \_\_\_\_\_12006118A \_\_\_\_\_ including, financial bonding, forest planting, maintenance, and all other applicable agreements. Seneca Ridge Development LLC

Contact Person or Owner: Eric Anderson Printed Name

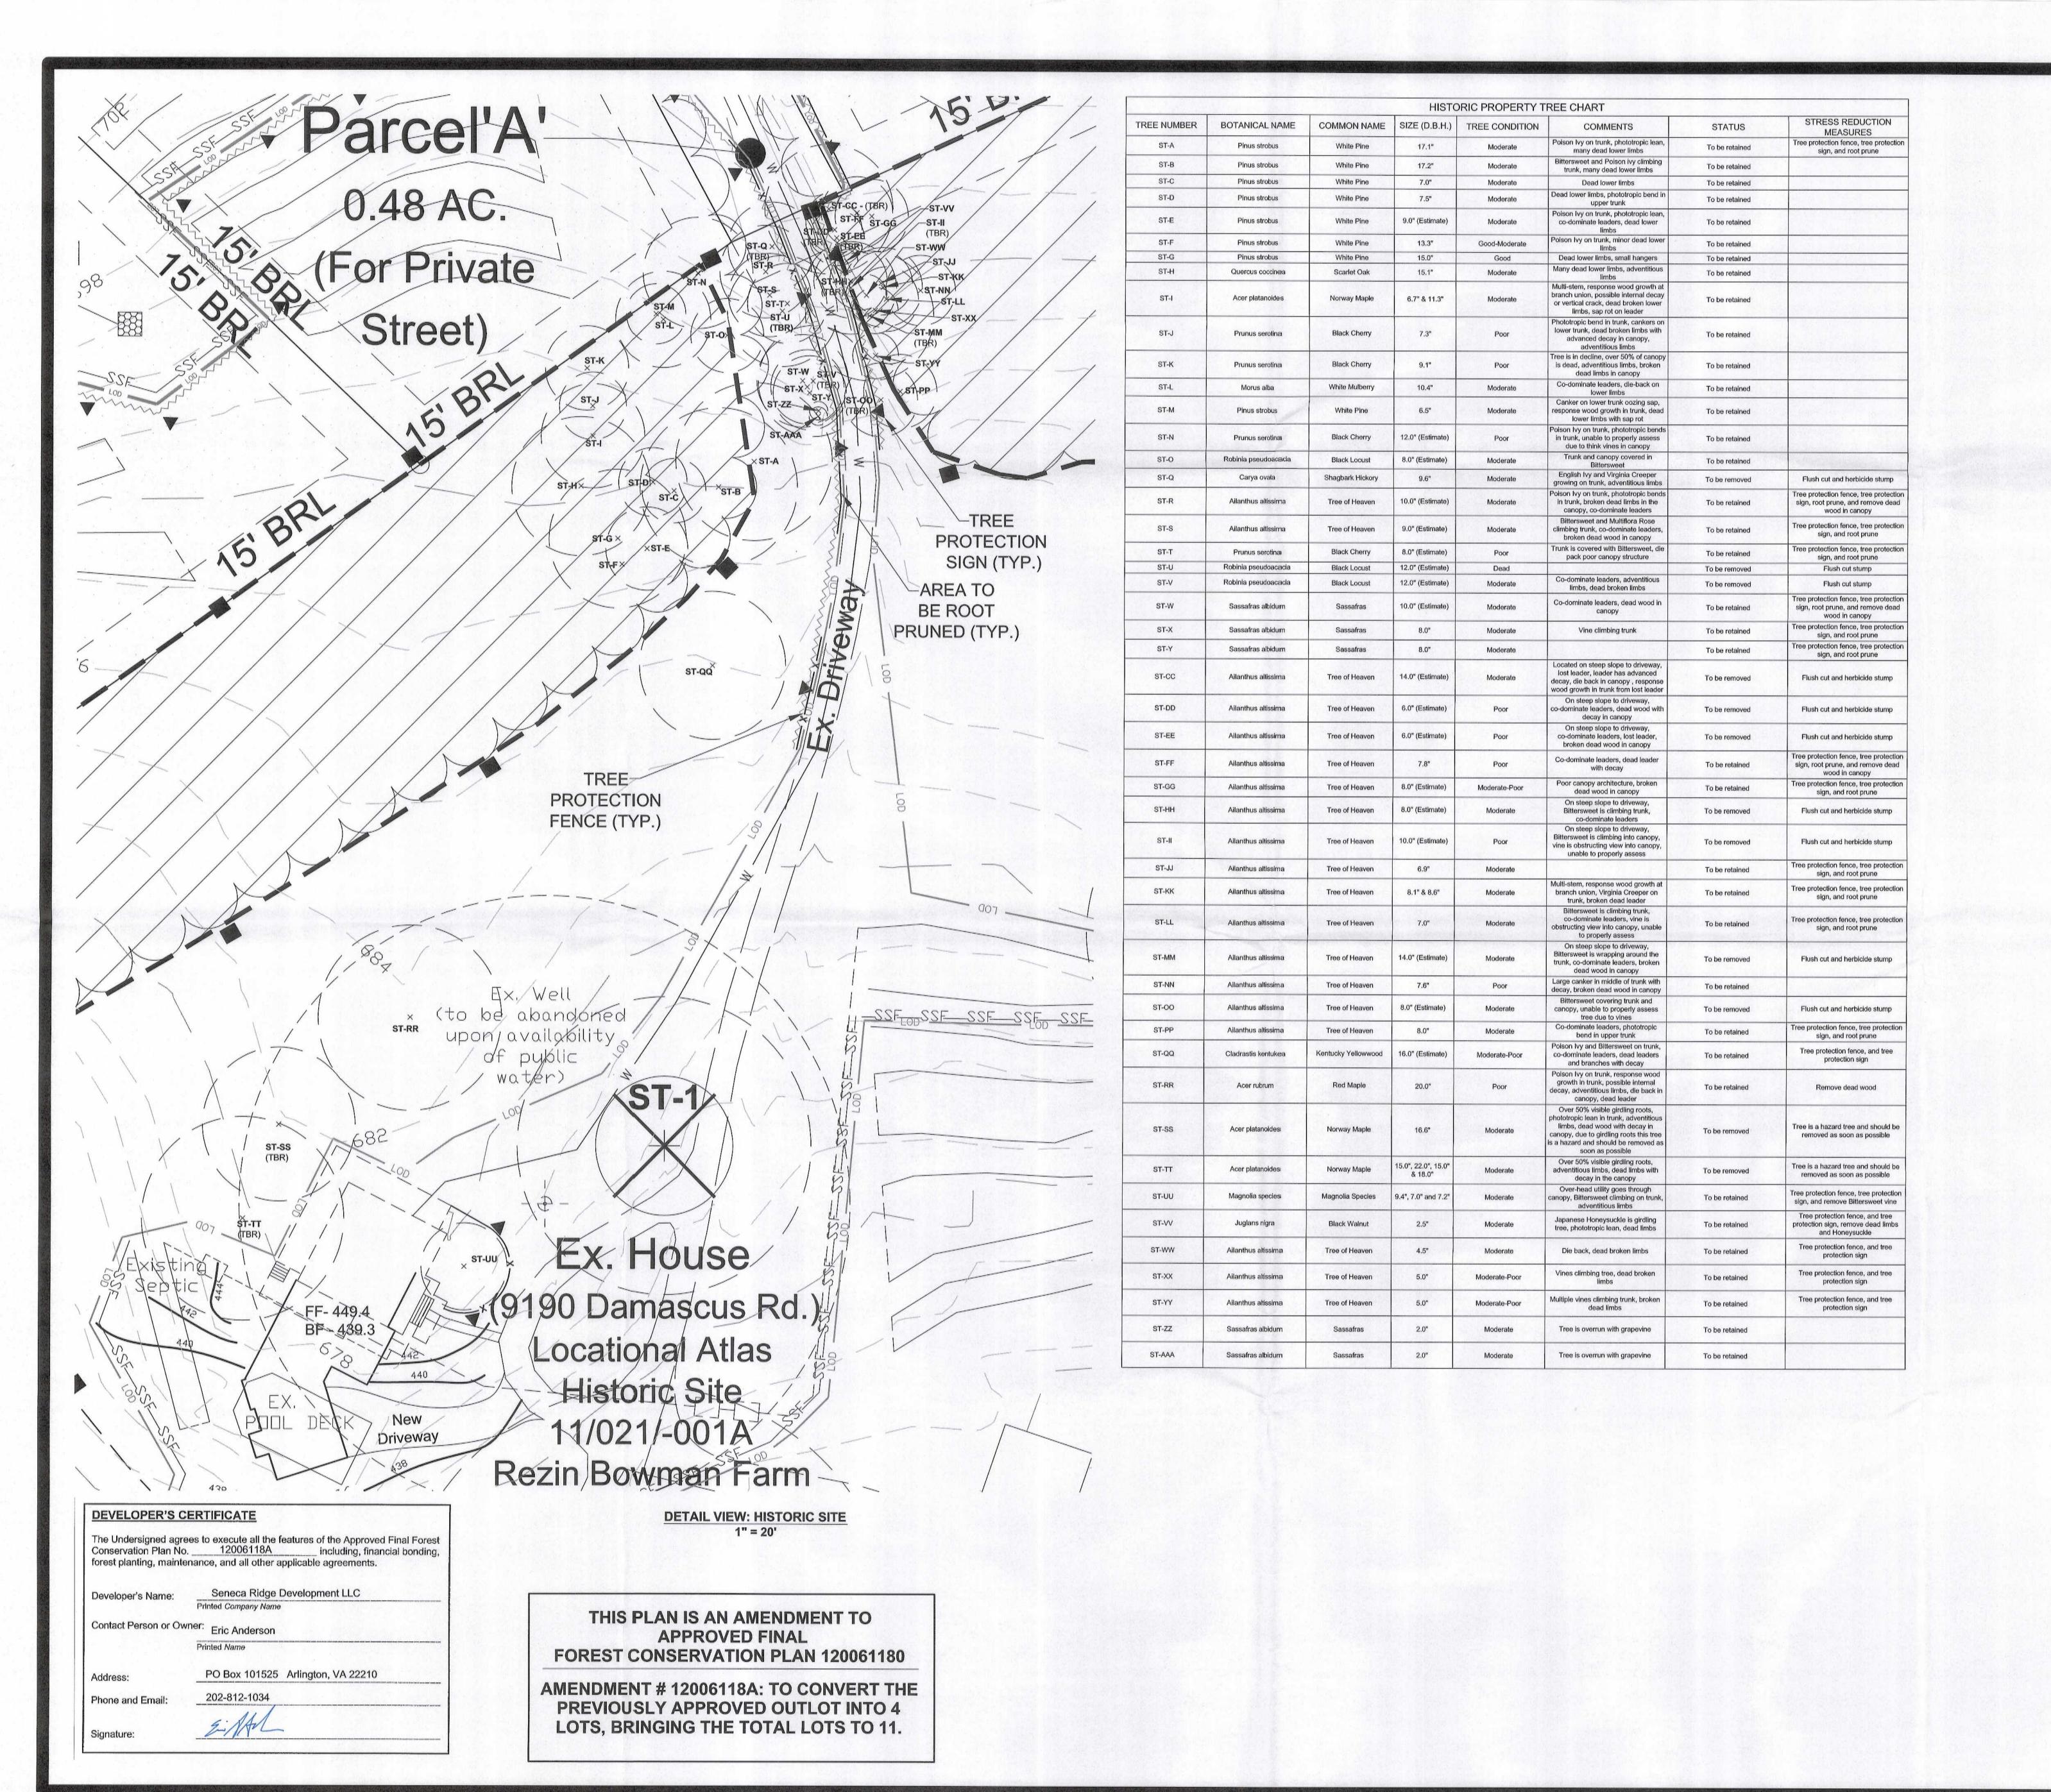

LEGEND:

SIGNIFICANT TREE

SIGNIFICANT TREE

CRITICAL ROOT ZONE

ENVIRONMENTAL BUFFER

FOREST RETENTION AREA

FOREST CLEARING AREA

TO BE REMOVED

TREE CANOPY

+ ST-2

06/30/2015 01/08/2016

07/03/2017 11/01/2017

Sheet 4 of 5 Revisions

\_\_\_\_\_

ST-2

TREE PROTECTION SIGN TREE PROTECTION FENCE

LIMIT OF DISTURBANCE

\_\_\_\_ LOD \_\_\_\_

~~~~~~ ROOT PRUNE NON-SPECIMEN TREE

 \times ST-A IN HISTORIC SETTING

IN HISTORIC SETTING TO BE REMOVED

DRY WELL

NON-SPECIMEN TREE

PERMANENT TREE

PROTECTION SIGN

[53]

(TBR)

imes ST-A



M-NCPPC "OV 1 3 2017

Z

THE MARYLAND-NATIONAL CAPITAL PARK AND PLANNING COMMISSION Final Forest Conservation Plan APPROVAL

Plan No. 17006118A


Prop ntgo


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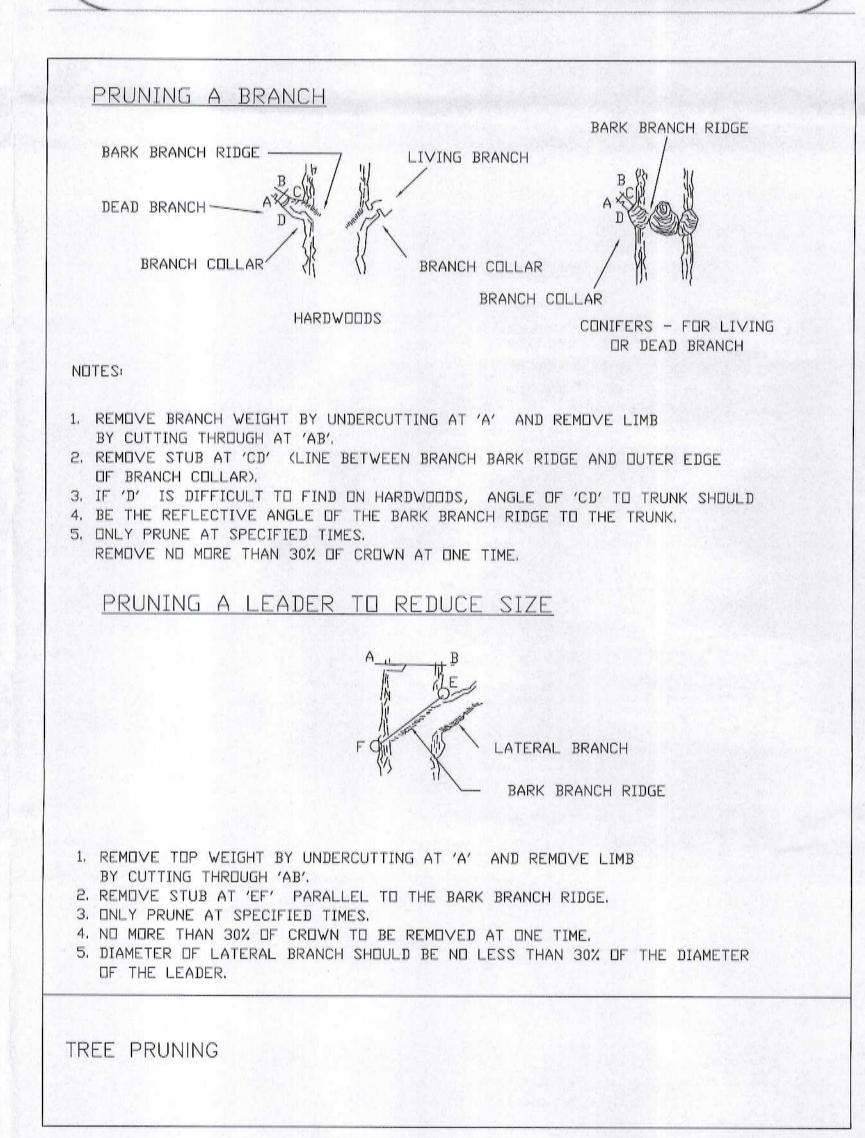
> NO DUMPING NO MOTORIZED VEHICLES


M-NCPPC **Environmental Planning**

© THE TREE COMPANY CATONSVILLE, MARYLAND PH, (410) 788-7277 www.lhetreecompany.com




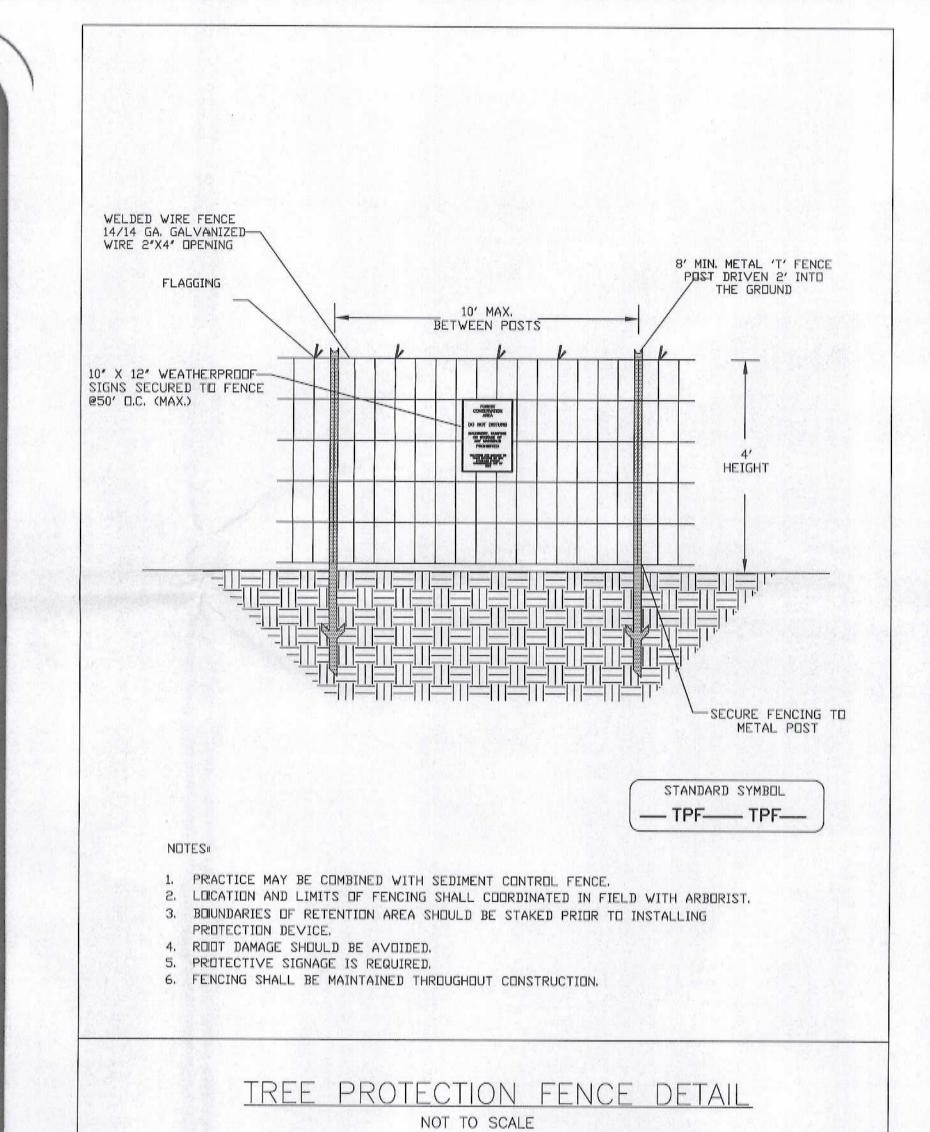

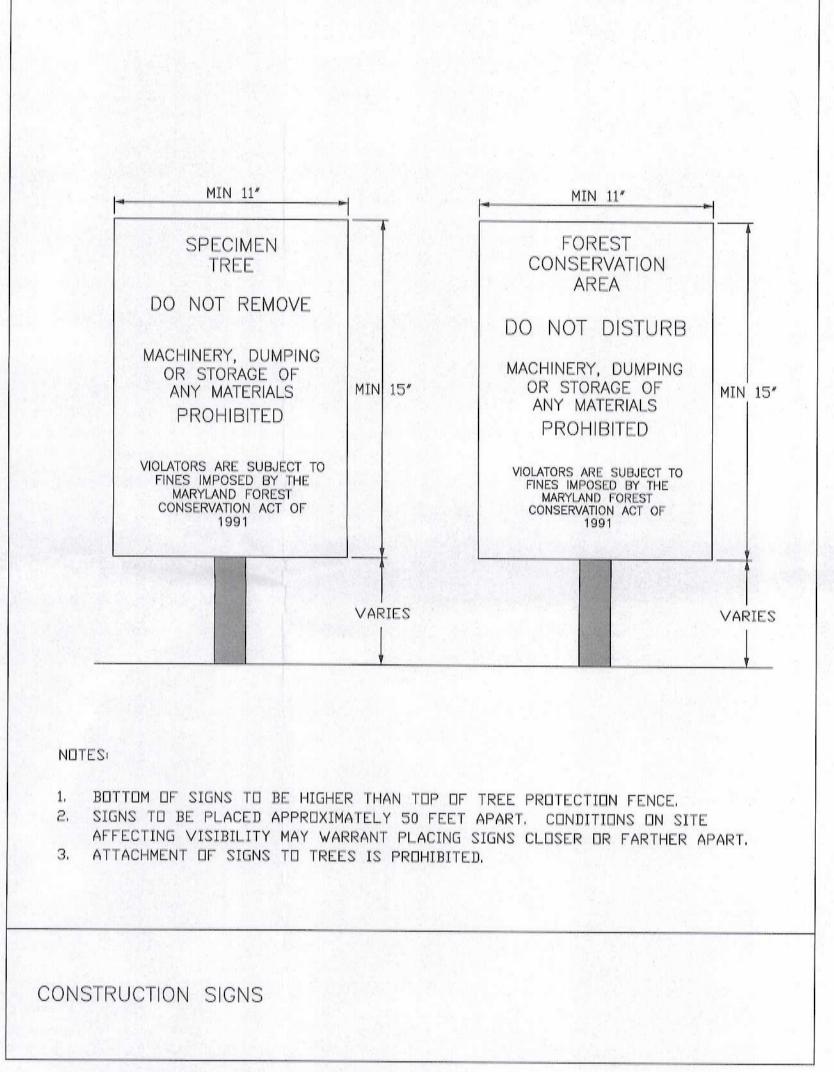

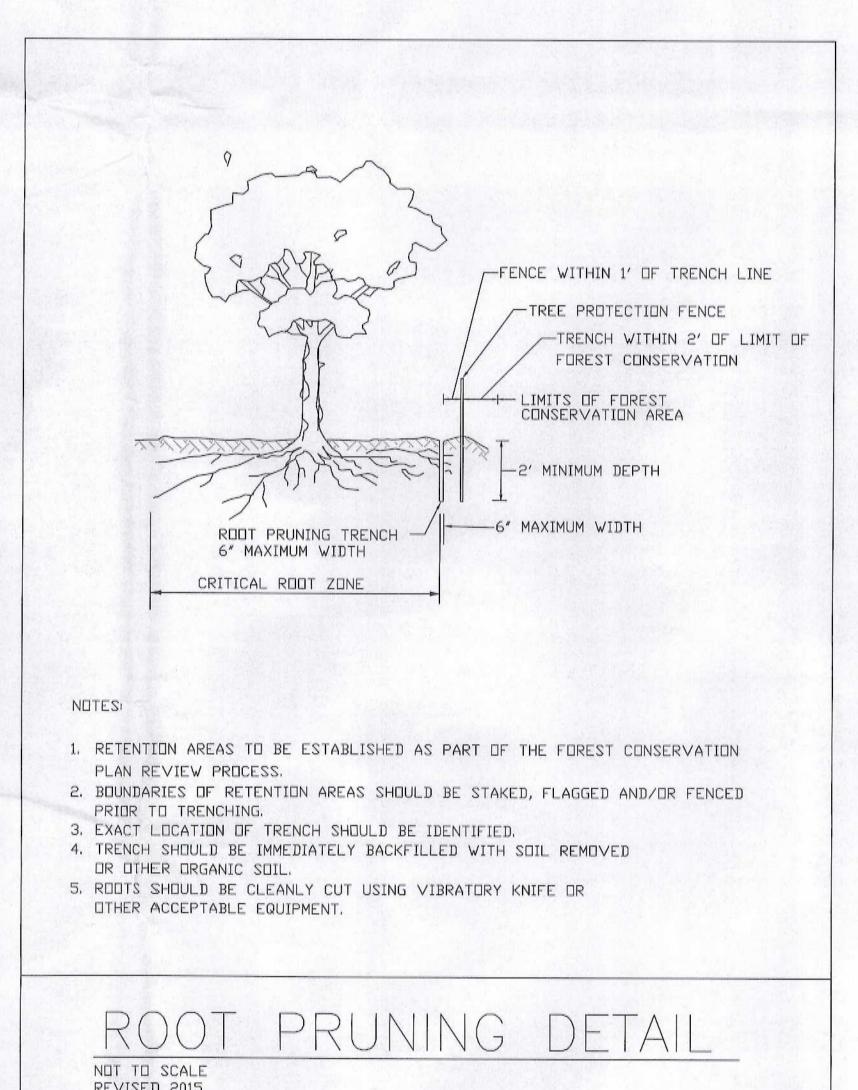

REVISED 2015

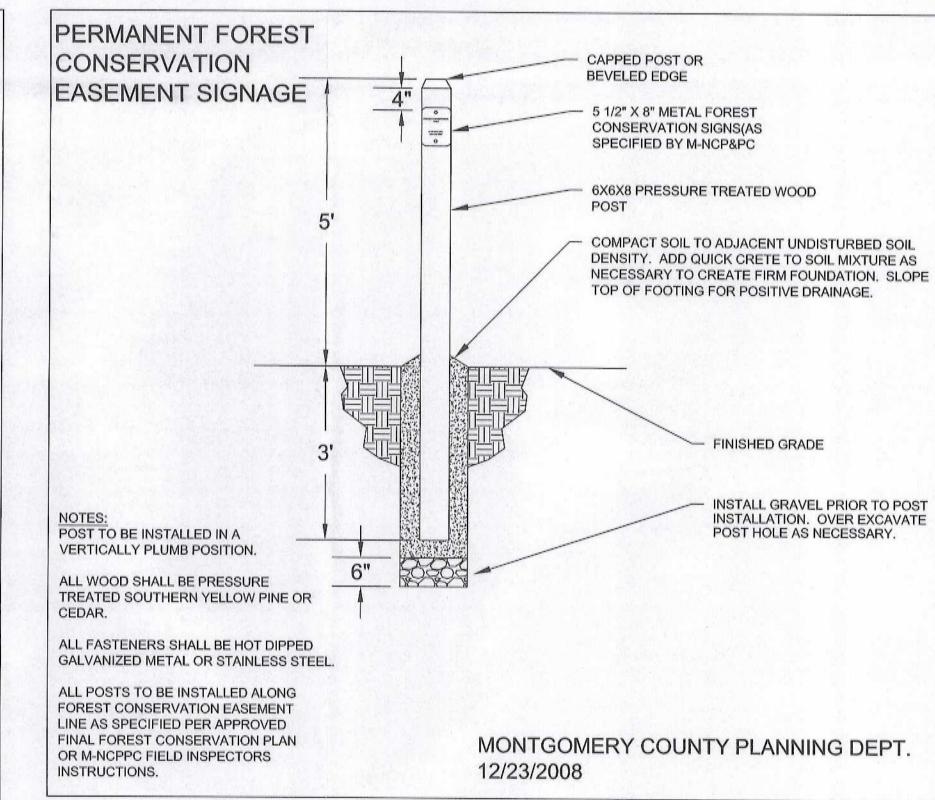





he Undersigned agrees to execute all the features of the Approved Final Forest Conservation Plan No. 12006118A including, financial bonding, forest planting, maintenance, and all other applicable agreements. Seneca Ridge Development LLC PO Box 101525 Arlington, VA 22210

Address: 202-812-1034 Phone and Email:

Contact Person or Owner: Eric Anderson

DEVELOPER'S CERTIFICATE

Signature:

Developer's Name:

Printed Company Name

Printed Name

THE MARYLAND-NATIONAL CAPITAL PARK AND PLANNING COMMISSION

Final Forest Conservation Plan APPROVAL

Plan No. 12006118 A

THIS PLAN IS AN AMENDMENT TO APPROVED FINAL **FOREST CONSERVATION PLAN 120061180**

AMENDMENT # 12006118A: TO CONVERT THE PREVIOUSLY APPROVED OUTLOT INTO 4 LOTS, BRINGING THE TOTAL LOTS TO 11.

06/30/2015 01/08/2016 07/03/2017 11/01/2017

Sheet 5 of 5 Revisions

rop Mo



heritage homesite

Dan and Allie Ferenczy 907-750-8306 Dan 713-376-6603 Allie daniel.ferenczy@gmail.com allie.ferenczy@gmail.com

9220 Damascus Hills Lane, Damascus MD 28702

NOTES

- Typical interior wall construction: 2x4 studs @ 16" O.C. with sheetrock finish Typical exterior wall construction: 2.1. Rockwool influence around framing

- Typical ceiling finish:
 3.1. exposed floor framing
 3.2. exposed underside of 2x subfloor

CZY HOME ane | Damascus, MD 20882 EVELOPMENT FEREN(9220 Damascus Hills La DESIGN D

100% DESIGN DEVELOPMENT


SHEET TITLE

BUILDING PLANS: FIRST FLOOR

DRAWN BY:

SCALE: 1/4"=1'-0" DATE:

A-1.1

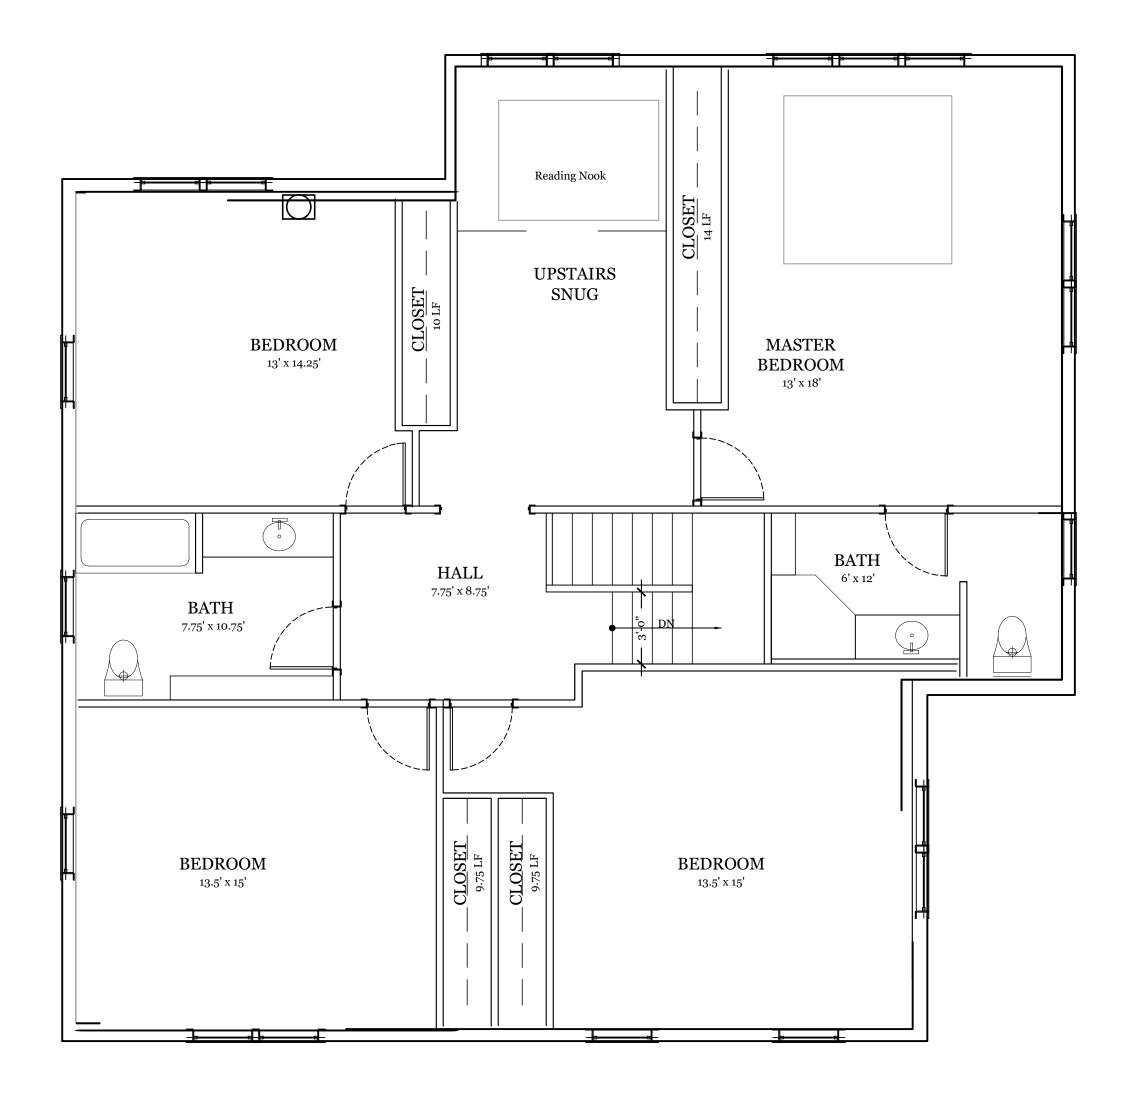



heritage homesite

Dan and Allie Ferenczy
907-750-8306 Dan
713-376-6603 Allie
daniel.ferenczy@gmail.com
allie.ferenczy@gmail.com

9220 Damascus Hills Lane, Damascus MD 28702

NOTES

DESIGN DEVELOPMENT

7 HOME Damascus, MD 20882

FEREN(
9220 Damascus Hills La


100% DESIGN DEVELOPMENT

SHEET TITLE

BUILDING PLANS: 2ND FLOOR & ROOF

DRAWN BY:

SCALE: 1/4"=1'-0" A-1.2
DATE:

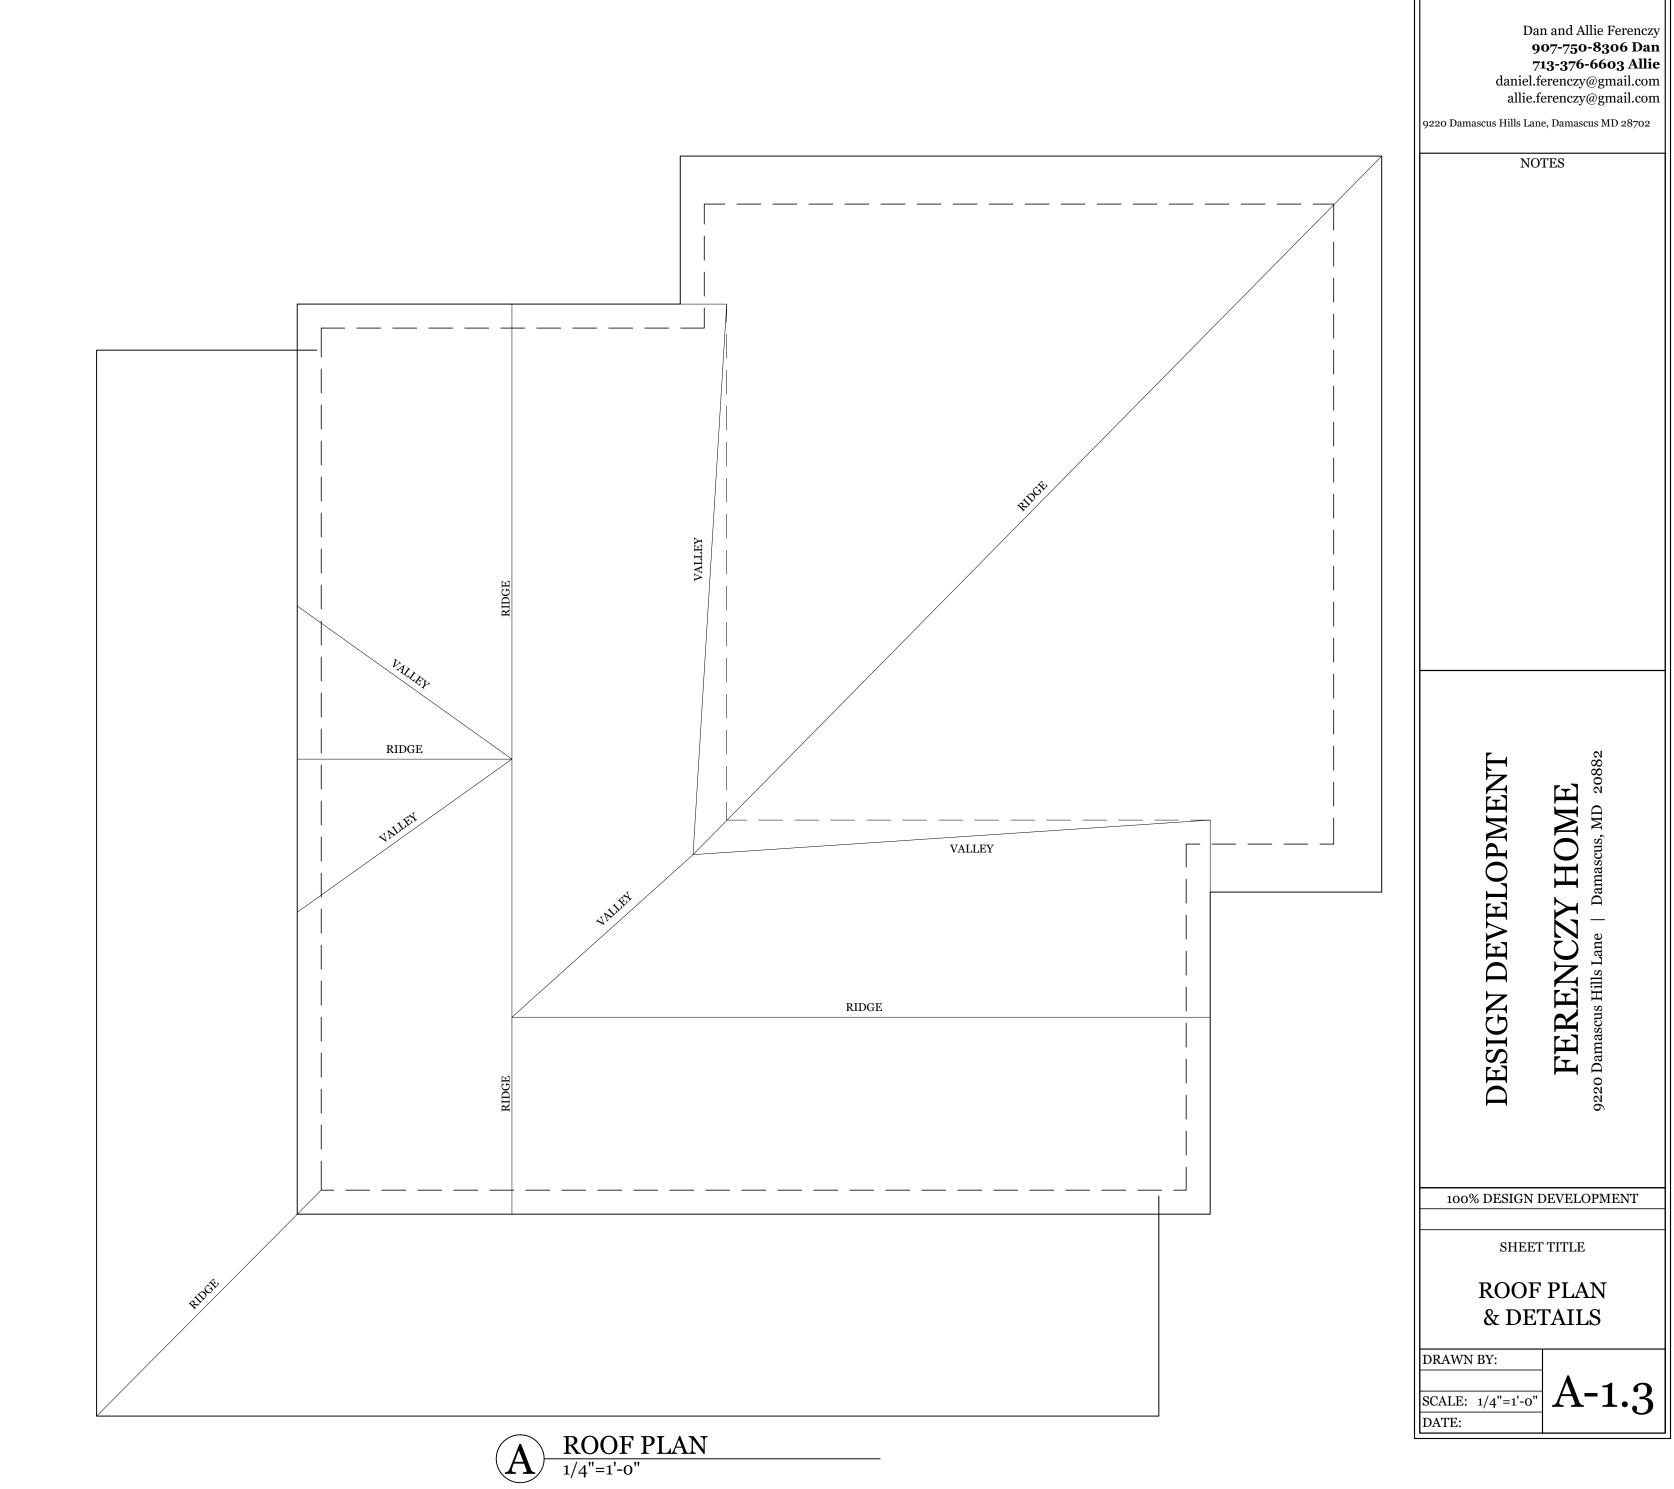


heritage homesite


ICZY HOME

Lane | Damascus, MD 20882

FEREN(
9220 Damascus Hills La




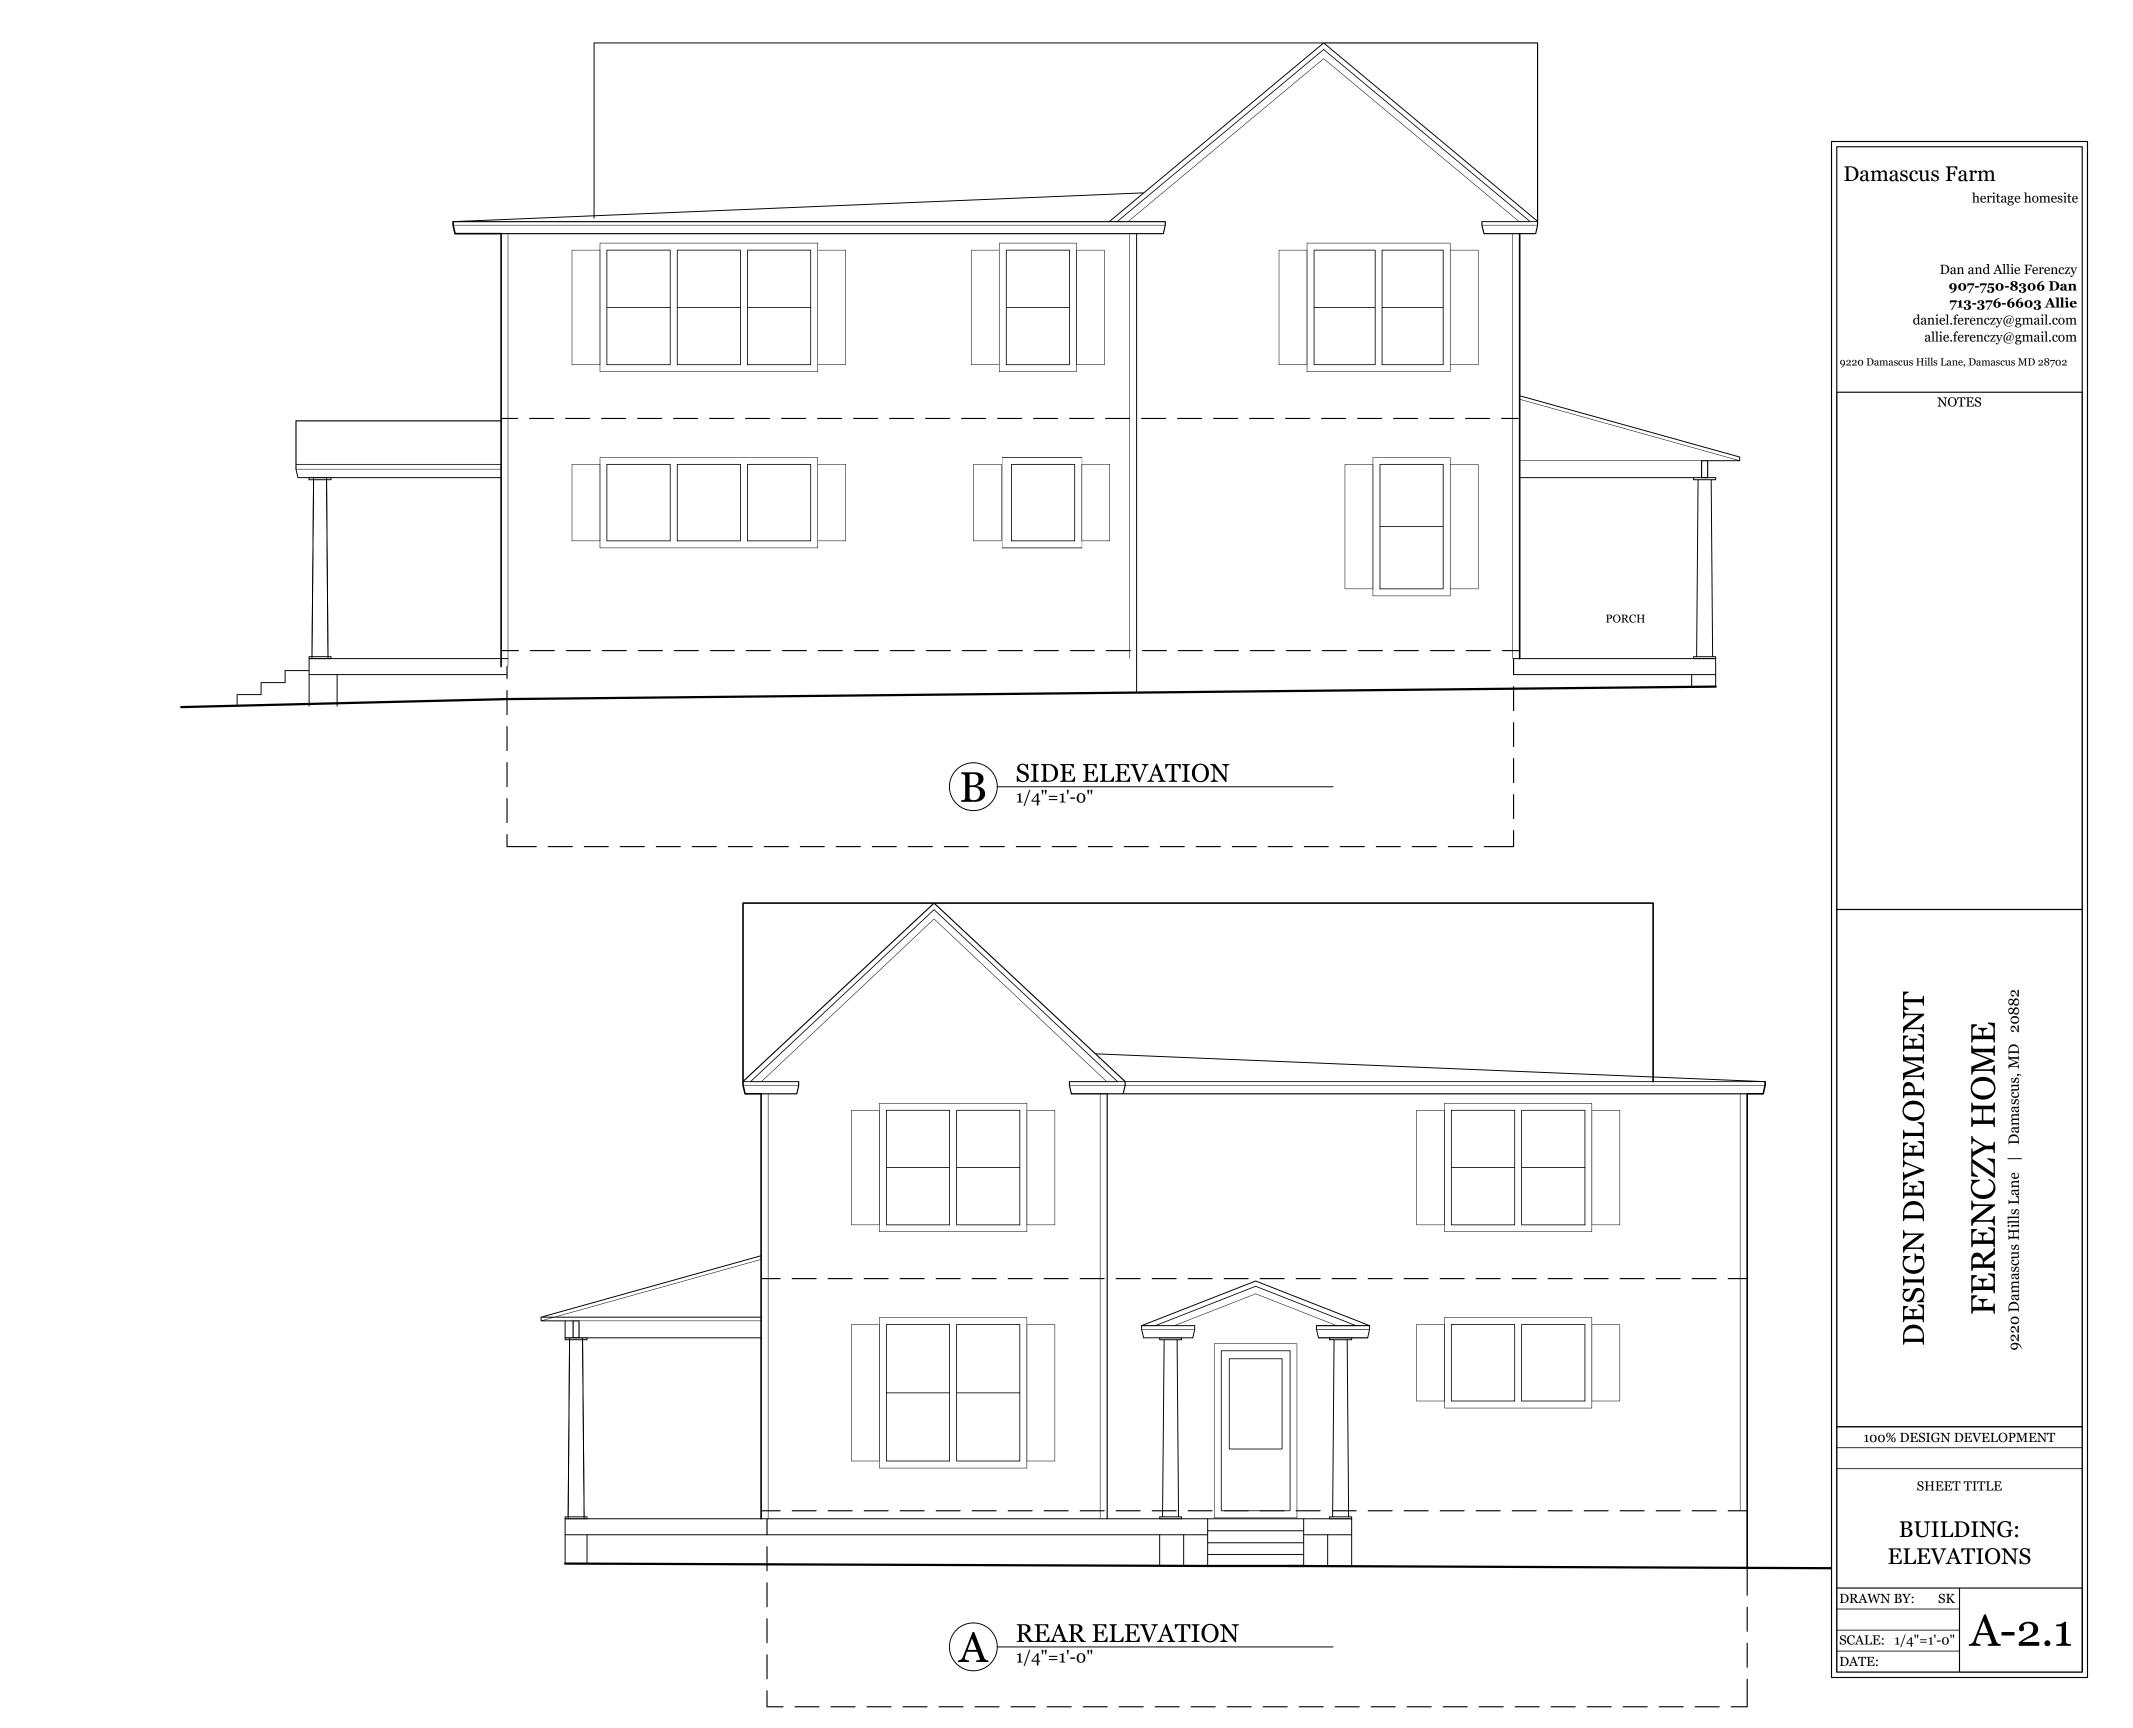


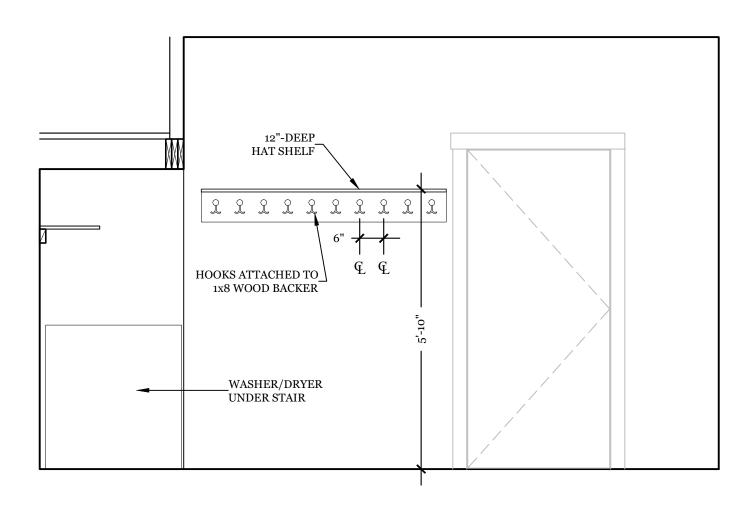


DOOR TO KITCHEN

1/2"=1'-0"

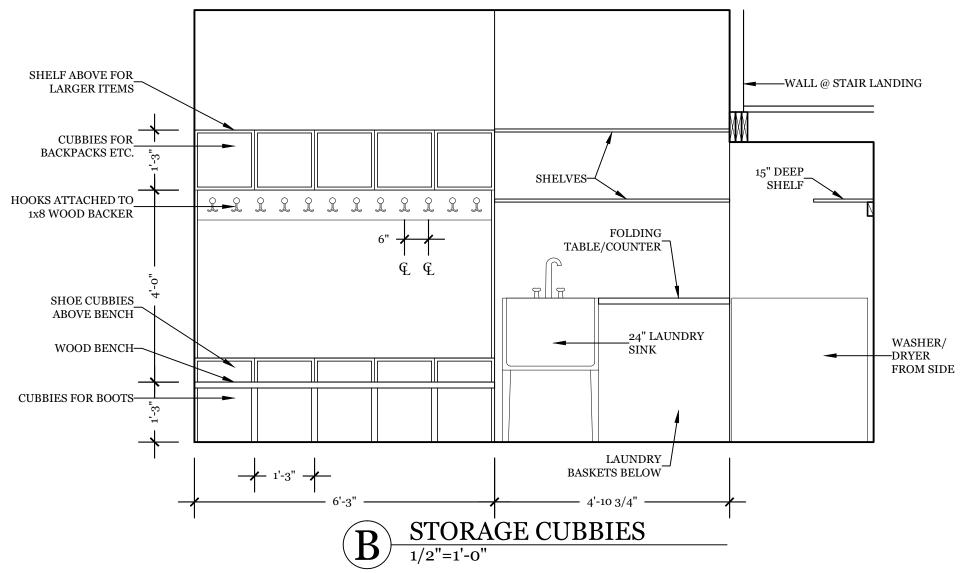

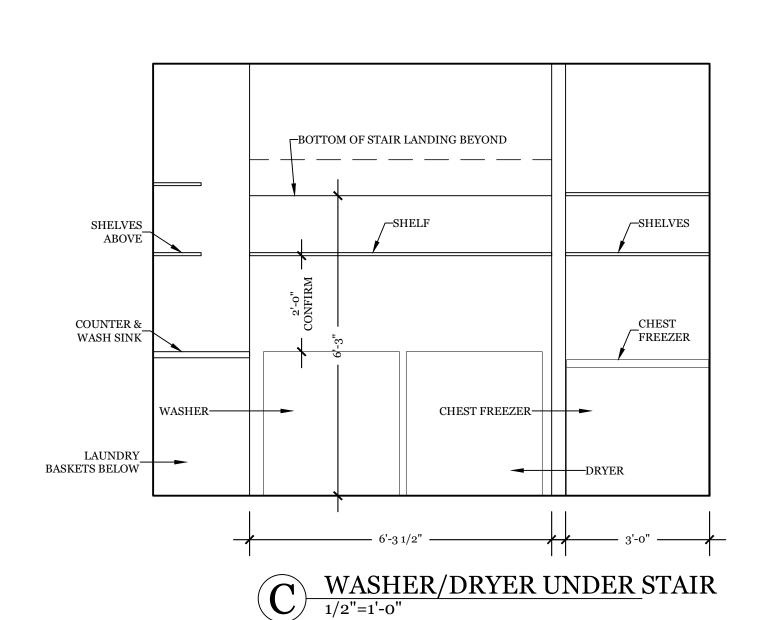

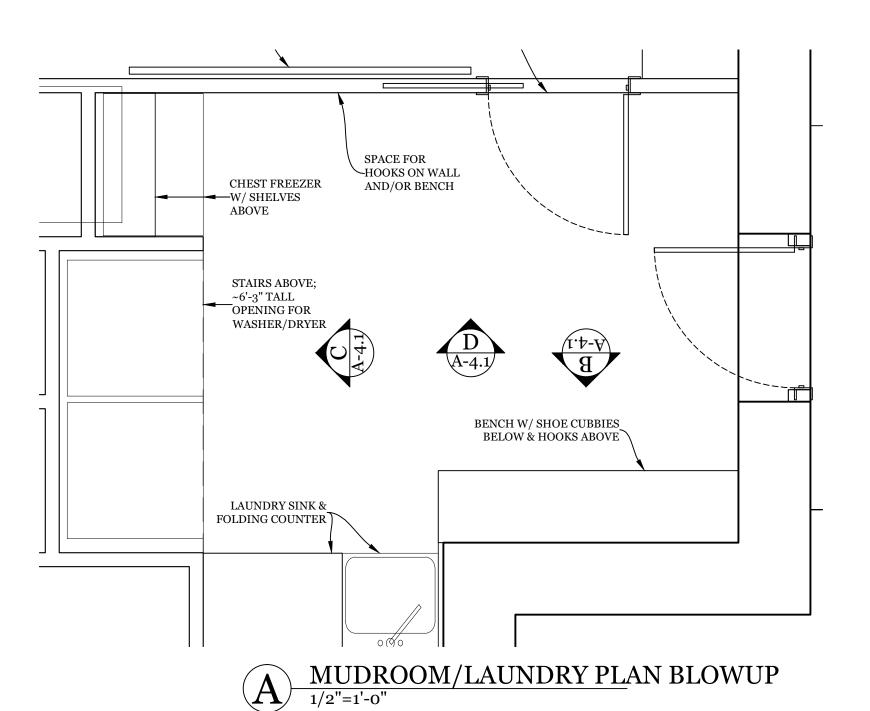


Dan and Allie Ferenczy 907-750-8306 Dan 713-376-6603 Allie daniel.ferenczy@gmail.com allie.ferenczy@gmail.com 9220 Damascus Hills Lane, Damascus MD 28702 NOTES CZY HOME
ane | Damascus, MD 20882 EVELOPMENT FEREN(
9220 Damascus Hills La DESIGN D 100% DESIGN DEVELOPMENT SHEET TITLE INTERIOR ELEV'S: MUDROOM/LAUNDRY DRAWN BY:


SCALE: 1/2"=1'-0"

DATE:

Damascus Farm

heritage homesite

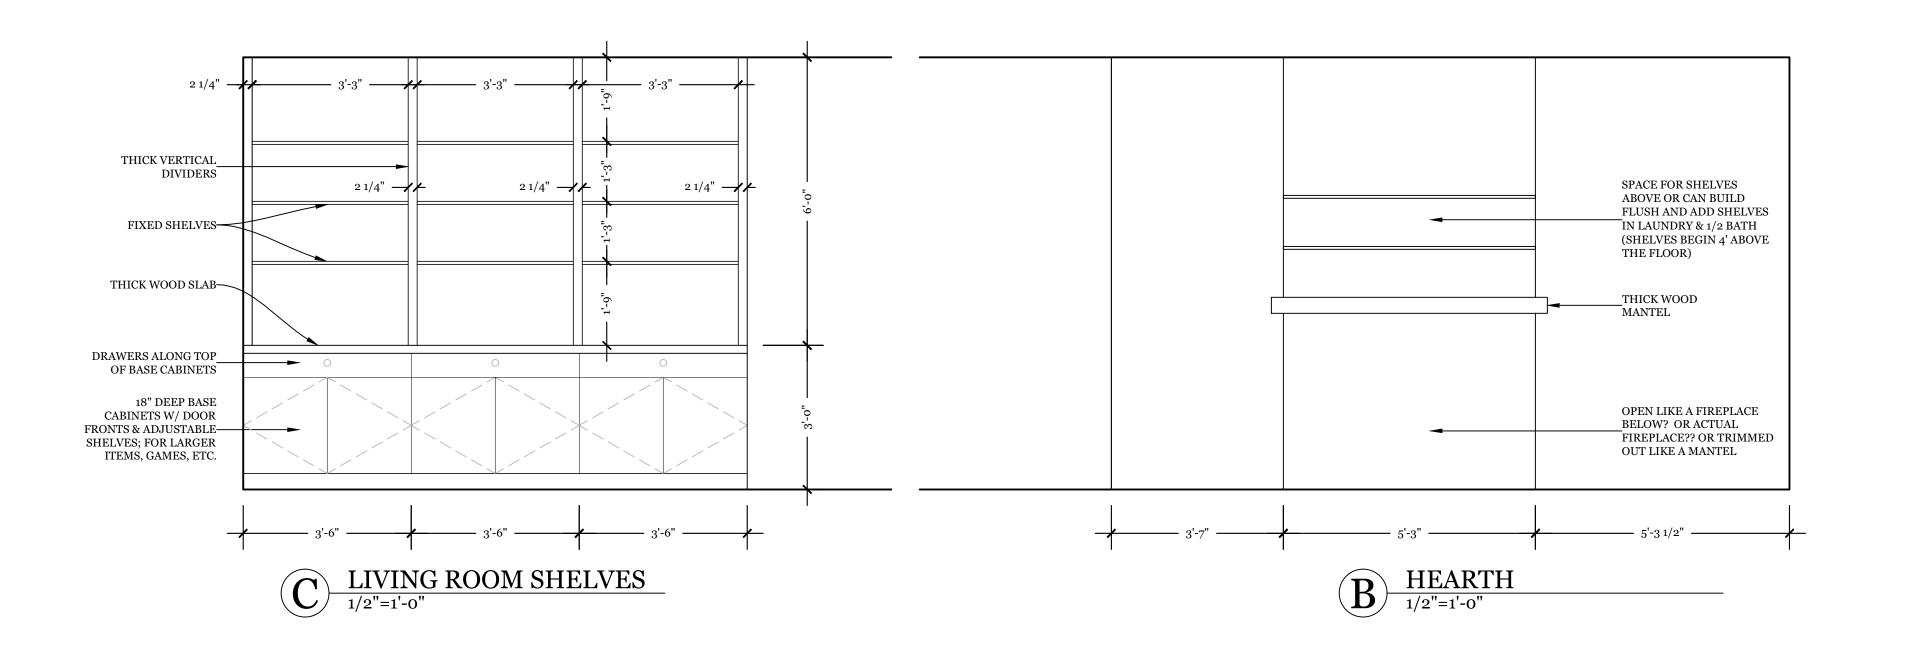

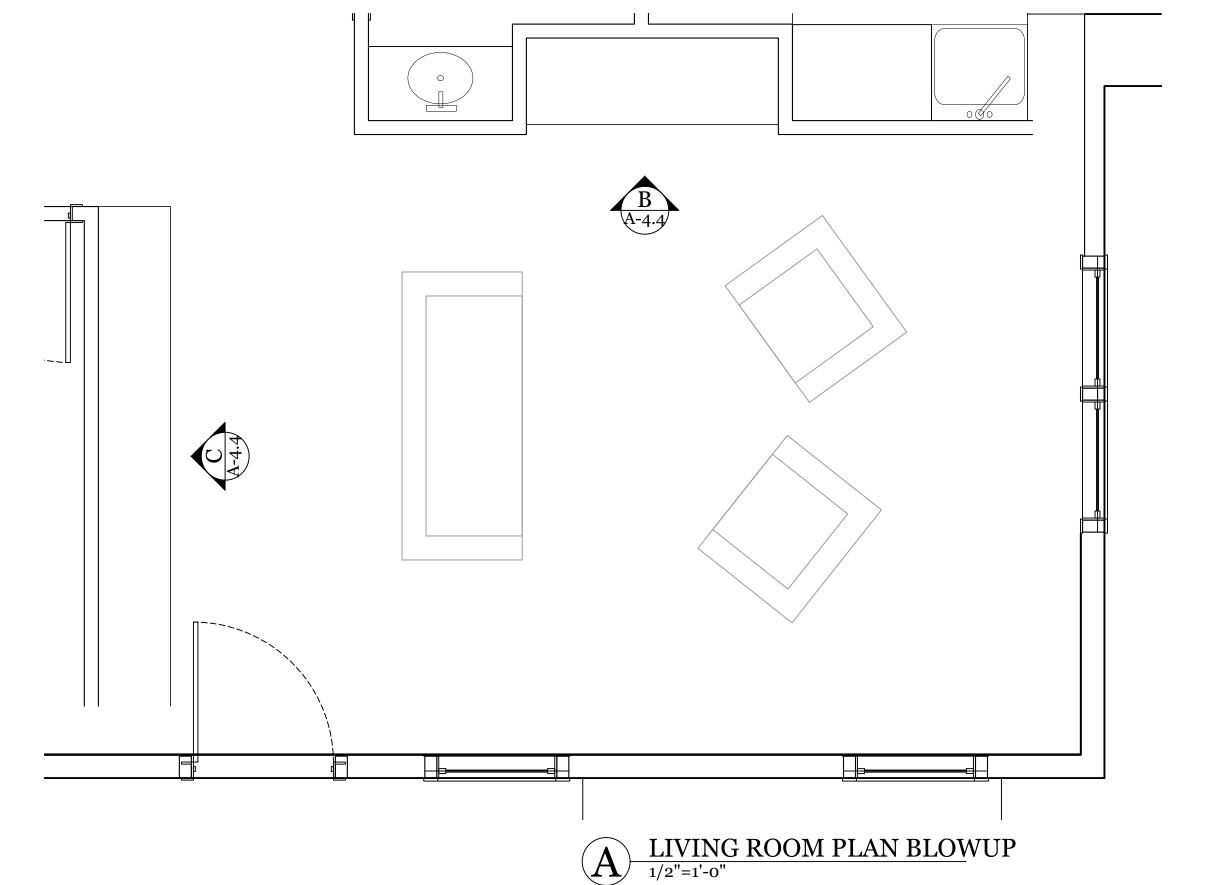

Damascus Farm heritage homesite Dan and Allie Ferenczy 907-750-8306 Dan 713-376-6603 Allie daniel.ferenczy@gmail.com allie.ferenczy@gmail.com 9220 Damascus Hills Lane, Damascus MD 28702 NOTES

CZY HOME
ane | Damascus, MD 20882 EVELOPMENT FEREN(DESIGN D


100% DESIGN DEVELOPMENT


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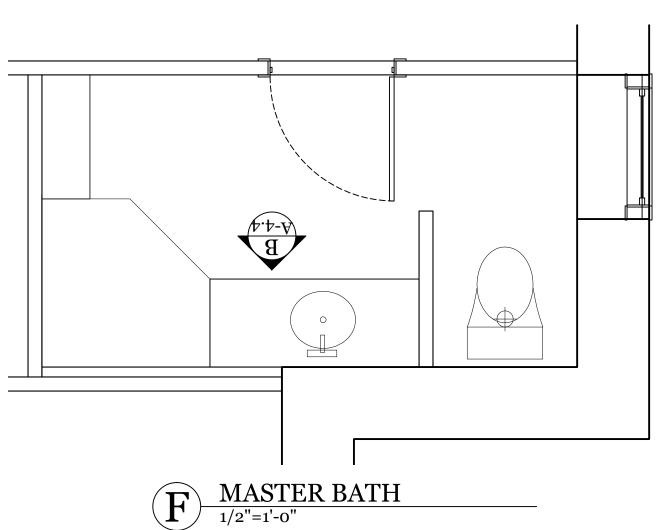
INTERIOR ELEV'S: LIVING ROOM


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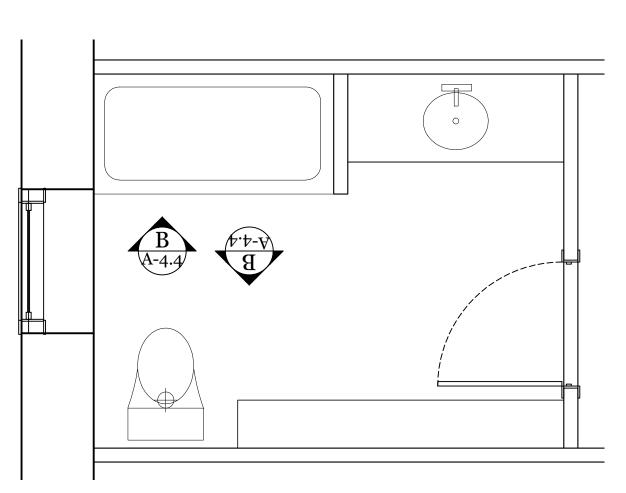
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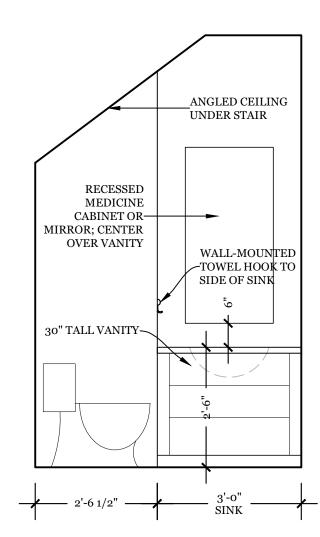








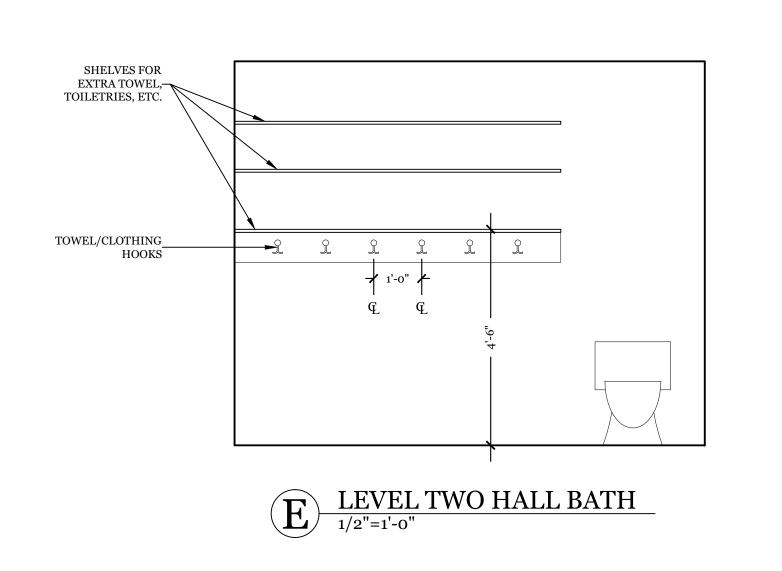

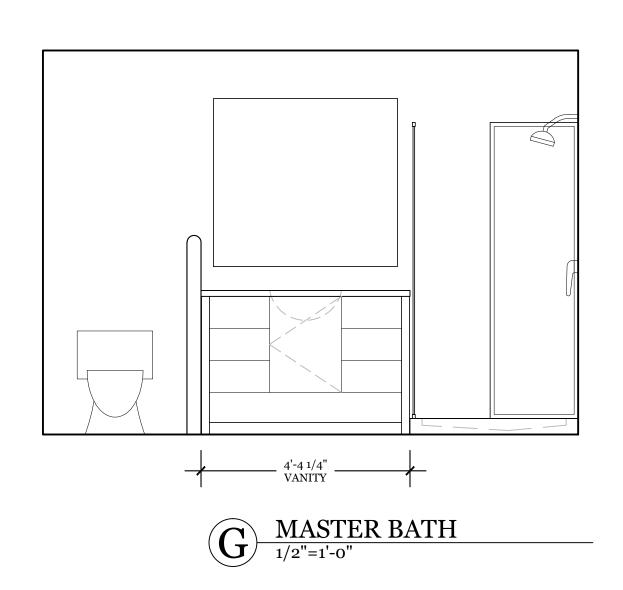

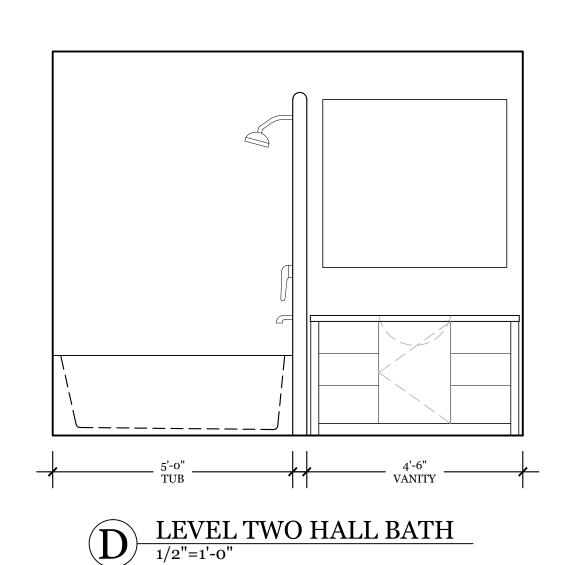

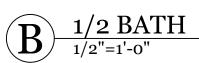

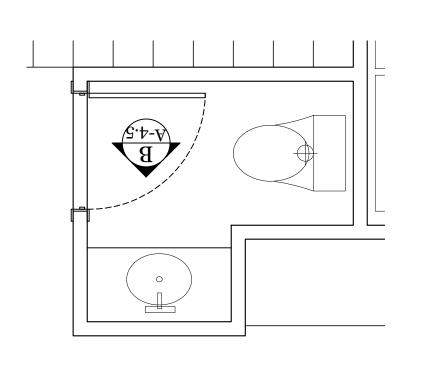



Damascus Farm

heritage homesite

Dan and Allie Ferenczy
907-750-8306 Dan
713-376-6603 Allie
daniel.ferenczy@gmail.com
allie.ferenczy@gmail.com
9220 Damascus Hills Lane, Damascus MD 28702

NOTES

DESIGN DEVELOPMENT
FERENCZY HOME
9220 Damascus Hills Lane | Damascus, MD 20882


SHEET TITLE

INTERIOR ELEV'S:
BATHS


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100% DESIGN DEVELOPMENT

SCALE: 1/2"=1'-0" DATE: A-4.5



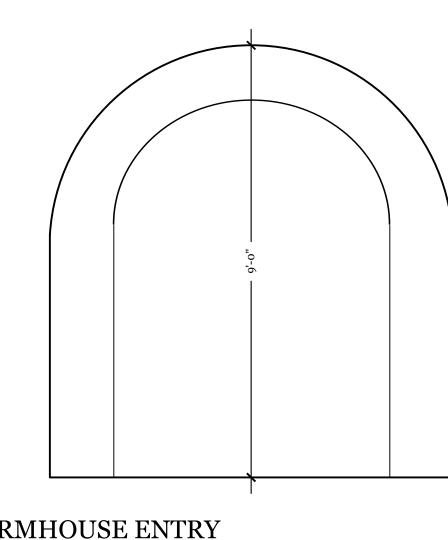

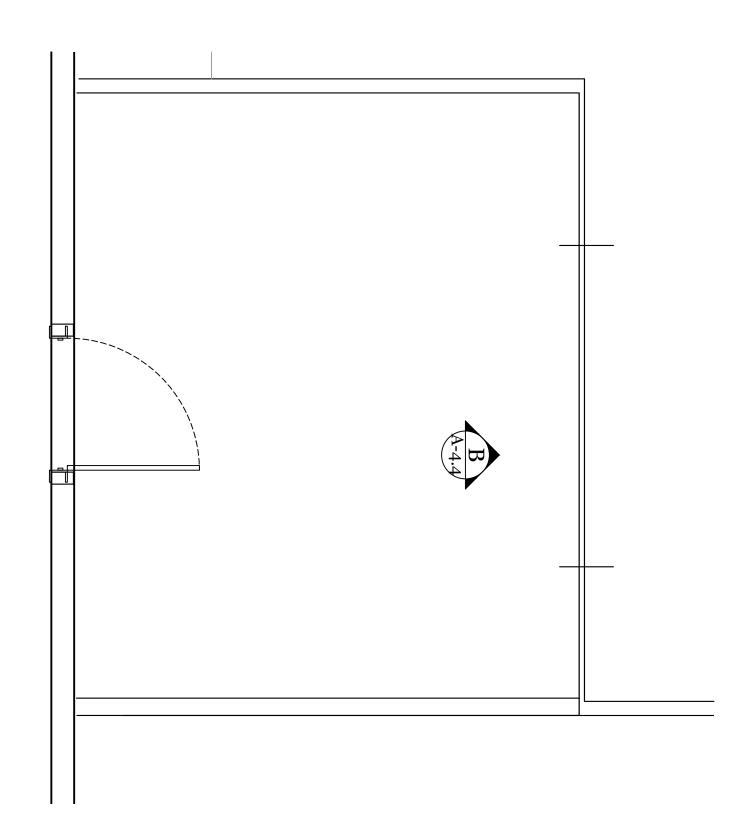

heritage homesite

Dan and Allie Ferenczy 907-750-8306 Dan 713-376-6603 Allie daniel.ferenczy@gmail.com allie.ferenczy@gmail.com

9220 Damascus Hills Lane, Damascus MD 28702

NOTES

DESIGN DEVELOPMENT FERENCZY HOME 9220 Damascus Hills Lane | Damascus, MD 20882

100% DESIGN DEVELOPMENT

SHEET TITLE

INTERIOR ELEV'S: ENTRY


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SCALE: 1/2"=1'-0" DATE:

A LIVING ROOM PLAN BLOWUP

1/2"=1'-0"

Farmstead front view near top of driveway

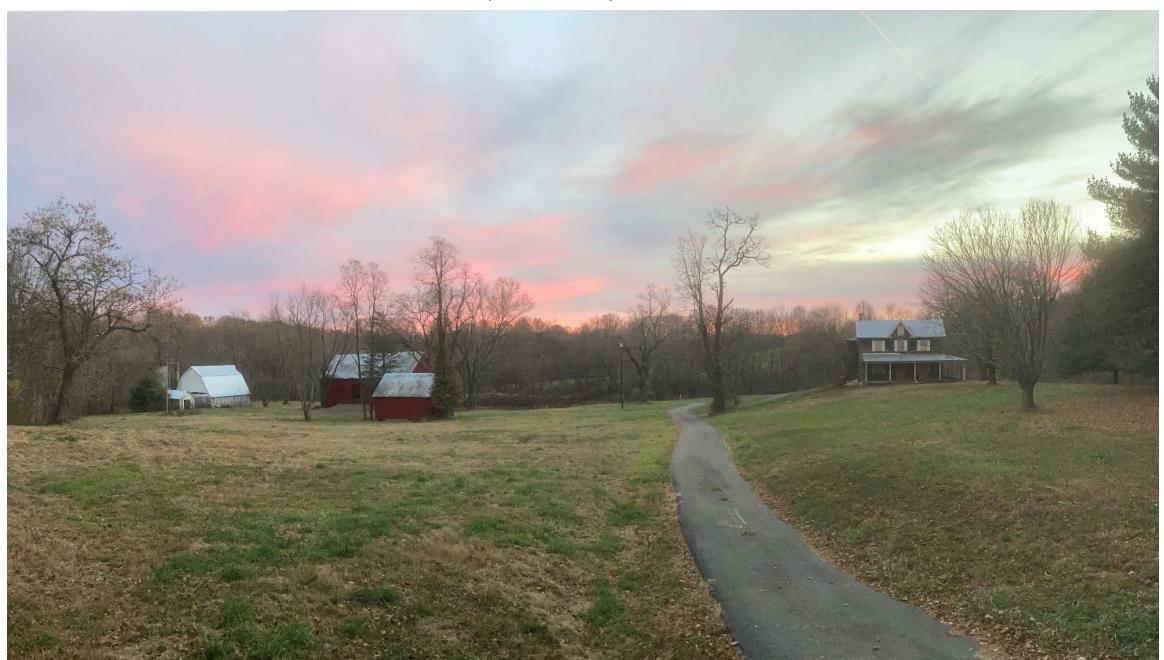


Farmstead rear view from below the pond



Dwelling North Front



Dwelling East Side

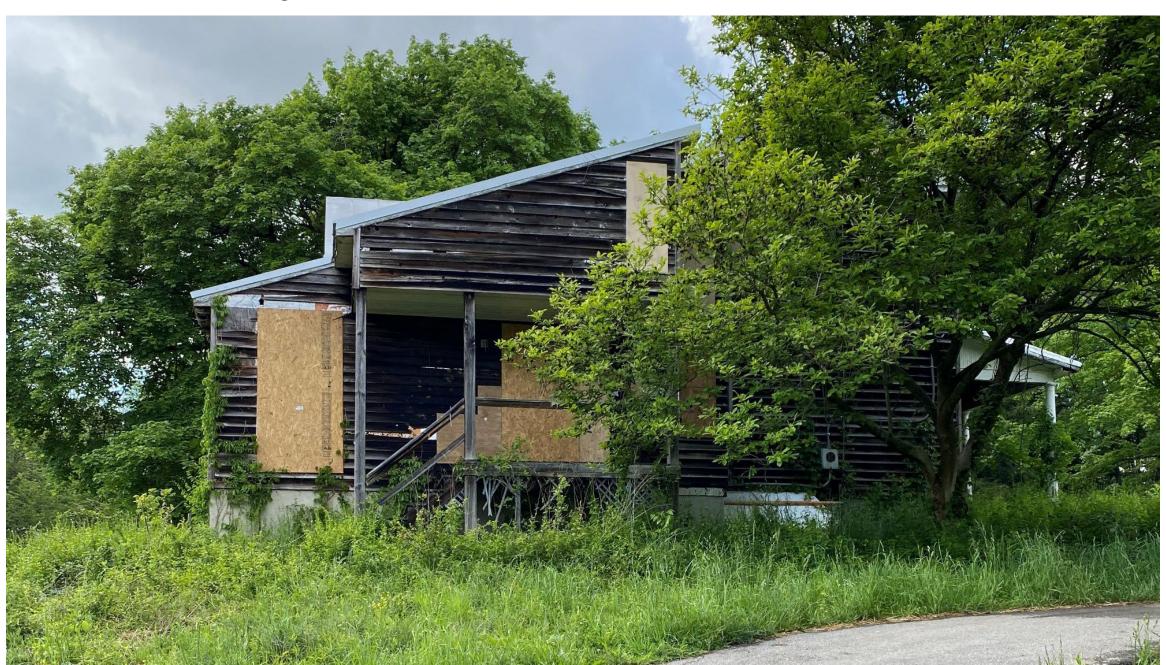

Dwelling Southeast Side



Dwelling South (Back)




Dwelling Southwest Side




Dwelling West Side




Interior Main Gable and Front Dormer

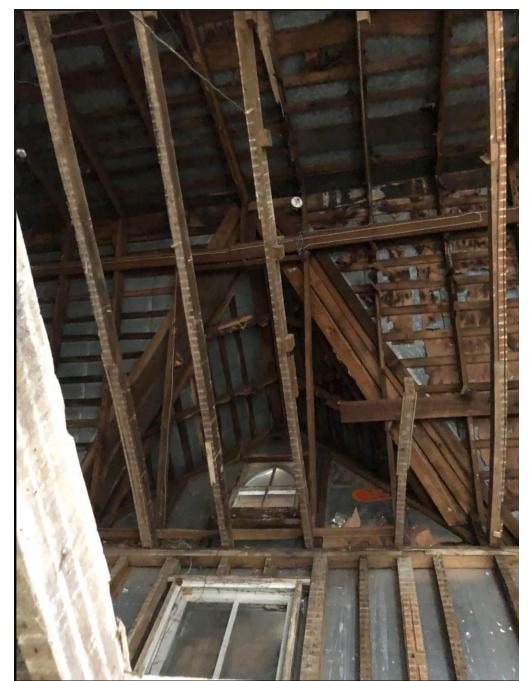


Interior Rear Gable – removed chimney is where

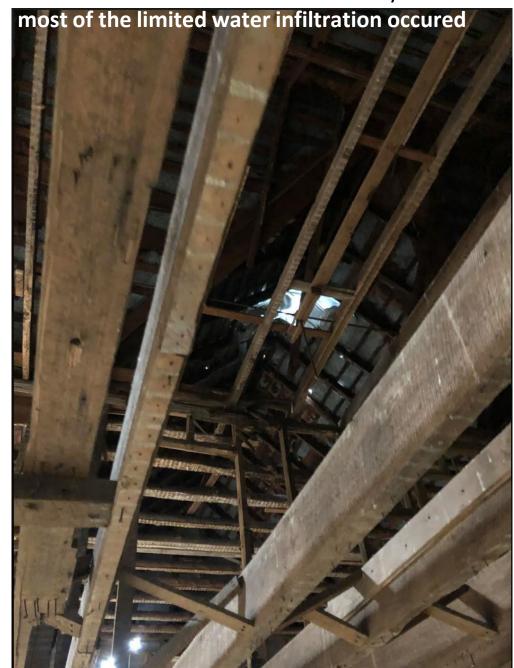

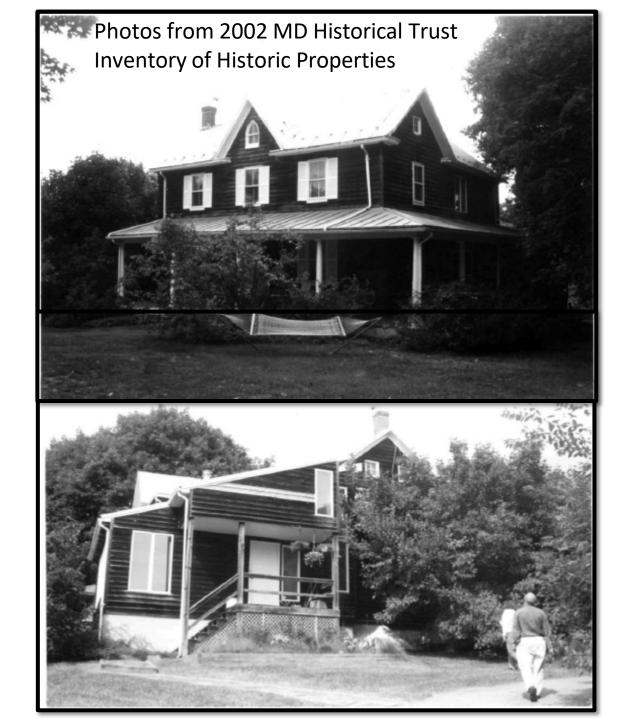



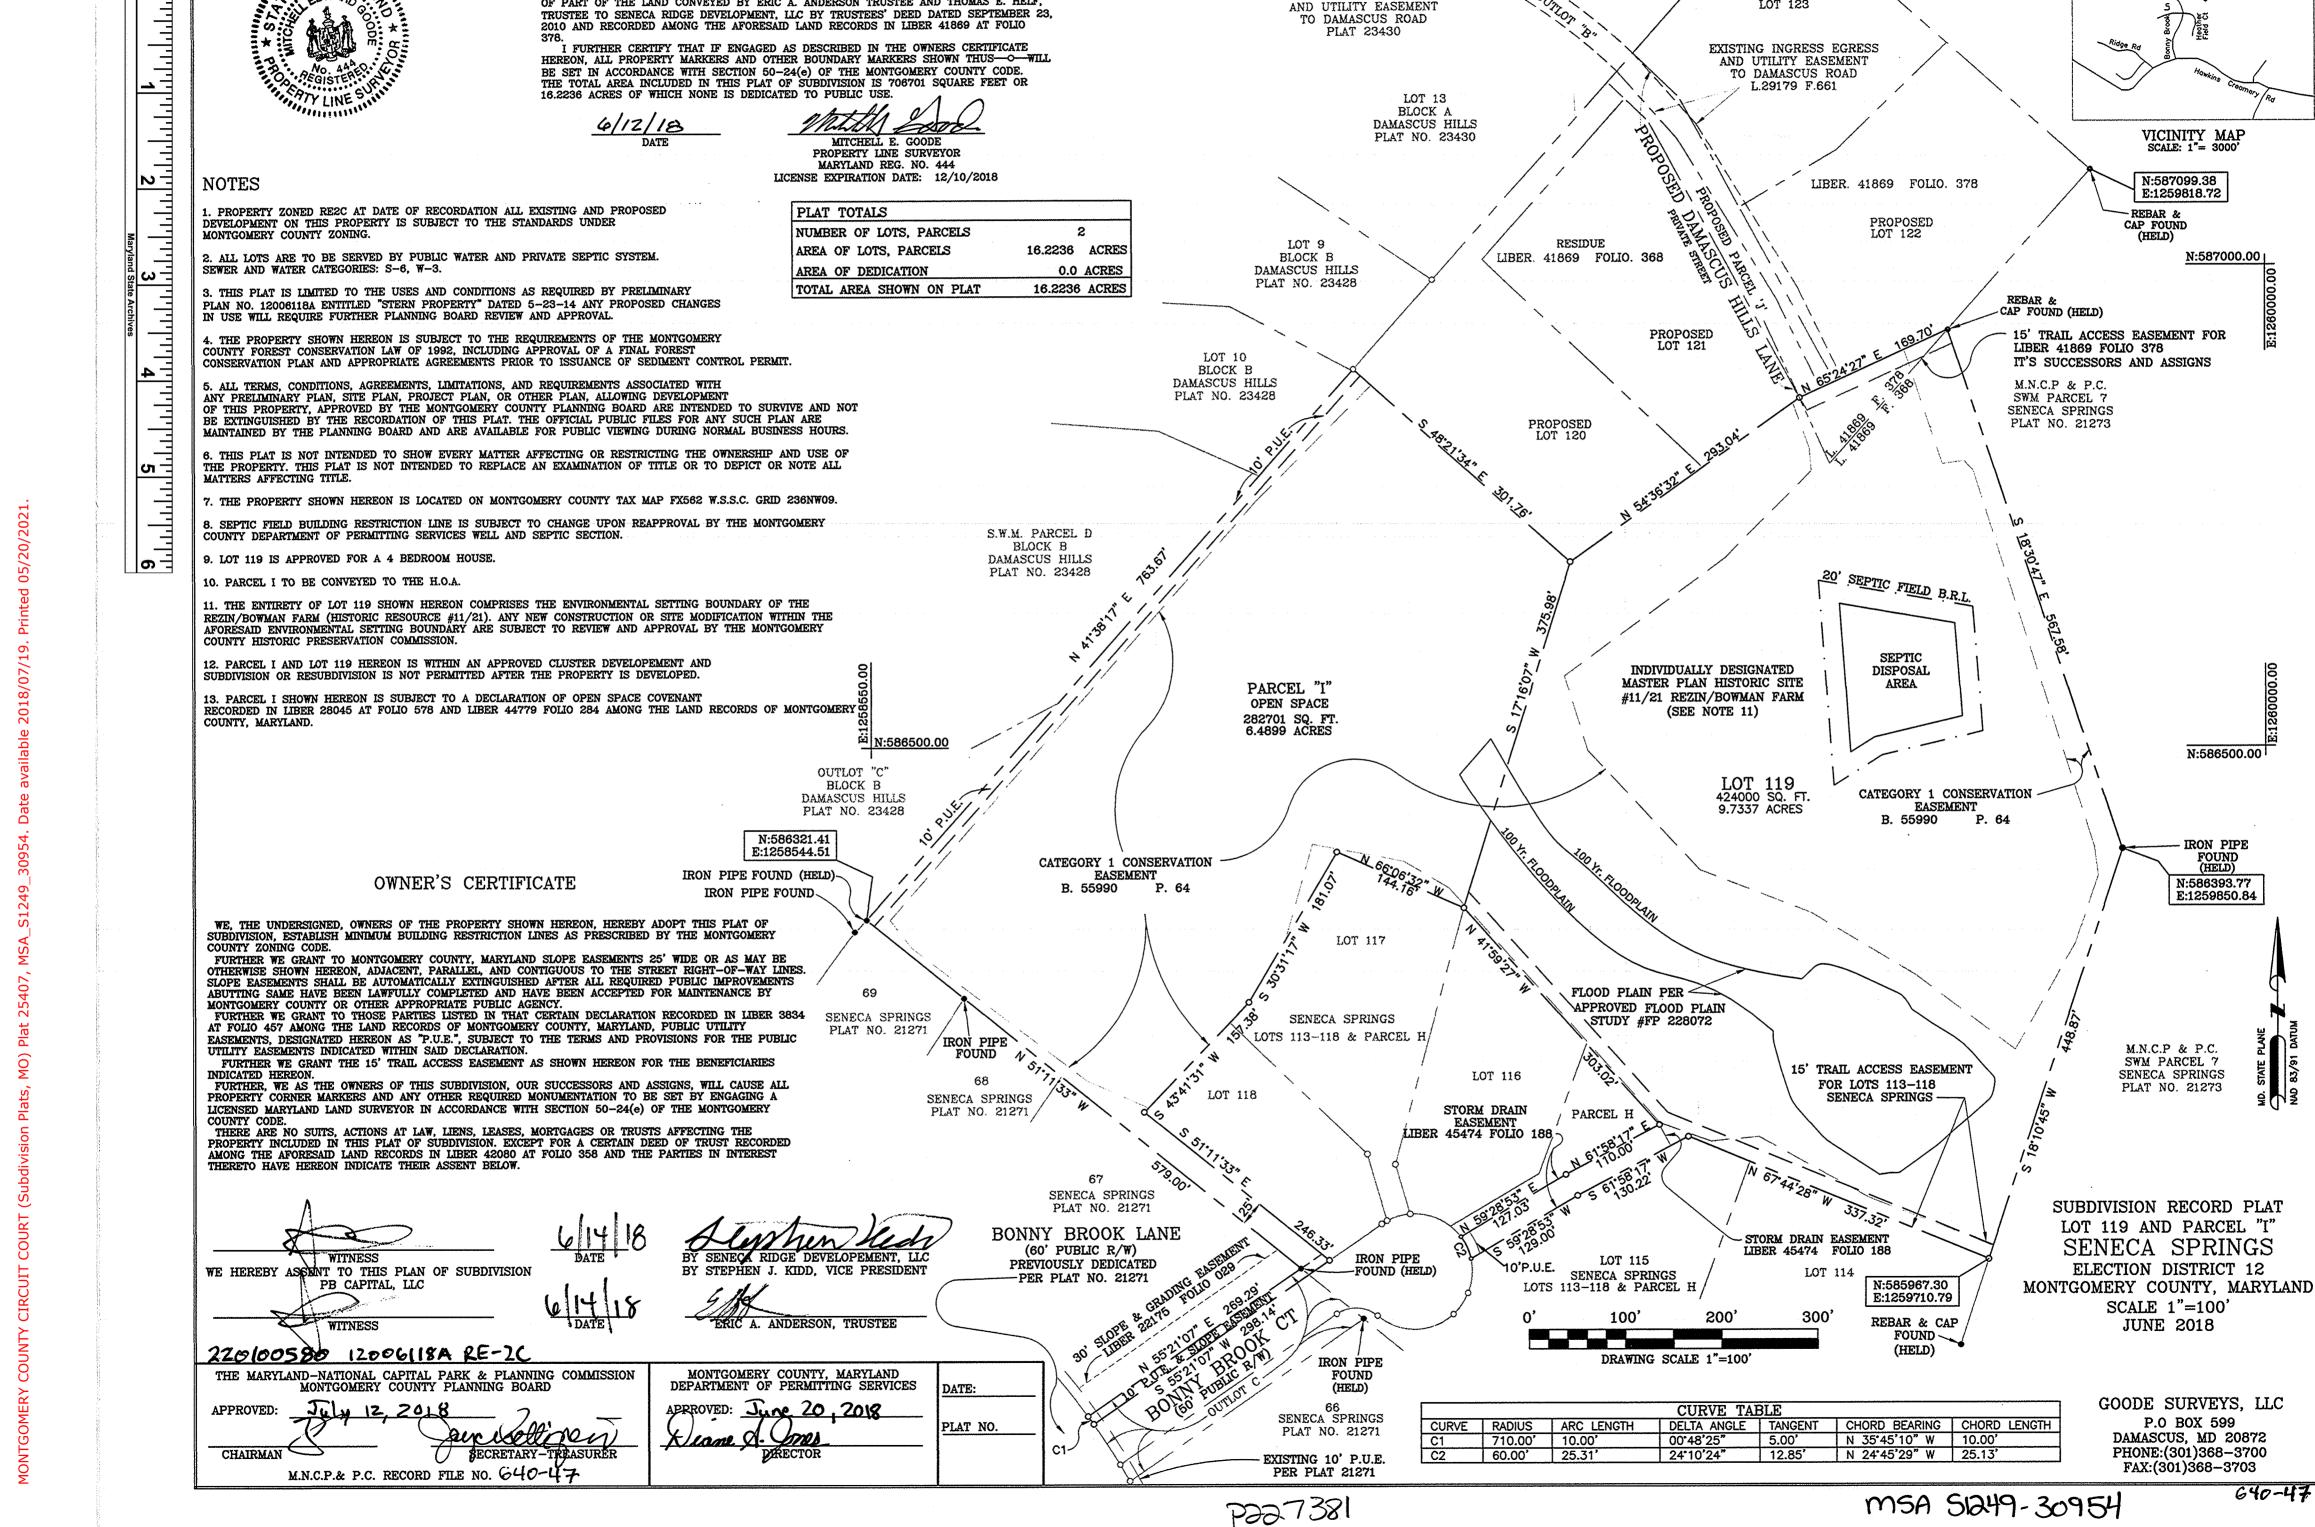

PLAT NO.

25407

EXISTING INGRESS EGRESS

AND UTILITY EASEMENT

SURVEYOR'S CERTIFICATE

I HEREBY CERTIFY THAT THE PLAT SHOWN HEREON IS TRUE TO THE BEST OF MY PROFESSIONAL KNOWLEDGE AND BELIEF, THAT IT IS A SUBDIVISION OF PART OF THE LAND CONVEYED BY ERIC A. ANDERSON, TRUSTEE, SUBSTITUTE TRUSTEE TO SENECA RIDGE

DEVELOPMENT, LLC, A MARYLAND LIMITED LIABILITY COMPANY BY SUBSTITUTE TRUSTEE'S DEED DATED SEPTEMBER 23, 2010 AND RECORDED AMONG THE LAND RECORDS OF MONTGOMERY COUNTY, MARYLAND IN LIBER 41869 AT FOLIO 368. AND ALSO A SUBDIVISION OF PART OF THE LAND CONVEYED BY ERIC A. ANDERSON TRUSTEE AND THOMAS E. HELF,

REBAR & CAP FOUND

M.N.C.P & P.C.

SWM PARCEL 7

SENECA SPRINGS

PLAT NO. 21273

THIS PLAT

VICINITY MAP SCALE: 1"= 3000'

N:587099.38

E:1259818.72

N:587000.001

N:586500.00

IRON PIPE

N:586393.77

P.O BOX 599

640-47

E:1259850.84

(HELD)

LOT 15 BLOCK A PLAT NO. 23430

LOT 14

BLOCK A

DAMASCUS HILLS

PLAT NO. 23430



DEPARTMENT OF PERMITTING SERVICES

Marc Elrich
County Executive

Rabbiah Sabbakhan *Director*

HISTORIC AREA WORK PERMIT APPLICATION

Application Date: 4/17/2024

Application No: 1067141

AP Type: HISTORIC Customer No: 1425582

Affidavit Acknowledgement

The Homeowner is the Primary applicant
This application does not violate any covenants and deed restrictions

Primary Applicant Information

Address 9220 DAMASCUS HILLS LN

DAMASCUS, MD 20872

Homeowner Ferenczy (Primary)

Othercontact Ferenczy

Historic Area Work Permit Details

Work Type ALTER

Scope of Work The farmhouse requires complete rehabilitation