MONTGOMERY COUNTY HISTORIC PRESERVATION COMMISSION STAFF REPORT

Address: 8000 Hampden Lane, Bethesda Meeting Date: 2/7/2024

Resource: Contributing Resource **Report Date:** 1/31/2024

(Greenwich Forest Historic District)

Applicant: Chuen-Yen Lau & Adam Sherwat **Public Notice:** 1/24/2024

Review: HAWP **Tax Credit:** n/a

Permit No.: 1029531 REVISION **Staff:** Dan Bruechert

Proposal: Revision to previously approved HAWP for alterations to previously approved garage

STAFF RECOMMENDATION

Staff recommends the HPC **approve** the HAWP application.

ARCHITECTURAL DESCRIPTION

SIGNIFICANCE: Contributing Resource within the Greenwich Forest Historic District

STYLE: Colonial Revival

DATE: 1938



Figure 1: 8000 Hampden Lane, as indicated by the yellow star, is located at the northwest corner of the intersection of Hampden Lane and York Lane.

BACKGROUND

The HPC approved a HAWP at the subject property at the June 28, 2023 HPC meeting to construct a detached garage.¹

On September 6, 2023, the HPC approved a HAWP for tree removal and replacement to accommodate the detached garage.2

PROPOSAL

The applicant revised three materials on the approved accessory structure for:

- A new foundation material;
- Wood brackets to support the entrance roof; and,
- Surrounding hardscaping.

APPLICABLE GUIDELINES

When reviewing alterations and new construction within the Greenwich Forest Historic District several documents are to be utilized as guidelines to assist the Commission in developing their decision. These documents include the historic preservation review guidelines in the approved and adopted amendment for the *Greenwich Forest Historic District (Guidelines)*, *Montgomery County Code Chapter 24A* (*Chapter 24A*), and *the Secretary of the Interior's Standards for Rehabilitation (Standards)*. The pertinent information in these documents is outlined below.

Greenwich Forest Historic District Guidelines

A. PRINCIPLES

The preservation of the following essential elements of Greenwich Forest is the highest priority in making decisions concerning applications for work permits. These Principles are not meant to stop or create unreasonable obstacles to normal maintenance, reasonable modifications, and the evolving needs of residents.

A2. The houses in Greenwich Forest create an integrated fabric well-suited to its forest setting. These Guidelines are intended to preserve this environment by ensuring that approved work permits include appropriate safeguards that protect the following three essential elements of this fabric:

b. The *scale and spacing* of houses and their *placement* relative to adjacent houses and the public right-of-way. The original developers made decisions on these three elements to understate the presence of structures relative to the forest. For example, minimum side setbacks at the time were 7' but placement and spacing produced distances between houses that far exceeded the minimum 14'. Additions and new houses have, in almost all cases, preserved generous space between

¹ The Staff Report and application materials are available here: https://montgomeryplanning.org/wpcontent/uploads/2023/06/I.A-8000-Hampden-Lane-Bethesda-1029531.pdf and the recording of the hearing is available here: https://mncppc.granicus.com/MediaPlayer.php?publish_id=d350f055-1697-11ee-aabb-0050569183fa.

² The Staff Report for the September 6, 2023 HAWP is available here: https://montgomeryplanning.org/wp-content/uploads/2023/08/I.H-8000-Hampden-Lane-Bethesda-1040525.pdf.

houses and minimized visual crowding with plantings.

c. High quality building materials and high level of craftsmanship.

B. BALANCING PRESERVATION AND FLEXIBILITY

Greenwich Forest represents a period in the evolution of Montgomery County worthy of preservation, but it has also changed in response to the needs of residents since it was created in the 1930s. These Guidelines seek a reasonable compromise between preservation and the needs of residents in several ways.

- B1. Most of the houses in the Greenwich Forest Historic District are designated "contributing" because they contribute to the architectural and historic nature of the district. Contributing structures are shown in the map of the districts. These Guidelines are more specific for contributing structures.
- B2. Other houses in the district are designated non-contributing either because (1) they were built more recently than contributing houses with other architectural styles (see Appendix 3) or (2) their original features have been significantly altered by subsequent modifications. Non-contributing structures are shown on the map of the District. The Guidelines provide greater flexibility for owners of non-contributing houses.
- B3. These Guidelines reflect the reality that nearly all houses in Greenwich Forest have been modified since their construction. Owners are not expected to return their houses to their original configurations. The modifications they are permitted to make under these Guidelines are based on the current reality in the neighborhood, provided that those modifications are consistent with the Principles in these Guidelines.
- B4. Property owners have additional flexibility under these Guidelines to make more extensive changes to the parts of their houses that are less visible from the public rights-of-way in front of their houses. The Guidelines accomplish this by stipulating different levels of review for specific elements on different parts of houses.

The *Guidelines* that pertain to this project are as follows:

- A2. The houses in Greenwich Forest create an integrated fabric well-suited to its forest setting. These Guidelines are intended to preserve this environment by ensuring that approved *work permits* include appropriate safeguards that protect the following three essential elements of this fabric.
- a. An array of revival American *architectural styles* that, taken together, make a significant statement on the evolution of suburban building styles (see Appendix 2).
- b. The *scale and spacing* of houses and their *placement* relative to adjacent houses and the public right-of-way. The original developers made decisions on these three elements to understate the presence of structures relative to the forest. For example, minimum side setbacks at the time were 7' but placement and spacing produced distances between houses that far exceeded the minimum 14'. Additions and new houses have, in almost all cases, preserved generous space between houses and minimized visual crowding with plantings.
- c. High quality building materials and high level of craftsmanship.
- 7. Building materials: Replacement of roofs, siding, and trim with original materials is strongly recommended and is considered maintenance that will not require an application for a work permit. Use of non-original "like materials" such as architectural asphalt shingles requires a work permit to ensure that they match the scale, texture, and detail of the original materials and are consistent with the overall design of the existing house. For example, homeowners wishing to replace slate or tile roofs may use

alternative materials that match the scale, texture, and detail of the roof being replaced. If an original slate or tile roof had been replaced with non-original material before July 1, 2011, the homeowner may replace the existing roof in kind or with another material consistent with the architectural style of that house.

D16. Walkways and patios: Reconfiguration and replacement of existing pathways and patios that would not result in a net addition of impermeable hardscape surfaces are considered landscaping and do not require an application for a work permit. The installation of new walkways and patios requires a work permit and should minimize the creation of new impermeable hardscape surfaces (see Principle 1).

According to the *Guidelines*, the three levels of review are as follows:

Limited scrutiny is the least rigorous level of review. With this level, the scope or criteria used in the review of applications for work permits is more limited and emphasizes the overall structure rather than materials and architectural details. The decision-making body should base its review on maintaining compatibility with the design, texture, scale, spacing and placement of surrounding houses and the impact of the proposed change on the streetscape.

Moderate scrutiny is a higher level of review than limited scrutiny and adds consideration of the preservation of the property to the requirements of limited scrutiny. Alterations should be designed so the altered structure does not detract from the fabric of Greenwich Forest while affording homeowners reasonable flexibility. Use of compatible new materials or materials that replicate the original, rather than original building materials, should be permitted. Planned changes should be compatible with the structure's existing architectural designs.

Strict scrutiny is the highest level of review. It adds consideration of the integrity and preservation of significant architectural or landscape features and details to the requirements of the limited and moderate scrutiny levels. Changes may be permitted if, after careful review, they do not significantly compromise the original features of the structure or landscape.

Sec. 24A-8. Same-Criteria for issuance.

- (a) The commission shall instruct the director to deny a permit if it finds, based on the evidence and information presented to or before the commission that the alteration for which the permit is sought would be inappropriate, inconsistent with or detrimental to the preservation, enhancement or ultimate protection of the historic site or historic resource within an historic district, and to the purposes of this chapter.
- (b) The commission shall instruct the director to issue a permit, or issue a permit subject to such conditions as are found to be necessary to insure conformity with the purposes and requirements of this chapter, if it finds that:
 - (1) The proposal will not substantially alter the exterior features of an historic site or historic resource within an historic district; or
 - (2) The proposal is compatible in character and nature with the historical, archeological, architectural or cultural features of the historic site or the historic district in which an historic resource is located and would not be detrimental thereto or to the achievement of the purposes of this chapter; or
 - (5) The proposal is necessary in order that the owner of the subject property not be deprived of reasonable use of the property or suffer undue hardship; or
 - (6) In balancing the interests of the public in preserving the historic site or historic resource located within an historic district, with the interests of the public from the use and benefit of the alternative proposal, the general public welfare is better served by granting the permit.
- (d) In the case of an application for work on an historic resource located within an historic district,

the commission shall be lenient in its judgment of plans for structures of little historical or design significance or for plans involving new construction, unless such plans would seriously impair the historic or architectural value of surrounding historic resources or would impair the character of the historic district. (*Ord. No. 94, § 1; Ord. No. 11-59.*)

Secretary of Interior's Standards for Rehabilitation

The Secretary of the Interior defines rehabilitation as "the act or process of making possible a compatible use for a property through repair, alterations, and additions while preserving those portions or features, which convey its historical, cultural, or architectural values." Standards 2, 9, and 10 most directly apply to the application before the commission:

- #2. The historic character of a property shall be retained and preserved. The removal of historic materials or alteration of features and spaces that characterize a property shall be avoided.
- #9. New additions, exterior alterations, or related new construction shall not destroy historic materials that characterize the property. The new work shall be differentiated from the old and will be compatible with the historic materials, features, size, scale and proportions, and massing to protect the integrity of the property and its environment.
- #10. New additions and adjacent or related new construction shall be undertaken in such a manner that if removed in the future, the essential form and integrity of the historic property and its environment would be unimpaired.

STAFF DISCUSSION

The subject property is a two-story, side-gable house constructed out of painted brick and stone. On the right side of the house, there is a one-story side gable enclosed porch. The historic attached rear-loading two-car garage, located on the left side of the house, was enclosed and captured as interior space before the district was established.

On June 28, 2023 the HPC approved a two-car garage with a workshop space on the second floor. The applicant revised some of the materials for the garage which are beyond the scope of the staff-level approval regulation. The proposed changes will not impact the size, massing, or location of the approved garage.

Foundation Material

The approved foundation material was stone to match the house foundation. The revised design has removed the decorative stonework and now proposes to carry the brick exterior to grade. Staff finds this change in materials still satisfies the requirement for 'high-quality building materials' as dictated by the *Design Guidelines*. Therefore, Staff recommends the HPC approve the new foundation material under the *Design Guidelines*, 24A-8(b)(2) and (d), and Standards 2, 9, and 10.

Roof Brackets

The HAWP approval showed no roof supports for the small roof above the pair of French doors on the front elevation. The revised design now includes simply detailed wood brackets on either side of pair of doors. Staff finds stylized wood brackets are found throughout the historic district in many of the Tudor Revival houses; and while none are on the subject property, Staff finds this to be a compatible feature and recommends the HPC approve the brackets under the *Design Guidelines*, 24A-8(b)(2) and (d), and

Standards 2, 9, and 10.

Hardscaping

On the front and rear sides of the garage, the applicant proposes to install a 2' (two-foot) wide walkway using variegated flagstones. The flagstones will connect to an existing walkway to the house. The previous approval did not include any paving.



Figure 2: Proposed walkway material.

The *Design Guidelines* state that new paving for walkways and patios should be 'minimized' to limit the total amount of impervious surface. Staff does not find the proposed walkways to be out of character nor does Staff find the walkways are larger than necessary. Staff recommends the HPC approve the walkway under the *Design Guidelines*; 24A-8(b)(2) and (d); and Standards 2, 9, and 10.

STAFF RECOMMENDATION

Staff recommends that the Commission <u>approve</u> the HAWP application; under the Criteria for Issuance in Chapter 24A-8(b)(2) and (d), having found that the proposal is consistent with the *Greenwich Forest Historic District Guidelines* identified above, and therefore will not substantially alter the exterior features of the historic resource and is compatible in character with the district and the purposes of Chapter 24A;

and with the Secretary of the Interior's Standards for Rehabilitation #2, 9, and 10;

and with the general condition that the applicant shall present an electronic set of drawings, if applicable, to Historic Preservation Commission (HPC) staff for review and stamping prior to submission for the Montgomery County Department of Permitting Services (DPS) building permits;

and with the general condition that final project design details, not specifically delineated by the Commission, shall be approved by HPC staff or brought back to the Commission as a revised HAWP application at staff's discretion;

and with the general condition that the applicant shall notify the Historic Preservation Staff if they propose to make any alterations to the approved plans. Once the work is completed the applicant will contact the staff person assigned to this application at 301-563-3400 or

 $\underline{dan.bruechert@montgomeryplanning.org}\ to\ schedule\ a\ follow-up\ site\ visit.$

For Staff only:



HAWP#_____ Date assigned_____

APPLICATION FOR HISTORIC AREA WORK PERMIT

HISTORIC PRESERVATION COMMISSION 301.563.3400

APPLICAN	Γ:				
Name: Adar	n Sherwat & Chuer	ı-Yen Lau	E-mail:	adamsherwat@yah	oo.com
Address: 8000 Hampden Lane			City: Be	thesda	Zip: 20814_
	one: 202-669-4898 NTACT (if applica		Тах Асс	count No.: 00497536	; ;
Name:			E-mail:		
Address:			City:		Zip:
Daytime Ph LOCATION	one: OF BUILDING/PR	EMISE: MIHP # of H		ctor Registration No. rty: M:35-165	ii
Is the Prope	erty Located within	an Historic District	•	rict Name: Greenwic dual Site Name	
		on/Land Trust/Envi cumentation from th		_	-
(Conditional supplements of Lot 1, Blook 12, Block 12 submitted to 15.)	l Use, Variance, Recal information. NC ock L, Greenwich Fo 2, English Village, B	aring Examiner Approord Plat, etc.?) If YE D. However, please no rest + Part of Lot 15 and product of the proof of the pr	S, include info tote that recor S, Block 12, En ogress. The "S	ormation on these re rding of a minor sub- Iglish Village, Bradle ubdivision Record P	eviews as division comprised y Hills + Part of Lot 'lat Application" was
Building Nu	mber: 8000	Street: Hampde	en Lane		
Town/City:	Bethesda	Nearest Cross S	Street: York La	ane	
Lot: 1	Block: L	Subdivision: Green	wich Forest	Parcel: Unknown	

TYPE OF WORK PROPOSED: See the checklist on Page 4 to verify that all supporting items for proposed work are submitted with this application. Incomplete Applications will not

be accepted for review. Ch	Shed/Garage/Accessory Structure XX	
New Construction XX	Deck/Porch	Solar
AdditionFence	Tree removal/planting	
Demolition	Hardscape/Landscape	Window/Door
Grading/Excavation	Roof	Other:
correct and accurate and th	nat the construction will comply w	ng application, that the application is with plans reviewed and approved by all to be a condition for the issuance of this
Signature of ow	ner or authorized agent	Date

HAWP APPLICATION: MAILING ADDRESSES FOR NOTIFING

[Owner, Owner's Agent, Adjacent and Confronting Property Owners]


Owner's mailing address	Owner's Agent's mailing address				
Adam Sherwat and Chuen-Yen Lau					
8000 Hampden					
Bethesda, MD, 20814					
Adjacent and confronting Property Owners mailing addresses					
Bob and Debbie Bruskin	Belinda Lai and Steve Cowan				
5619 York Lane	8004 Hampden Lane				
Bethesda, MD 20814	Bethesda, MD 20814				
Bruce Sidner and Nancy Butte	8009 Hampden Lane Bethesda, MD 20814 7835 Hampden Lane Behtesda, MD 20814				
7836 Hampden Lane					
Bethesda, MD 20814					
Betriesda, Wib 20014					
007 Aberdeen Road Bethesda MD 20814					
001 Aberdeen Road Bethesda, MD 20814					
837 Aberdeen Road Bethesda, MD 20814					

Description of Property: Please describe the building and surrounding environment. Include information on significant structures, landscape features, or other significant features of the property:

1938 Colonial Revival-style single family home, stone on front face, white brick on main house, siding on 1988 addition, slate roof. Two stories with partial basement. Has dormers on front and side. Two brick chimneys. Inside with wood floors, 3 fireplaces (2 marble and 1 stone), 4 bedrooms. Bifurcating stairwell to upstairs bedrooms. Outside has garden landscaping and slate and brick walkways.

Description of Work Proposed: Construction of an accessory structure consisting of a detached garage with a workshop. Please refer to the addendum titled "Accessory Structure Justification" describing the proposal in detail.

Work Item 1: Detached Garage/Works	shop
Description of Current Condition: No detached garage/workshop	Proposed Work: Construction of an accessory structure consisting of a detached garage with a workshop. Please refer to the addendum titled "Accessory Structure Justification" describing the proposal in detail.
Work Item 2:	
Description of Current Condition:	Proposed Work:
Work Item 3:	

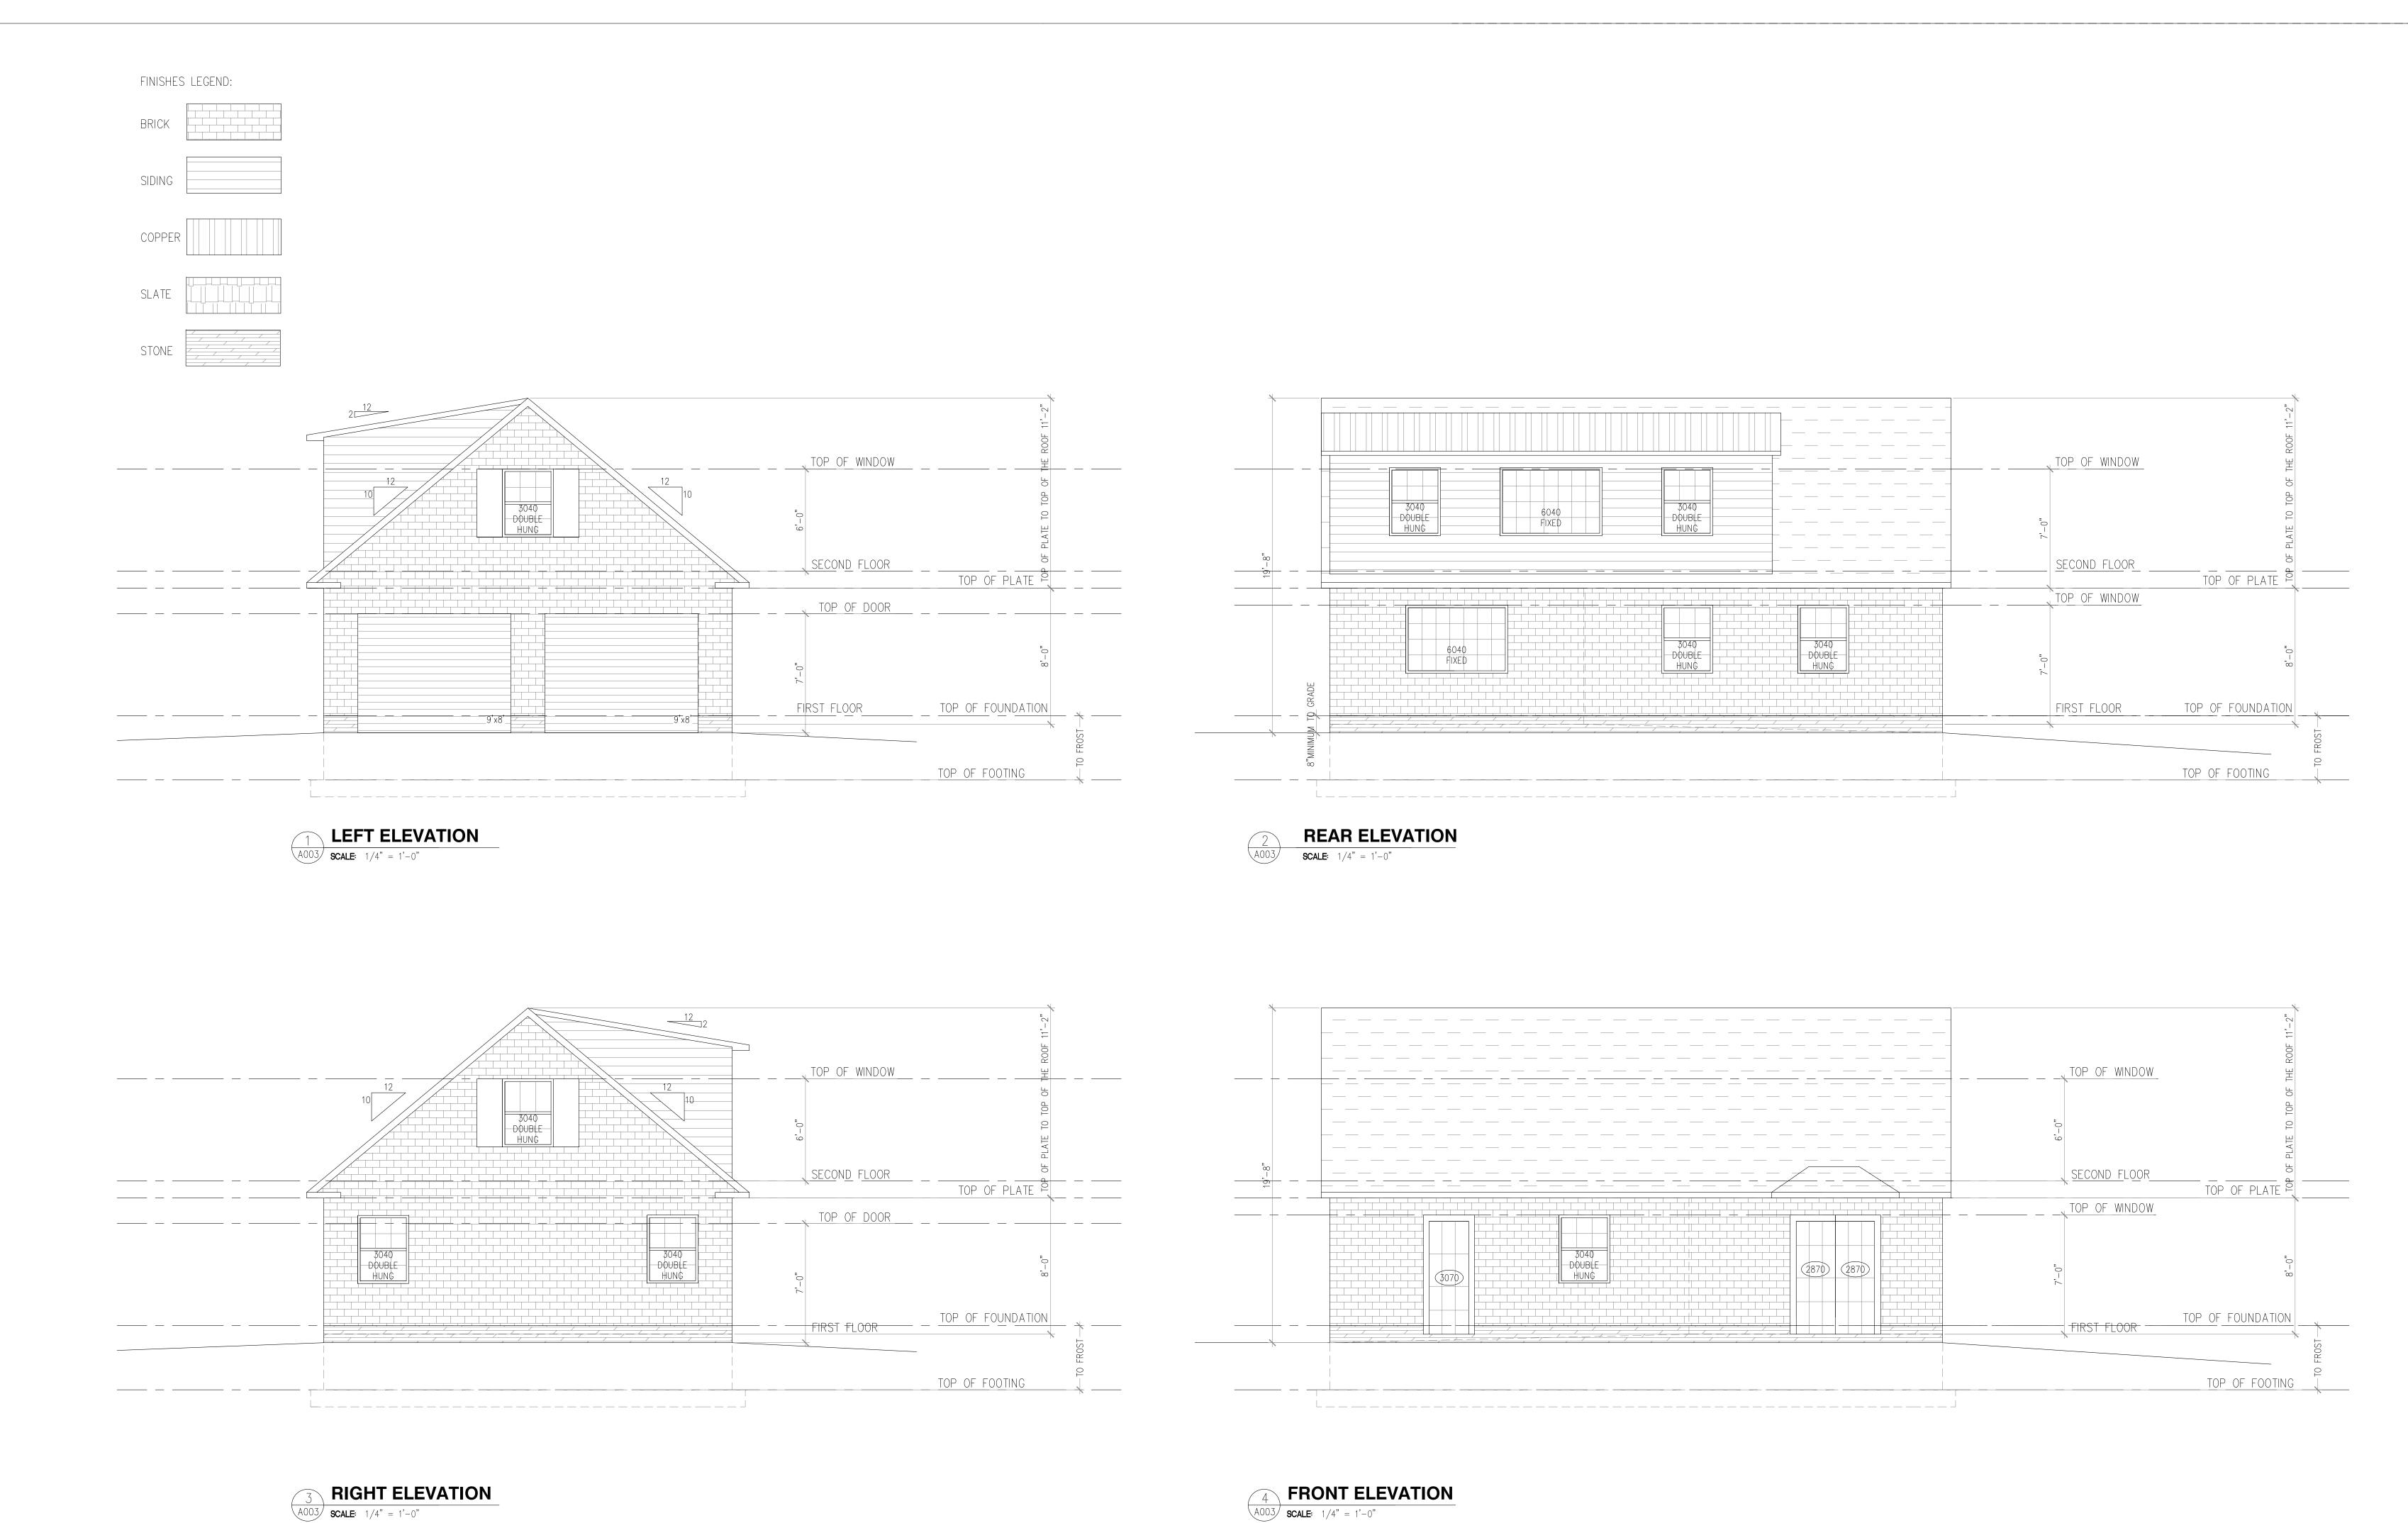

2023 HAWP Approval

Professional Certification:

I hereby certify that these drawings where prepared or approved by me, and that I am a duly licensed Architect under the laws of state of Maryland, License Number 19936, Expiration Date 05/26/2023.

DESIGN DEVELOPMENT

Not for Construction

ALL ARCHITECTURAL DESIGN, DRAWINGS, REPOR SPECIFICATIONS, COMPUTER FILES, FIELD DATA, AND ANY OTHER DOCUMENTS PREPARED BY THE ARCHITECT AS INSTRUMENTS OF SERVICE SHALL THE PROPERTY OF THE ARCHITECT AND IS NOT TREPRODUCED, COPIED OR ALTERED IN WHOLE OF IT IS ONLY TO BE USED FOR THE PROJECT AND SPECIFICALLY IDENTIFIED HEREIN AND IS NOT TOON ANY OTHER PROJECT.

THE ARCHITECT SHALL RETAIN ALL COMMON LAW COPYRIGHT AND OTHER RESERVED RIGHTS THER WRITTEN DIMENSIONS SHALL HAVE PRECEDENCE SCALE.



ACCESSORY STRUCTURE
LAU & SHERWAT
RESIDENCE

8000 HAMPDEN LN BETHESDA, MD. 20814

ATIONS

NORTH


DRAWN BY:

DATE:

03/24/2023


REVISIONS

A003

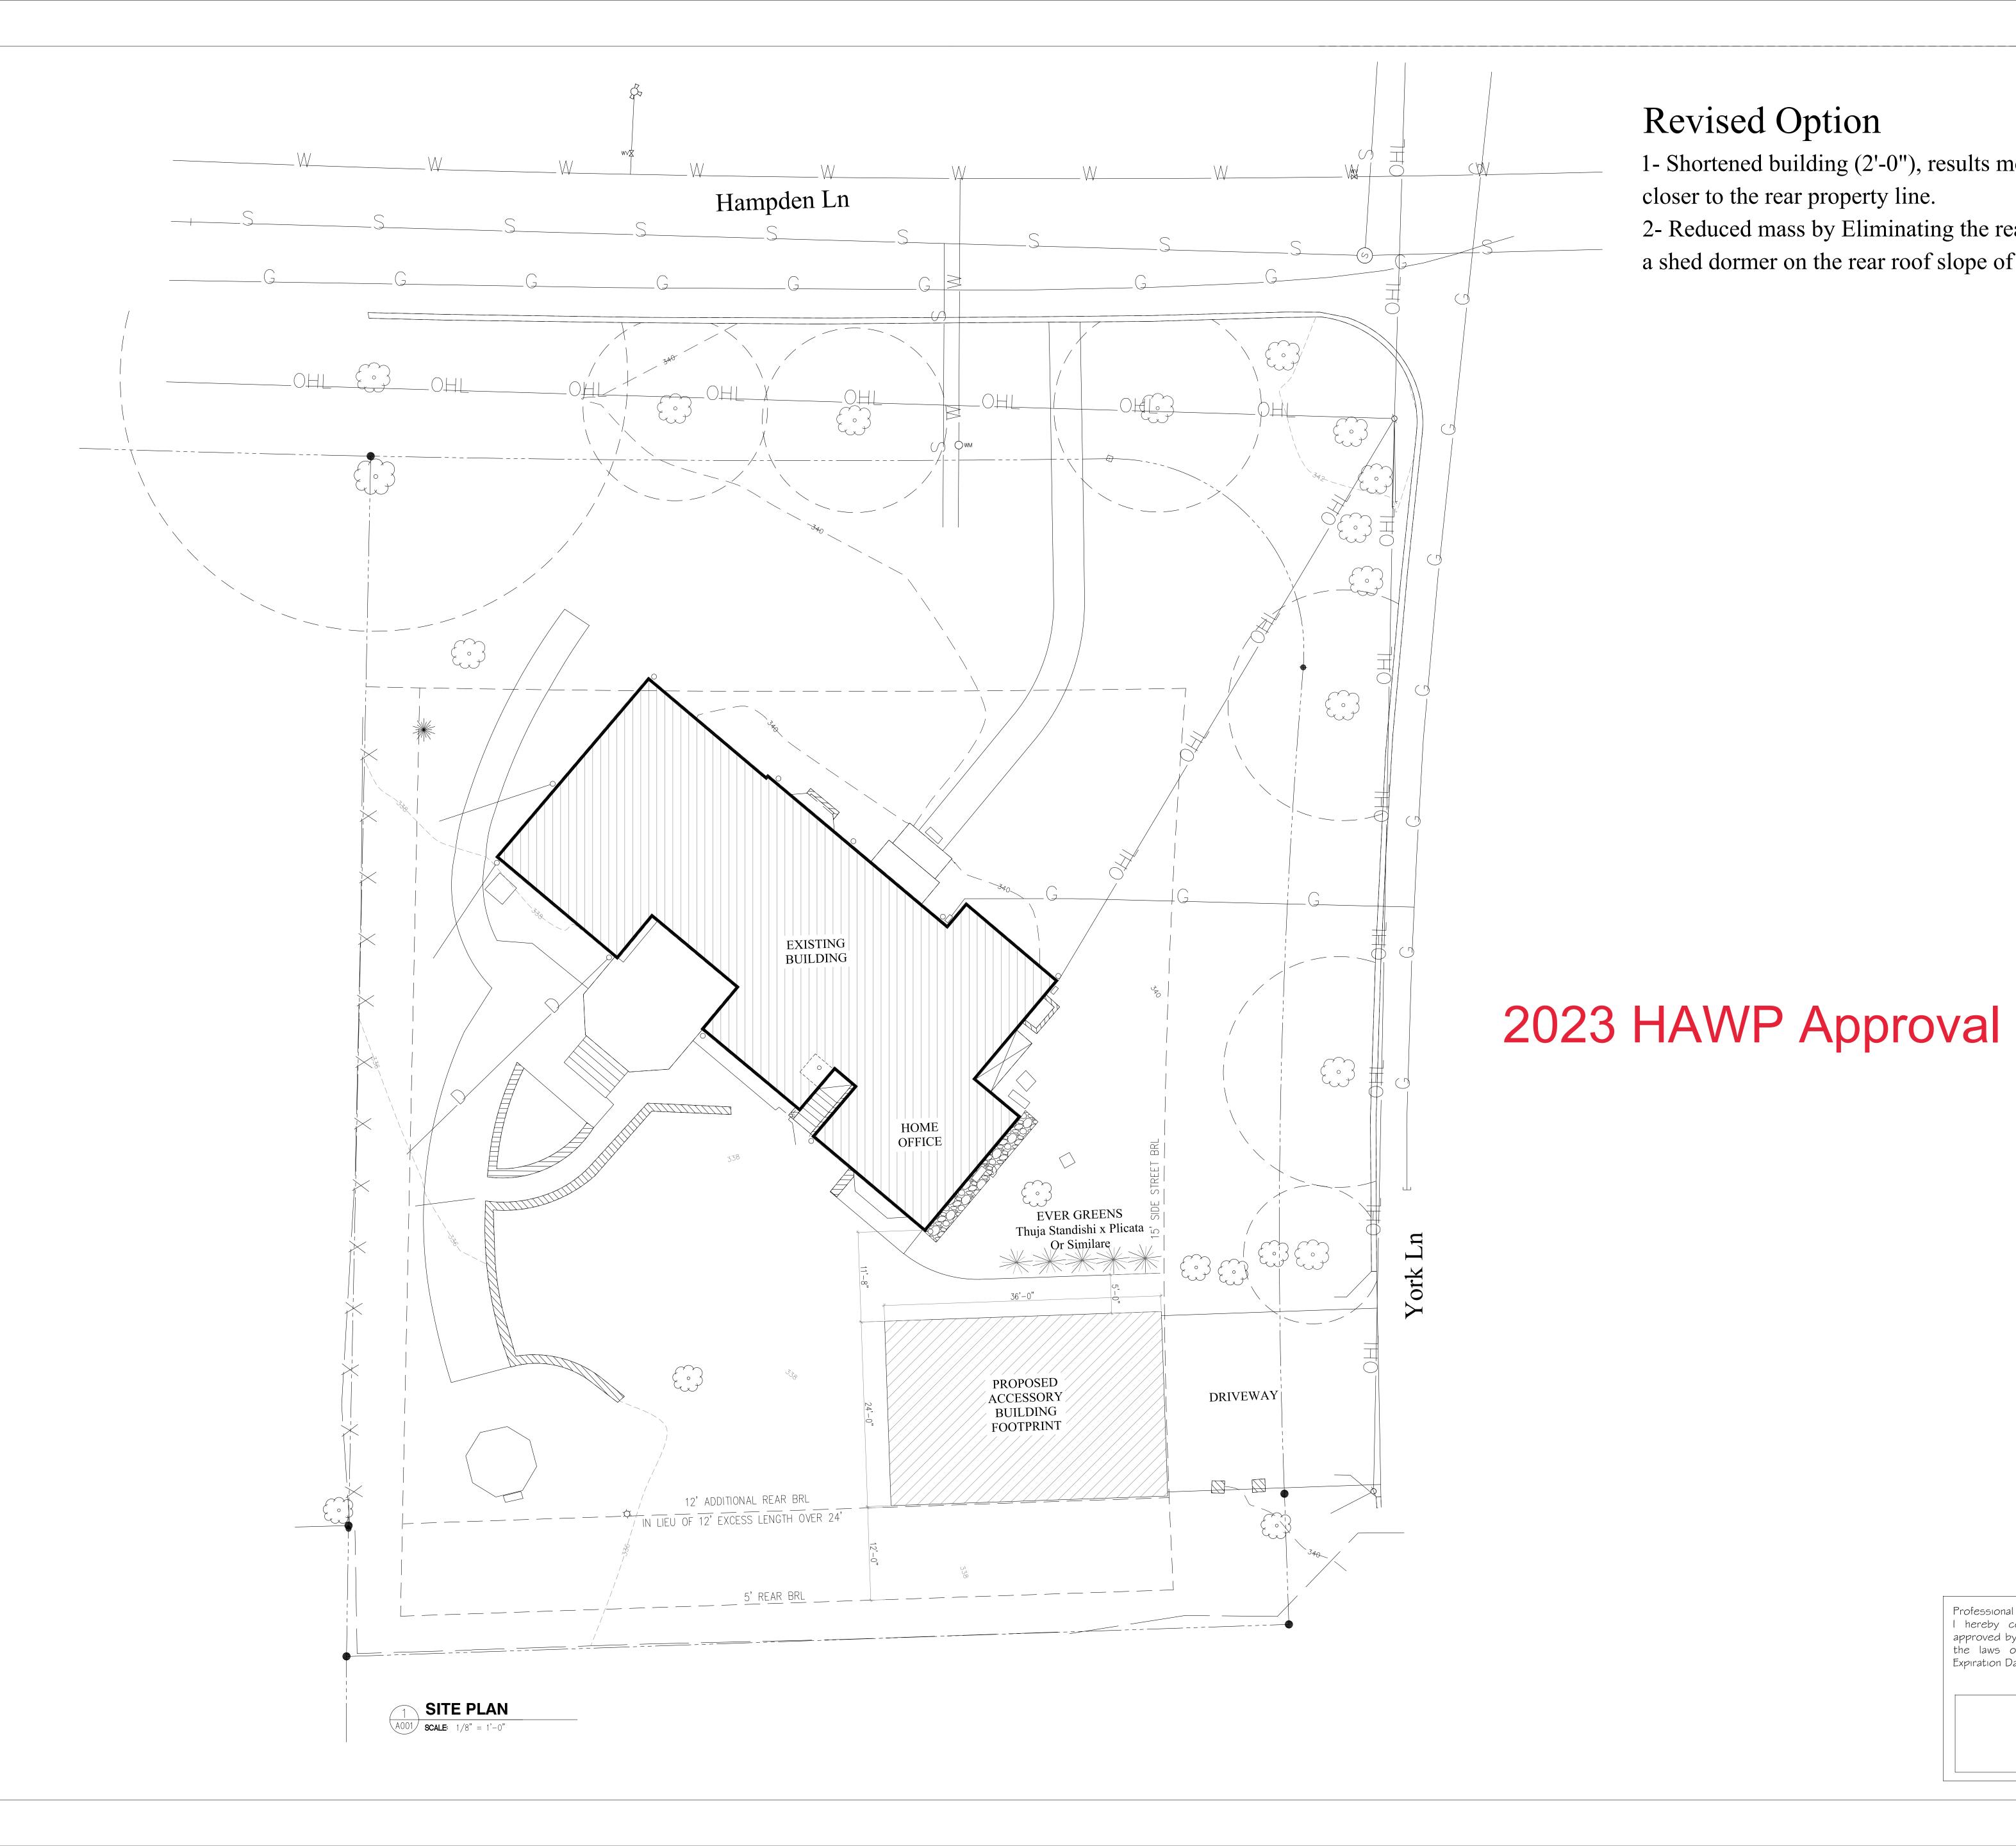

Revised Option

- 1- Shortened building (2'-0"), results moving the building 2' closer to the rear property line.
- 2- Reduced mass by Eliminating the rear cross gable and utilizing a shed dormer on the rear roof slope of the accessory structure.

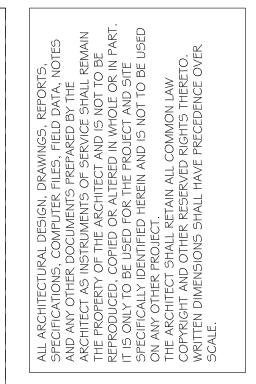



ACCESSORY STRUCTURE
LAU & SHERWAT
RESIDENCE

8000 HAMPDEN LN BETHESDA, MD. 20814

DRAWN BY:

DATE:

03/24/2023


REVISIONS

A001

Professional Certification: I hereby certify that these drawings where prepared or approved by me, and that I am a duly licensed Architect under the laws of state of Maryland, License Number 19936, Expiration Date 05/26/2023.

DESIGN DEVELOPMENT

NOT FOR CONSTRUCTION

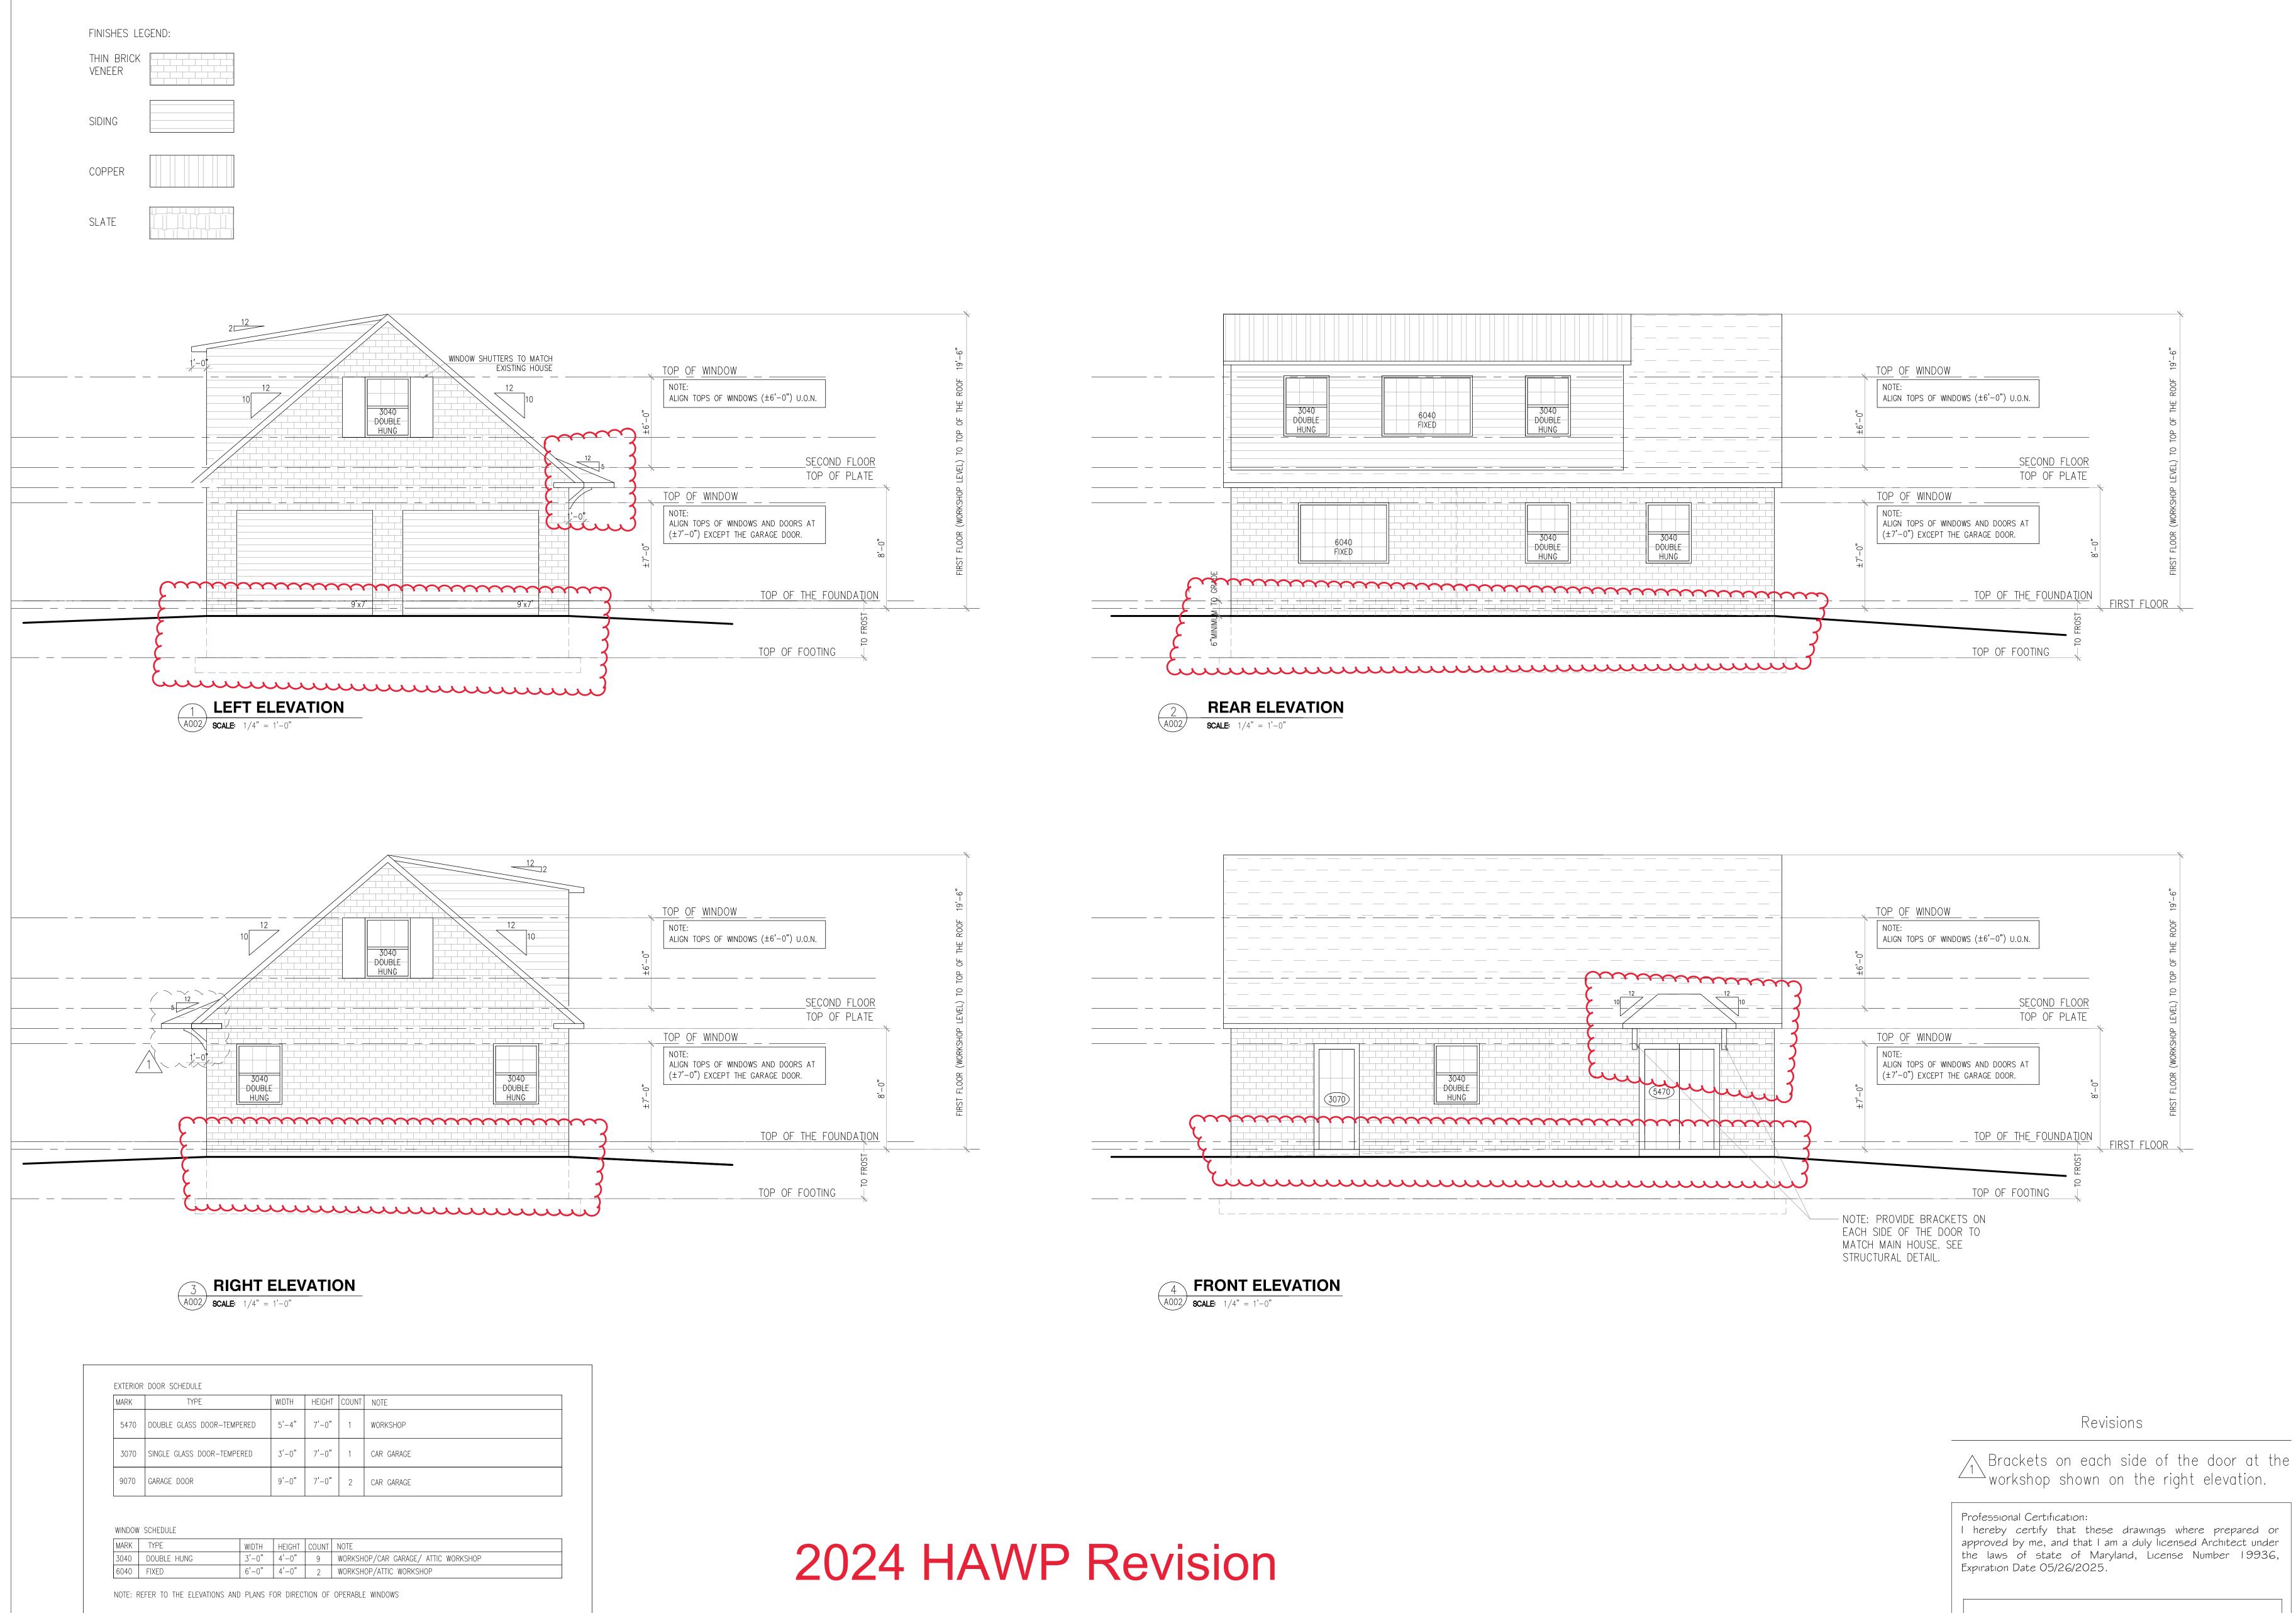


ARCHITECTURE

5425 WISCONSIN AVE #600 Chevy Chase, MD 20815 (202) 860-7050

> ACCESSORY STRUCTURE LAU & SHERWAT RESIDENCE

8000 HAMPDEN LN BETHESDA, MD. 20814

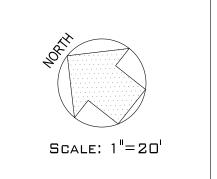

DRAWN BY:

DATE:

08/28/2023

REVISIONS

01/17/2024

ADDZ

GENERAL NOTES Boundary information and two-foot contour data are based upon surveys performed by CAS Éngineering, dated June, 2022. Total lot area: Lot 13 = 18,471 sq. ft. Property is located on Tax Map HN123 and WSSC 200' Sheet 210NW05. Property is located on Soils Survey Map Number 27. Soil type(s): 2UB, Glenelg-Urban Land Complex, HSG "B". Flood zone "X" per F.E.M.A. Firm Maps, Community Panel Number 24031C0455D. Property is located in the Cabin John Creek Watershed, Use Class I, P. Water Category - 1, Sewer Category - 1 Local utilities include: Water / Sewer - Washington Suburban Sanitary Commission Electric - PEPCO Telephone - Verizon Gas - Washington Gas Property is not located in a Special Protection Area. 10. Property is located in the Greenwich Historic District. **ZONING DATA** Zoning: R-90 Hampden Front B.R.L. = 30 ft. Minimum Lot Area = 9,000 sq. ft. York Lane Front B.R.L. = 15 ft. [1] Minimum Lot Width at R/W = 25 ft. Minimum Lot Width at B.R.L. = 75 ft. Rear B.R.L. = 25 ft. Side B.R.L. = 8 ft. min., 25 ft. total Minimum Accessory Structure Side/Rear Setback = 5 ft.[2] [1] Per Montgomery County Code Section 4.4.8.B.2 of the Zoning Ordinance, the abutting lot along York Lane Right-of-Way fronts on Aberdeen Road and not on York Lane therefore qualifying this as a 15-ft [2] Per Montgomery County Code Section 4.4.8.B.2 of the Zoning Ordinance, additional setbacks may apply for structures taller than 15-feet and/or longer than 24-feet. Verify (Non-Infill) lot coverage in accordance with the Zoning Ordinance. Coverage is the area of a lot or site occupied by a building, including an accessory building, structured parking, or other roofed structure such as a porch, patio, deck, or steps. Coverage does not include paved areas such as a driveway, a pedestrian walkway, a bay window measuring 10 feet in width or less and 3 feet in depth or less, an uncovered porch or patio, deck, a swimming pool, or roof overhang. Allowable Lot Coverage: 30% of total lot area. Lot 13 = 18,471 sq. ft. (Per Plat) 18,471 x 0.30 = 5,541.3 Allowable area to be covered by buildings (including acc. buildings) = 5.541.3 sq. ft Total area covered by buildings = 3,017 sq. ft. Verify lot coverage in accordance with Greenwich Forest Master Plan. Allowable Accessory Structure Lot Coverage: 7% of total lot area (since accessory structure and house will not exceed 30% lot coverage) Lot 13 = 18,471 sq. ft. (Per Plat) 18,471 x 0.07 =1,292.9 sq. ft. Allowable area to be covered by accessory structures = 1,292.9 sq. ft Total area covered by accessory buildings = 862 sq. ft. Verify accessory structure side / rear setback requirements in accordance with the Per Section 4.4.8.B(2)(c), any accessory structure with a length along a rear or side lot line that is longer than 24', the minimum side or rear setback must be increased at a ratio of 2' for every 2' that the dimension exceeds 24 linear feet. Since length along the side property line is greater than 24' (36'-0" proposed), minimum side setback to be increased at 1:1 36.00 ft. - 24.00 ft. = 12 ft 12 ft additional setback (beyond 5' min) Verify accessory structure mean height in accordance with the Zoning Ordinance. Mean height of accessory structure from first floor: Elevation at mean height of accessory structure Average elevation along front of accessory structure Mean height of accessory structure = 358.75 - 340.15 = 18.60 feet Allowable mean height accessory structure = 15 feet (for 5 ft. setbacks) Proposed mean height of accessory structure = 18.60 feet Per Section 4.4.8.B(2)(b), any accessory structure with a height greater than 15', the minimum side and rear setback must be increased at a ratio of 2' for every 1' that the height exceeds 15 feet. 18.60 ft. - 15.00 ft. = 3.6 ft 3.6 ft * 2 = 7.2 ft additional setback (beyond 5' min) Minimum side/rear setback for accessory structure is 12.2 ft Verify accessory structure peak height in accordance with the Zoning Ordinance. First floor elevation Height of accessory structure to highest point: Elevation at highest point of accessory structure Average elevation along front of accessory structure 340.15 ft Height of accessory structure to highest point = 360.00 - 340.15 = 19.85 feet Allowable accessory structure height = 20 feet Proposed height of accessory structure to highest point = 19.85 feet Peak height cannot exceed 20.0 feet.

EXISTING FEATURES

Ex. Sewer Manhole and Invert Ex. Water Line with Valve

Ex. Overhead Utility with Pole

Ex. Downspout Piped / Spilled

Ex. Two- And Ten-foot Contours

Ex. Wood or Stockade Fence

UTILITY INFORMATION

EXISTING UNDERGROUND UTILITY LOCATIONS ARE APPROXIMATE AND

AVAILABLE RECORDS AND ARE SHOWN TO THE BEST OF OUR ABILITY.

FOR LOCATION OF UTILITIES, CALL "MISS UTILITY" AT 1-800-257-7777, OR LOG ON TO WWW.MISSUTILITY.NET/ITIC 48 HOURS IN ADVANCE OF ANY WORK IN THIS VICINITY. THE EXCAVATOR MUST NOTIFY ALL PUBLIC UTILITY COMPANIES WITH UNDER GROUND FACILITIES IN THE AREA OF PROPOSED EXCAVATION AND HAVE THOSE FACILITIES LOCATED BY THE UTILITY COMPANIES PRIOR TO COMMENCING EXCAVATION. THE EXCAVATOR IS RESPONSIBLE FOR COMPLIANCE WITH REQUIREMENTS OF CHAPTER 36A OF THE MONTGOMERY COUNTY CODE.

MUST BE FIELD VERIFIED. UTILITY LOCATIONS ARE BASED UPON


Ex. Metal or Iron Fence

Ex. Tree (<24" DBH)

Ex. Roadside Tree or

Ex. Significant Tree

Ex. Specimen Tree

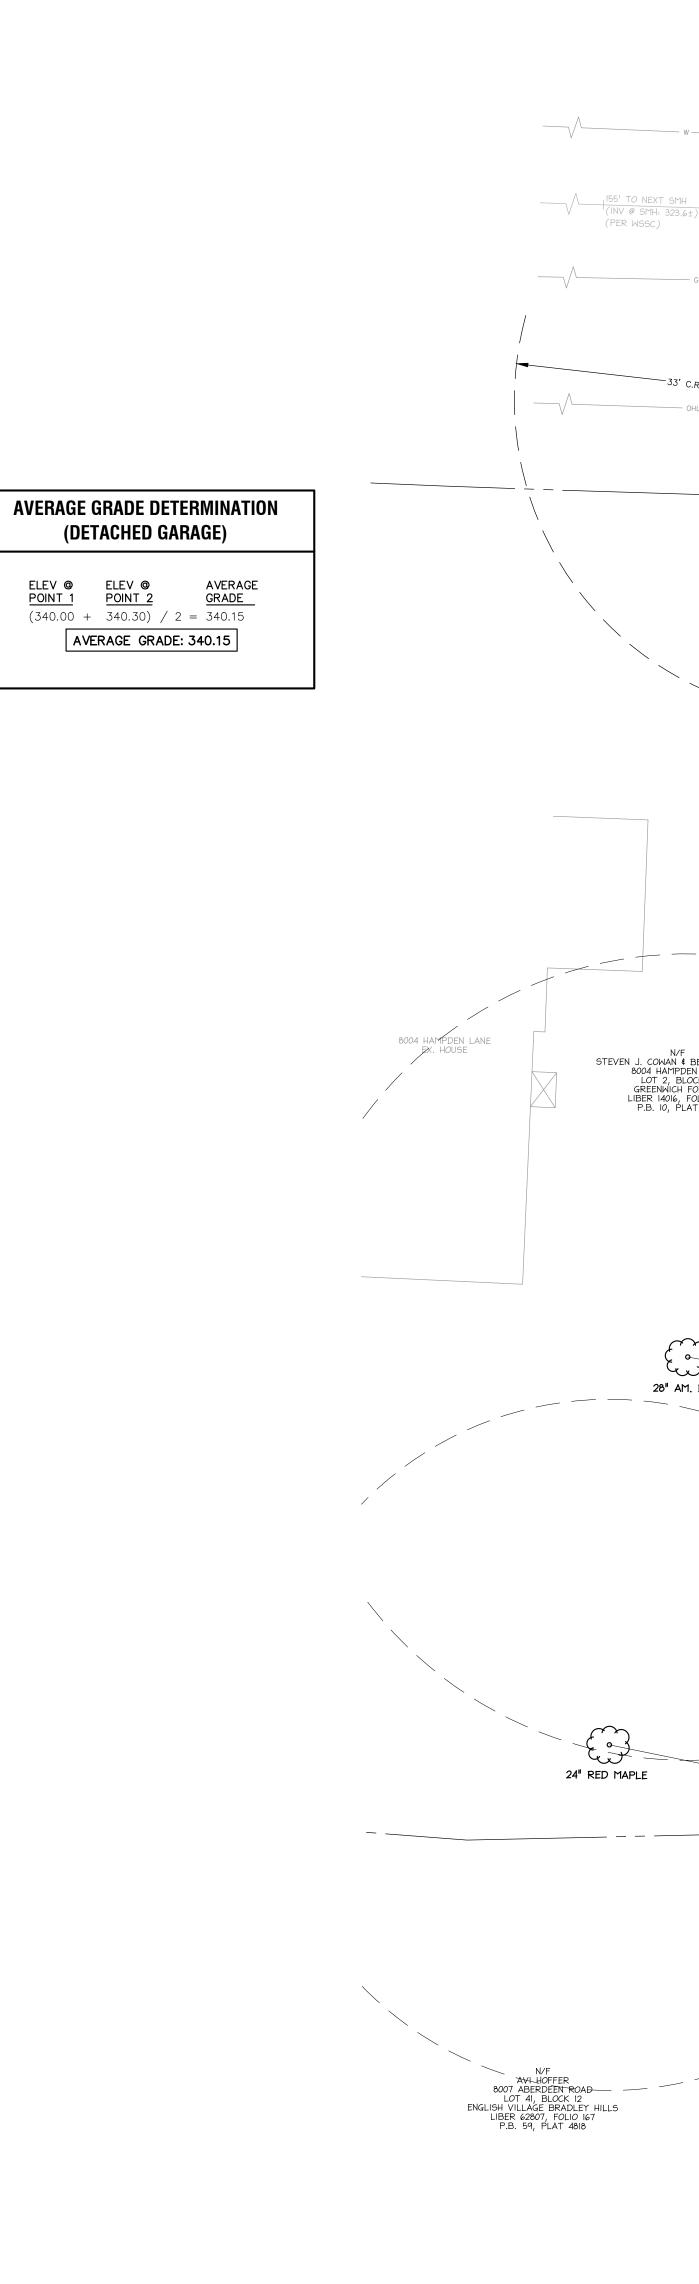


(DETACHED GARAGE)

AVERAGE GRADE: 340.15


ELEV @ POINT 2

EX. EDGE OF WATER EX. 8" SEWER @ 2.1%± EX. CONC. CURB & GUTTER L=96.04' R=2865.00' APPROX. LOCATION OF PROPOSED AMERICAN BEECH REQUIRED BY GREENWICH FOREST HISTORIC COMMISSION EX.DOWNSPOUT PIPE TO BE REROUTED AROUND PROPOSED GARAGE AND TO REAR YARD. 28" AM. BEECH PROP. GARAGE FF: 340.5 N 22°59'00" W 122.52' N/F
DAVID D. \$ E. B. SEAGRAVES
8001 ABERDEEN ROAD
LOT 42, BLOCK 12
ENGLISH VILLAGE BRADLEY HILLS
LIBER 13297, FOLIO 416
P.B. 59, PLAT 4818

2024 HAWP Revision

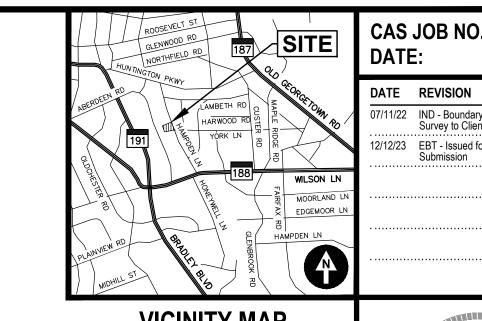

ADC MAP 5407, GRID B-2, SCALE: 1" = 2000'

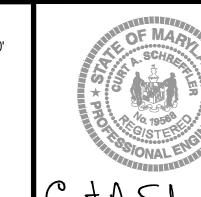

CURT A. SCHREFFLER, PE PROFESSIONAL ENGINEER CERTIFICATION: I hereby certify that these documents were prepared or approved by me, and that I am a duly licensed professional engineer under the laws of the State of Maryland, License No. 19568,

11/22 IND - Boundary and Topographic Survey to Client, Builder, and Architect.

2/12/23 EBT - Issued for Building Permit

expiration date 3/8/2024, and that this plan meets MCDPS criteria for building and sediment control permit applications.

8000 Hampden I Sethesda, Maryland

Washington, DC 20007 202-393-7200 Phone info@cas-dc.com

OWNER/APPLICANT

8000 Hampden Lane

Bethesda, MD 20814

chuenyenlau@hotmail.com

adamsherwat@yahoo.com

Chuen-Yen Lau & Adam Sherwat Elie Ben Architecture, LLC

8000 Hampden Lane

Building Permit Site Plan

Bethesda, MD 20814

Attn: Maryam Tabrizchi

Lot 13, Block L, Greenwich Forest -Greenwich Forest Historic District-

maryam@eliebenarch.com

R

Building Permit Site Plan


1 OF 1

CAS ENGINEERING-MD 10 South Bentz Street Frederick, Maryland 21701 301-607-8031 Phone www.casengineering.com CAS ENGINEERING-DC, LLC 4836 MacArthur Boulevard, NW, 2nd Floo

www.cas-dc.com

SCALE: 1 INCH = 10 FEET

SHEET TITLE:

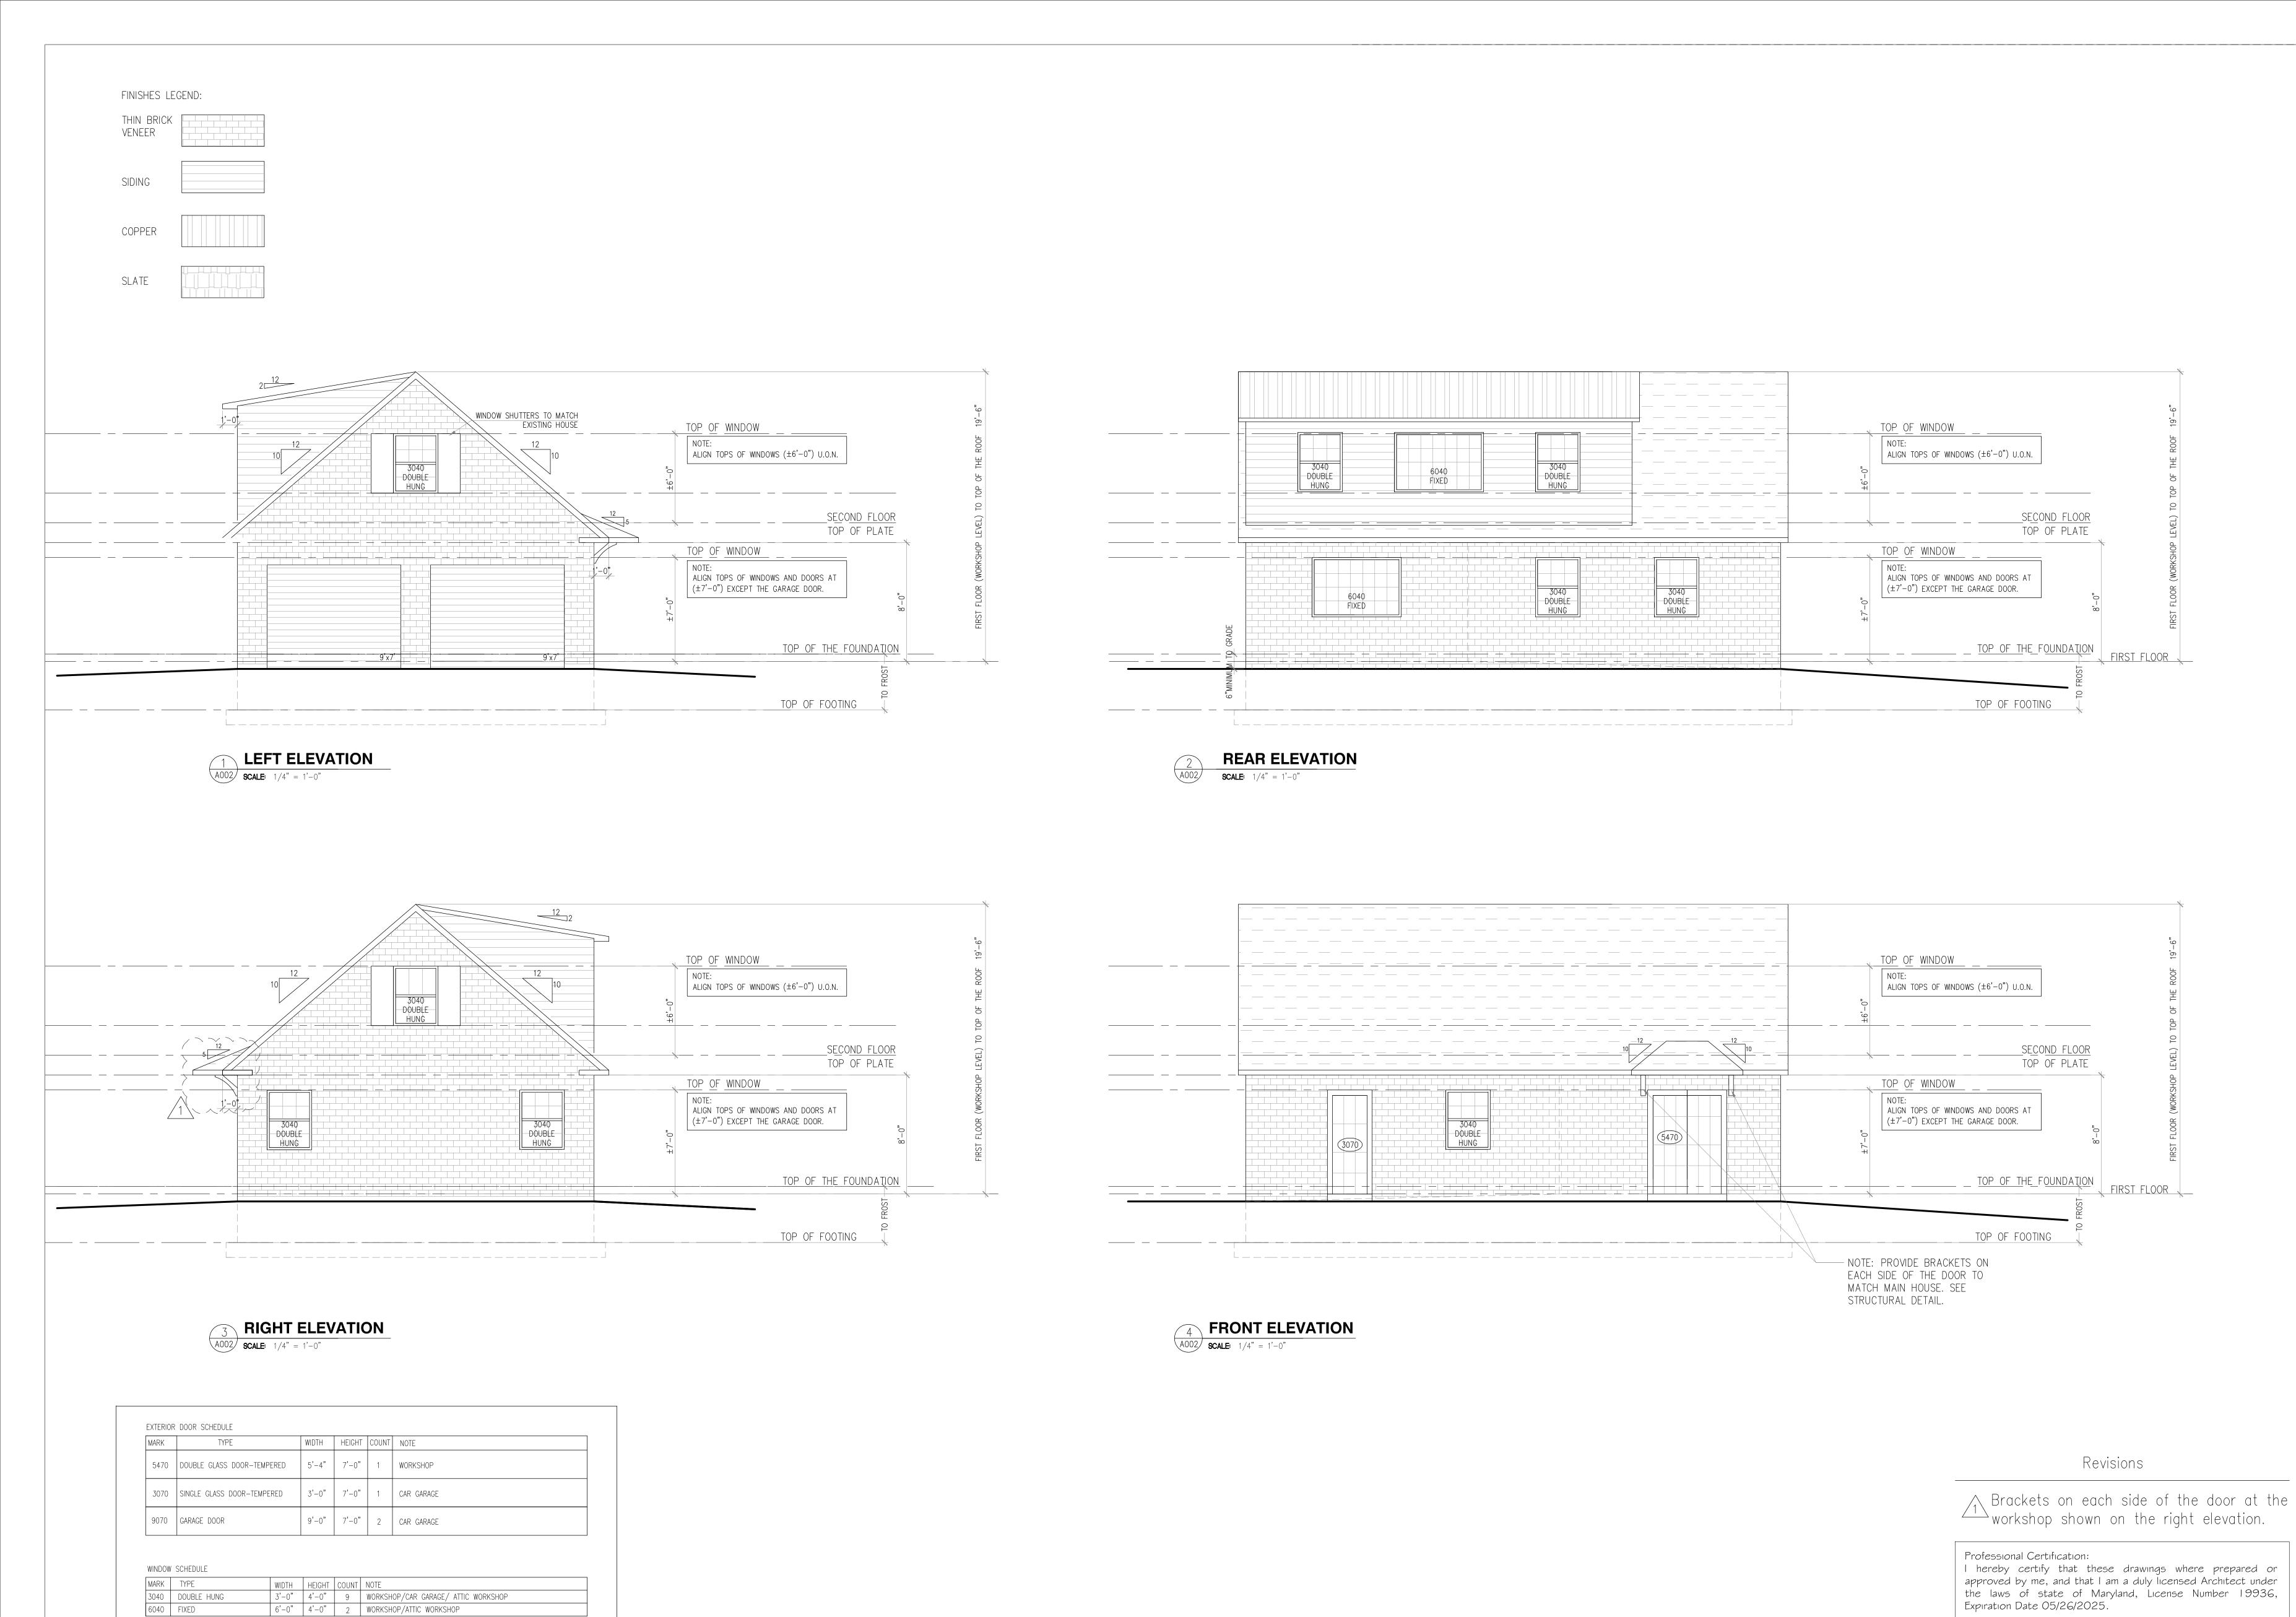

NOTE: REFER TO THE ELEVATIONS AND PLANS FOR DIRECTION OF OPERABLE WINDOWS

ARCHITECTURE

5425 WISCONSIN AVE #600 Chevy Chase, MD 20815 (202) 860-7050

Accessory Structure LAU & SHERWAT RESIDENCE

8000 HAMPDEN LN

BETHESDA, MD. 20814

SCALE: 1"=20'

DRAWN BY:

DATE:

08/28/2023

REVISIONS

01/17/2024

I hereby certify that these drawings where prepared or approved by me, and that I am a duly licensed Architect under the laws of state of Maryland, License Number 19936,

A002