EXPEDITED MONTGOMERY COUNTY HISTORIC PRESERVATION COMMISSION STAFF REPORT

Address: 17800 Bowie Mill Road, Derwood Meeting Date: 2/2/2022

Resource: (Master Plan Site #22/017-000A **Report Date:** 1/26//2022

Flint Hill II

Public Notice: 1/19/2022

Applicant: Leigh Dukatt

Tax Credit: No


Review: HAWP

Staff: Michael Kyne

Permit Number: 978966

PROPOSAL: Installation of new telecommunications equipment

STAFF RECOMMENDATION:

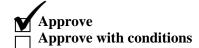

ARCHITECTURAL DESCRIPTION:

SIGNIFICANCE: Master Plan Site #22/017-000A, Flint Hill II

DATE: Early 1800s; c1860-75

Excerpt from *Places from the Past:*

Situated on a rise above Bowie Mill Road, Flint Hill is one of three houses in the Olney area that was associated in the early- to mid-1800s with the Bowie family. Washington Bowie, wealthy Georgetown shipping merchant, purchased 2,000 acres of land in 1820 and established a farm at Oatland. His son, Thomas Johns Bowie built Roseneath between 1825 and 1830 on 600 acres. While Thomas' eldest son, Washington Bowie III, inherited Roseneath, another son Thomas Johns Davis Bowie, inherited Flint Hill.

The house was constructed in several sections. The earliest part is the rear section, which is of log construction, said to be chinked with brick. The log house was built before the Bowie's 1820 purchase of the property. The exterior chimney on this section has an asymmetrical stone base with a brick stack. The main block, built c1860-75, is one room deep with a center passage plan. Italianate-style influence is evident in oversize scrolled brackets at the roof cornice and prominent window cornices. The front (east) door opens into a central hall with open-string, double-run staircase with a turned newel post and golden oak banister. A large bank barn is dated 1898.



Fig. 1: Subject property.

PROPOSAL:

The applicant proposes to modify the existing collocation telecommunications equipment on the non-contributing silo at the subject property. Specific work items include:

- Removal of three existing antennas.
- Installation of six new antennas.
- Installation of six new Remote Radio Units (RRUs).
- Installation of one new equipment cabinet.
- Installation of one new battery cabinet.
- Installation of associated equipment.

Staff notes that the installation of the existing telecommunications equipment was approved by the HPC with the following conditions on June 20, 2001:

- Antenna casing at top of dome to be a matte blue color (Sherwin Williams Exterior Skylar SW2460) to be approved at staff level.
- PVC housing will be attached close to existing loading tube & will match silo color. Shed color to match existing shed.

Staff finds the current proposal consistent with the previous conditions of approval.

APPLICABLE GUIDELINES:

- IV. The Expedited Staff Report format may be used on the following type of cases:
 - 2. Modifications to a property, which do not significantly alter its visual character.

Montgomery County Code; Chapter 24A-8

- (b) The commission shall instruct the director to issue a permit, or issue a permit subject to such conditions as are found to be necessary to ensure conformity with the purposes and requirements of this chapter, if it finds that:
 - (1) The proposal will not substantially alter the exterior features of an historic site or historic resource within an historic district; or
 - (2) The proposal is compatible in character and nature with the historical, archeological, architectural or cultural features of the historic site or the historic district in which an historic resource is located and would not be detrimental thereto or to the achievement of the purposes of this chapter; or
 - (3) The proposal would enhance or aid in the protection, preservation and public or private utilization of the historic site or historic resource located within an historic district in a manner compatible with the historical, archeological, architectural or cultural value of the historic site or historic district in which an historic resource is located; or
 - (4) The proposal is necessary in order that unsafe conditions or health hazards be remedied; or
 - (5) The proposal is necessary in order that the owner of the subject property not be deprived of reasonable use of the property or suffer undue hardship; or
 - (6) In balancing the interests of the public in preserving the historic site or historic resource located within an historic district, with the interests of the public from the use and benefit of the alternative proposal, the general public welfare is better served by granting the permit.
- (c) It is not the intent of this chapter to limit new construction, alteration or repairs to any 1 period or architectural style.

Secretary of Interior's Standards for Rehabilitation

The Secretary of the Interior defines rehabilitation as "the act or process of making possible a compatible use for a property through repair, alterations, and additions while preserving those portions or features, which convey its historical, cultural, or architectural values." The *Standards* are as follows:

- 2. The historic character of a property shall be retained and preserved. The removal of historic materials or alteration of features and spaces that characterize a property shall be avoided.
- 9. New additions, exterior alterations, or related new construction will not destroy historic materials, features, and spatial relationships that characterize the property. The new work shall be differentiated from the old and will be compatible with the historic materials, features, size, scale and proportion, and massing to protect the integrity of the property and its environment.

STAFF RECOMMENDATION:

Staff recommends that the Commission <u>approve</u> the HAWP application under the Criteria for Issuance in Chapter 24A-8(b), (1) & (2), having found that the proposal will not substantially alter the exterior features of the historic resource and is compatible in character with the purposes of Chapter 24A;

and with the Secretary of the Interior's Standards for Rehabilitation #2 and #9;

and with the general condition that the applicant shall present an electronic set of drawings, if applicable, to Historic Preservation Commission (HPC) staff for review and stamping prior to submission for the Montgomery County Department of Permitting Services (DPS) building permits;

and with the general condition that final project design details, not specifically delineated by the Commission, shall be approved by HPC staff or brought back to the Commission as a revised HAWP application at staff's discretion;

and with the general condition that the applicant shall notify the Historic Preservation Staff if they propose to make any alterations to the approved plans. Once the work is completed the applicant will contact the staff person assigned to this application at 301-563-3400 or michael.kyne@montgomeryplanning.org to schedule a follow-up site visit.



APPLICATION FOR HISTORIC AREA WORK PERMIT HISTORIC PRESERVATION COMMISSION

301.563.3400

E-mail: LDukatt@advantageengineers.com_
city: Columbia Zip: 21046
Tax Account No.: 00706980
E-mail:
City: Zip:
Contractor Registration No.:
oric Property 22/017-000A
_Yes/District Name
owie Mill Rd
oss Street: Fraley Farm Rd
n: Parcel:
Page 4 to verify that all supporting items cation. Incomplete Applications will not Shed/Garage/Accessory Structure Solar Tree removal/planting dscape Window/Door ✓ Other: Telecommunications foregoing application, that the application is correct with plans reviewed and approved by all necessary
be a condition for the issuance of this permit.

Adjacent and Confronting Properties:

Derwood, MD 20835

17705 Bowie Mill Road

17709 Bowie Mill Road

17801 Bowie Mill Road

17805 Bowie Mill Road

17801 Fraley Farm Road

5612 Silo Hill Court

5617 Silo Hill Court


17813 Fraley Farm Road

17821 Fraley Farm Road

5612 Silver Oak Court

17834 Fraley Farm Road

18405 Muncaster Road

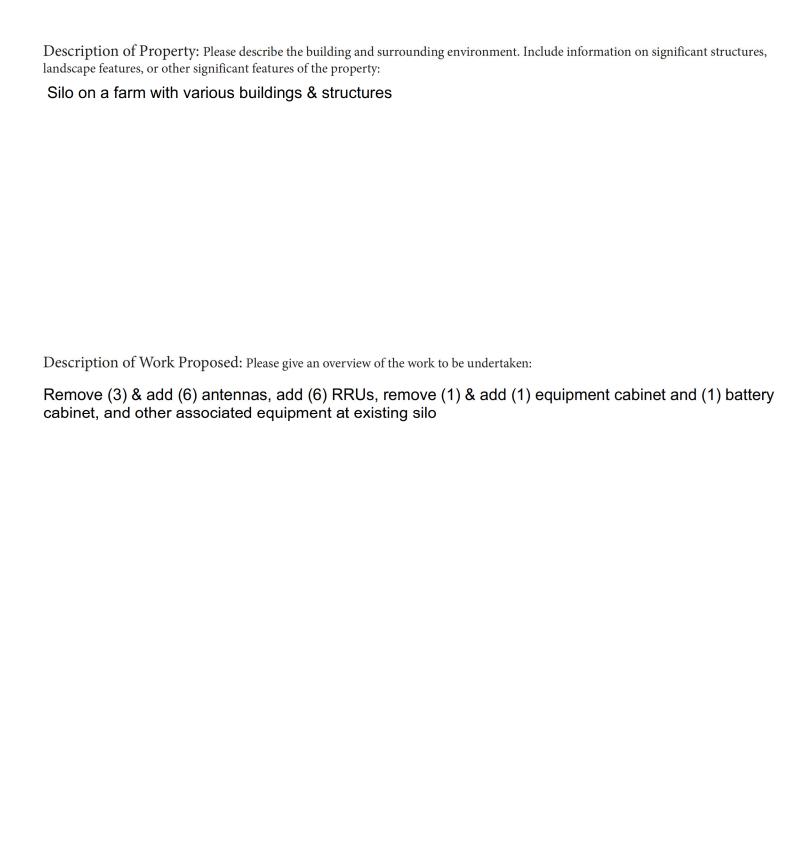

Work Item 1: Telecommunications	
Description of Current Condition: Existing Site for T-Mobile	Proposed Work: Proposed equipment upgrades at existing site for T-Mobile
Work Item 2:	
Description of Current Condition:	Proposed Work:
Work Item 3:	
Description of Current Condition:	Proposed Work:

HISTORIC AREA WORK PERMIT CHECKLIST OF APPLICATION REQUIREMENTS

	Required Attachments						
Proposed Work	I. Written Description	2. Site Plan	3. Plans/ Elevations	4. Material Specifications	5. Photographs	6. Tree Survey	7. Property Owner Addresses
New Construction	*	*	*	*	*	*	*
Additions/ Alterations	*	*	*	*	*	*	*
Demolition	*	*	*		*		*
Deck/Porch	*	*	*	*	*	*	*
Fence/Wall	*	*	*	*	*	*	*
Driveway/ Parking Area	*	*		*	*	*	*
Grading/Exc avation/Land scaing	*	*		*	*	*	*
Tree Removal	*	*		*	*	*	*
Siding/Roof Changes	*	*	*	*	*		*
Window/ Door Changes	*	*	*	*	*		*
Masonry Repair/ Repoint	*	*	*	*	*		*
Signs	*	*	*	*	*		*


T-MOBILE NORTHEAST LLC


FRALEY FAMILY - ROCKVILLE 7WAN162B 67D5A997DB HYBRID

17800 BOWIE MILL ROAD DERWOOD, MARYLAND 28055

SITE	INFORMATION
SITE NUMBER:	7WAN162B
SITE NAME:	FRALEY FAMILY - ROCKVILLE
SITE ADDRESS:	17800 BOWIE MILL ROAD DERWOOD, MARYLAND 28055
ZONING DISTRICT:	RE-1
TAX MAP:	HT22/P222
JURISDICTION:	MONTGOMERY COUNTY, MARYLAND
SITE COORDINATES:	N 39° 09' 0.49" (NAD 83) W 77° 06' 51.55" (NAD 83)
GROUND ELEVATION:	498'± (NAVD 88)
STRUCTURE TYPE:	SILO
STRUCTURE HEIGHT:	73'± AGL (TOP OF EXISTING SILO)
ANTENNA RAD CENTER:	78'-0"± AGL
TENANT:	T-MOBILE NORTHEAST LLC 12050 BALTIMORE AVENUE BELTSVILLE, MARYLAND 20705
OWNER'S NAME:	HARRY FRALEY ET AL
OWNER'S ADDRESS:	17800 BOWIE MILL ROAD ROCKVILLE, MARYLAND 20855-1609

CO	DE ANALYSIS	
BUILDING CODE:	IBC 2018	
ELECTRICAL CODE:	NFPA 70, NEC 2014	
FIRE CODE:	2015 NFPA 101	
USE GROUP:	U (UTILITY)	
CONSTRUCTION TYPE:	IIB	

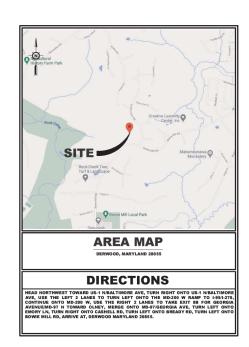

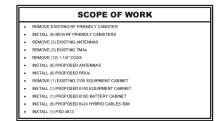

SHEET INDEX		
DRAWING SHEET	DRAWING TITLE	
T-1	TITLE SHEET	
Z-1	SITE PLAN	
S-1	COMPOUND PLAN	
S-2	SILO ELEVATION	
A-1	ANTENNA PLAN & NOTES	
A-2	PLUMBING DIAGRAM & CABLES	
A-3	PROPOSED & EXISTING EQUIPMENT CABINET LAYOUT	
A-4	DETAILS	
D-1	6160 EQUIPMENT CABINET DETAIL	
D-2	B160 BATTERY CABINET DETAIL	
G-1	GROUNDING DIAGRAM & DETAILS	
E-1	ELECTRICAL DETAILS	
E-2	ELECTRICAL NOTES	

DO NOT SCALE DRAWINGS CONTRACTOR IS TO VERIFY ALL PLANS, EXISTING DIMENSIONS & CONDITIONS RELATING TO THIS PROJECT. CONTRACTOR SHALL IMMEDIATELY NOTIFY THE ENGINEER IF THERE ARE ANY DISCREPANCIES PRIOR TO CONSTRUCTION.

APPROVAL	S
T-MOBILE PROJECT MANAGER	DATE:
T-MOBILE RF ENGINEER	DATE:
LANDLORD	DATE:





REV.	DATE	DESCRIPTION OF CHANGES			
۰	11-05-2021	ISSUED FOR CONSTRUCTION			
1	11-17-2021	ZONING COMMENTS			
2					
3					
4					
5					
	SCHEDULE OF REVISIONS				

DATE	DESCRIPTION OF CHANGES
DRAWN BY:	EDZ
CHECKED BY	f: MRL
SCALE:	NOTED
JOB NO:	19E0047.001
DRAWING TI	TLE:

TITLE SHEET


T-1

FRALEY FAMILY - ROCKVILLE 7WAN162B 17800 BOWIE MILL ROAD DERWOOD, MARYLAND 28055

SHEET NO. 1 OF 13

44 22 20 2

ANDREW M. MILLER, P.E.
"PROFESSIONAL ERTIFICATION. I HEREBY
CRETEF Y THAT THESE DOCUMENTS WERE
PREPARED OR APPROVED BY ME, AND THAT
AM A DUTY LICENSED PROFESSIONAL
ENGINEER UNDER THE LAWS OF THE STATE C
MARYLAND, LICENSE NO. 44497, EXPIRATION

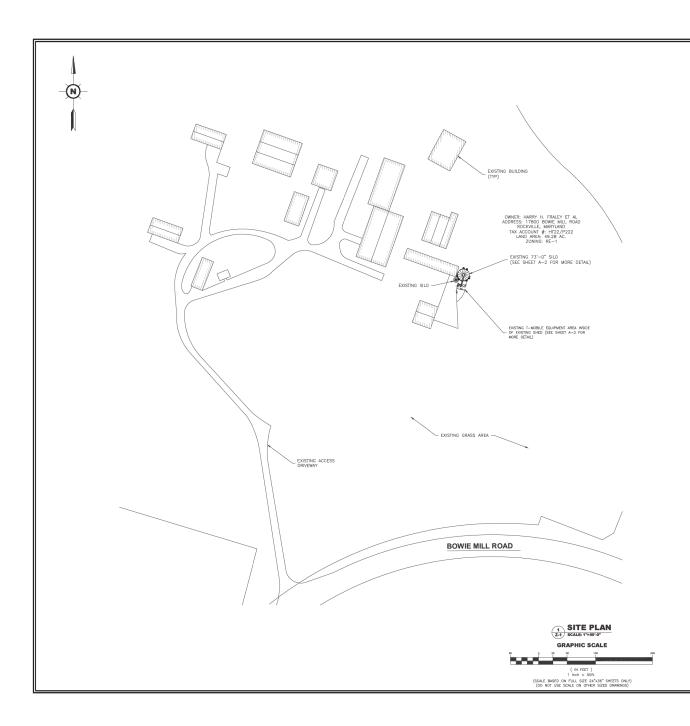

SITE INFORMATION

SITE NUMBER: 7WAN162B
SITE NAME: FRALEY FAMILY - ROCKVILLE
SITE ADDRESS: 17800 BOWE MILL ROAD
DERWOOD, MARYLAND 20055

ZONING DISTRICT: RE-1
TAX MAP: HT22/P222

JURISDICTION: MONTGOMERY COUNTY, MARYLAND

SITE COORDINATES: N 39° 09' 0.49" (NAD 83) W 77" 06' 51.55" (NAD 83)

 GROUND ELEVATION:
 498'± (NAVD 88)

 STRUCTURE TYPE:
 SILO

ANTENNA RAD CENTER: 78-0°± AGL
TENANT: T-MOBILE NORTHEAST LLC
12050 BALTMORE AVENUE
BELTSVILLE MARYLAND 20705

73'± AGL (TOP OF EXISTING SILO)

OWNER'S NAME: HARRY FRALEY ET AL.
OWNER'S ADDRESS: 17800 BOWE MILL ROAD ROCKVILLE, MARYLAND 20855-1609

GENERAL NOTES:

STRUCTURE HEIGHT:

- PROPERTY LINE INFORMATION WAS PREPARED USING AVAILABLE SITE PLANS, DEEDS, TAX MAPS, AND PLANS OF RECORD, INFORMATION SHOWN SHOULD NOT BE CONSTRUED AS AN ACCURATE BOUNDARY SURVEY.
- THIS PLAN WAS PREPARED WITHOUT THE BENEFIT OF A TITLE REPORT AND IS SUBJECT TO ALL EASEMENTS AND RESTRICTIONS OF RECORD.
- THE PROPOSED FACILITY WILL CAUSE NO INCREASE IN STORMWATER RUNOFF, THEREFORE, NO DRAINAGE STRUCTURES ARE PROPOSED.
- 4 THE FACILITY IS UNMANNED AND NOT FOR HUMAN HABITATION. (THERE IS NO HANDICAP ACCESS REQUIRED).

 5. THE FACILITY IS UNMANNED AND DOES NOT REQUIRE POTABLE WATER OR SANTARY SERVICE.
- 6. ELEVATIONS REFER TO THE NORTH AMERICAN VERTICAL DATUM OF 1988 (NAVD-88).
- 88).
- THE PROPOSED DEVELOPMENT DOES NOT INCLUDE STREET SIGNS OF ANY TYPE, NO SIGNS WILL BE POSTED EXCEPT THOSE REQUIRED.

8. THE PROPOSED DEVELOPMENT DOES NOT INCLUDE OUTDOOR STORAGE OR ANY SOLID WASTE RECEPTACLES.





	SCHEDULE OF REVISIONS				
5					
4					
3					
2					
1	11-17-2021	ZONING COMMENTS			
0	11-05-2021	ISSUED FOR CONSTRUCTION			

NO.	DESCRIPTION OF CHANGES
DRAWN BY:	EDZ
CHECKED BY	f: MRL
SCALE:	NOTED
JOB NO:	19E0047.001

DRAWING TITLE:

SITE PLAN

DRAWING SHEET:


Z-1


FRALEY FAMILY - ROCKVILLE 7WAN162B 17800 BOWIE MILL ROAD DERWOOD, MARYLAND 28055

SHEET NO. 2 OF 13



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CERTIFY THAT THESE DOCUMENTS WER
PREPARED OR APPROVED BY ME, AND TH.
AM A DULY LICENSED PROFESSIONAL
ENGINEER UNDER THE LAWS OF THE STAT
MARYLAND, LICENSE NO. 44 467, EXPIRAT

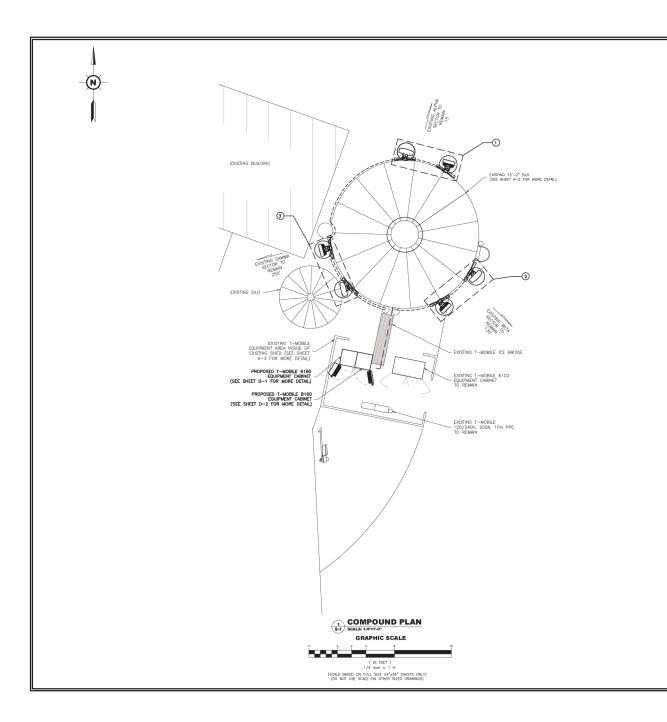

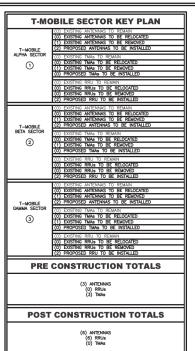

GENERAL NOTES

- THE CONTRACTOR SHALL COMPLY WITH ALL APPLICABLE CODES, ORDINANCES, LAWS AND REGULATIONS OF ALL MUNICIPALITIES, UTILITIES COMPANY OR OTHER PUBLIC AUTHORITIES.
- THE CONTRACTOR SHALL BE RESPONSIBLE FOR OBTAINING ALL PERMITS AND INSPECTIONS THAT MAY BE REQUIRED BY ANY FEDERAL, STATE, COUNTY OR MUNICIPAL AUTHORITIES.
- 3. THE CONTRACTOR SHALL NOTIFY THE CONSTRUCTION MANAGER, IN WRITING, OF ANY CONFLICTS, ERRORS OR OMISSIONS PRIOR TO THE SUBMISSION OF BIDS OR PERFORMANCE OF WORK, MINOR OMISSIONS OF ERRORS IN THE BID DOCUMENTS SHALL NOT RELEVE THE CONTRACTOR FROM RESPONSIBILITY FOR THE OVERALL INTENT OF THESE DRAWINGS.
- 4. THE CONTRACTOR SHALL BE RESPONSIBLE FOR PROTECTING ALL EXISTING SITE IMPROVEMENTS PRIOR TO COMMENCING CONSTRUCTION. THE CONTRACTOR SHALL REPAIR ANY DAMAGE CAUSED AS A RESULT OF CONSTRUCTION OF THIS FACILITY.
- THE SCOPE OF WORK FOR THIS PROJECT SHALL INCLUDE PROVIDING ALL MATERIALS, EQUIPMENT AND LABOR REQUIRED TO COMPLETE THIS PROJECT, ALL EQUIPMENT SHALL BE INSTALLED IN ACCORDANCE WITH THE MANUFACTURER'S RECOMMENDATIONS.
- THE CONTRACTOR SHALL VISIT THE PROJECT SITE PRIOR TO SUBMITTING A BID TO VERIFY THAT THE PROJECT CAN BE CONSTRUCTED IN ACCORDANCE WITH THE CONTRACT DOCUMENTS.
- THE FACILITY IS UNMANNED AND NOT FOR HUMAN HABITATION. (THERE IS NO HANDICAP ACCESS REQUIRED).
- 8. THE FACILITY IS UNMANNED AND DOES NOT REQUIRE POTABLE WATER OR SANITARY SERVICE.
- THE PROPOSED DEVELOPMENT DOES NOT INCLUDE OUTDOOR STORAGE OR ANY SOLID WASTE RECEPTACLES.
- THE PROPOSED DEVELOPMENT DOES NOT INCLUDE STREET SIGNS OF ANY TYPE, NO SIGNS WILL BE POSTED EXCEPT THOSE REQUIRED.
- 11. NO SIGNIFICANT NOISE, SMOKE, DUST OR ODOR WILL RESULT FROM THIS FACILITY.
- 12. ELEVATIONS REFER TO THE NORTH AMERICAN VERTICAL DATUM OF 1988 (NAVD 88).
- CONSTRUCTION TO COMMENCE UPON COMPLETION OF A PASSING STRUCTURAL ANALYSIS. STRUCTURAL ANALYSIS TO BE PERFORMED BY ADVANTAGE ENGINEERS.

T - Mobile
NORTHEAST LLC
T-MOBILE NORTHEAST LLC 12050 BALTIMORE AVENUE BELTSVILLE, MARYLAND 20705 PHONE: (240) 264-8600 FAX: (240) 264-8610



151 COLUMBIA GATEWAY DRIVE SUITE COLUMBIA, MARYLAND 21046 PHONE: (443) 367-0003 FAX: (443) 367-3548

REV. NO.	DATE	DESCRIPTION OF CHANGES
0	11-05-2021	ISSUED FOR CONSTRUCTION
1	11-17-2021	ZONING COMMENTS
2		
3		
4		
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NO.		
DRAWN BY:	EDZ	
CHECKED BY:	MRL	
SCALE:	NOTED	
JOB NO:	19E0047.001	
DRAWING TITLE:		

COMPOUND PLAN

DRAWING SHEET:

S-1


FRALEY FAMILY - ROCKVILLE 7WAN162B 17800 BOWIE MILL ROAD DERWOOD, MARYLAND 28055


SHEET NO. 3 OF 13



ANDREW M. MILLER, P.E.

**PROFESSIONAL CERTIFICATION. I HEREB'
CERTIFY THAT THESE DOCUMENTS WERE
PREPARED OR APPROVED BY ME, AND THA'
AM A DULY LICENSED PROFESSIONAL.
ENGINEER UNDER THE LAWS OF THE STATE
MARYLAND, LICENSE NO. 4447, EXPIRATIVE

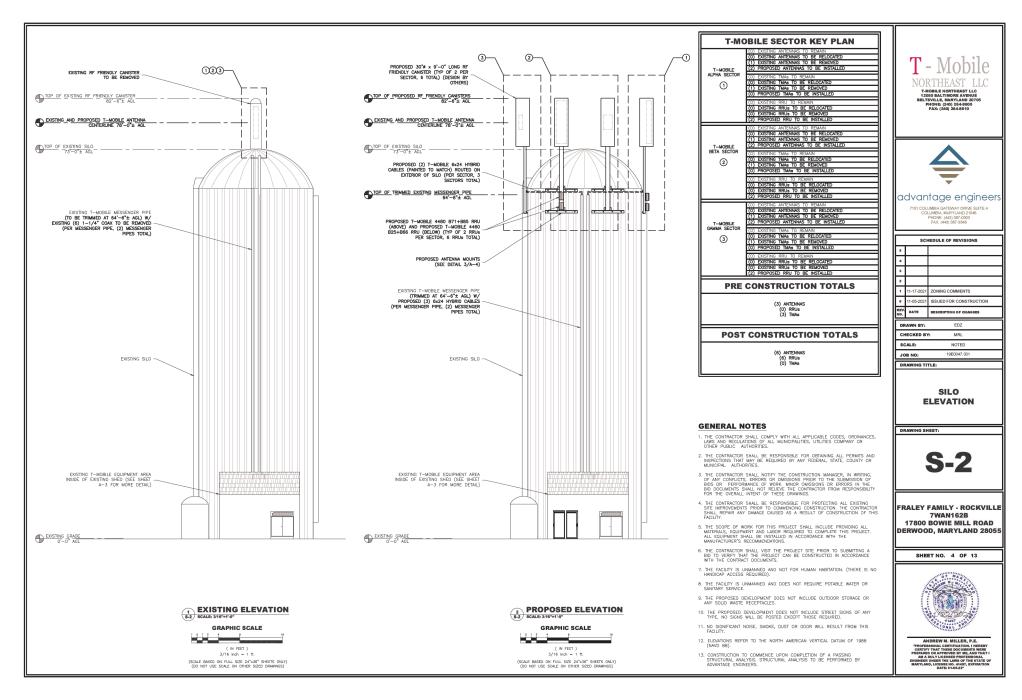

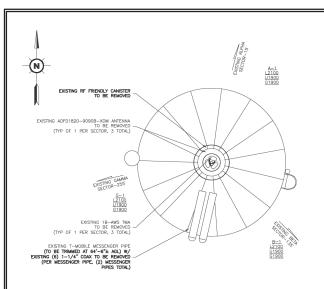

EXISTING ANTENNA PLAN

STRUCTURAL NOTES

POSITION RAD EXISTING AZIMUTH

A-1 78'-0" 1"

B-1 78'-0" 1: L2100,U1900,

B-1 78'-0" 1' C1900 G1900 G-1 78'-0" 1' L2100,U1900, G1900

EXISTING TECH

L2100,U1900,

- DESIGN REQUIREMENTS PER INTERNATIONAL BUILDING CODE 2015 AND THE ANSI/TIA-222-G STRUCTURAL STANDARDS FOR STEEL ANTENNA TOWERS AND ANTENNA
- SUPPORTING STRUCTURES.

 INFORMATION S-ONN ON THESE DEMANDS WAS GETAINED BY FELD MESSUREMENT AND FROM THE EXISTING STRUCTURAL DRAWINGS. THE CONTRACTOR SHALL VERY ALL EXISTING CONDITIONS AND MOTIFY THE ARCHITECT/EXIGNEER OF ANY DISCREPANCES PRIOR TO ORDERING MATERIALS OR PROCEEDING WITH STRUCTURAL SETS. SHALL CONFORM TO THE LATEST EDITION OF THE ASS. SPECIFICATIONS FOR STRUCTURAL STEEL BUILDINGS ALLOWABLE STRESS DESIGN AND PLASTIC CESSION INCLUDING THE COMMETINATY AND THE ASS. COSE FOR STRUCTURAL SETS. POR STRUCTURAL STEEL BUILDINGS ALLOWABLE STRESS DESIGN AND PLASTIC CESSION INCLUDING THE COMMETINATY AND THE ASS. COSE FOR STRUCTURAL SETEL PIPES SHALL CONFORM TO ASSEMBLES SHALL BE INTO BY CALL STRUCTURAL SETEL PIPES SHALL CONFORM TO ASSEMBLES SHALL BE INTO BY CALLWANZED AFTER PARRICATION.

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 SEEL COMPONENTS AND STRUCTURAL WELDING SOCIAL BE INTO BY CALLWANZED AFTER PARRICATION.
- 5. WELDING SHALL BE IN ACCORDANCE WITH THE LATEST EDITION OF AMERICAN WELDING SUCIETY (MAN) STRUCTURAL WELLING SCALE 3 LILLER MEDICAL MALE SERVICES AND SERVICES AND IS NOT INCLUDED IN THESE CONSTRUCTION.

 A. OLD WELL STEEL FRANCE SHALL IS INFRISHED ALL CONNECTION HARDWARE REQUIRED TO SEQUIRE THE CORRESC CONNECTION HARDWARE SHALL BE STANLESS STEEL.

 A. ALL THREADED STRUCTURAL ASTRUCTURAL ASSEMBLES SHALL BE 5/8" MIN. DAMPETER BEARING TYPE CONNECTIONS MIN HARD SINCLUDED IN THE SHEAR PLANE. ALL EXPOSED ASSEMBLES ASHALL BE 5/8" MIN. DAMPETER BEARING TYPE CONNECTIONS SHALL BE HILL WAS BOLIS UNLESS OTHERWISE NOTED.

 BEFORE STANDARD CONSTRUCTION REFERS TO TIME NORTH. CONTRACTOR SHALL BE CONSTRUCTION AND INFORM CONSTRUCTION MANAGER OF ANY DISCREPANCY MEETING CONSTRUCTION REFERS TO TIME NORTH. CONTRACTOR SHALL BE ASSEMBLED.

 SECOND STRUCTION TO COMMENCE UPON COMPLETION OF A PASSING STRUCTURAL ANALYSIS. STRUCTURAL ANALYSIS TO BE PERFORMED BY ADVANTAGE ENGINEERS.

ADFD1820-9090B-XDM 1B-AWS

ANDREW ADFD1820-9090B-XDM 1B-AWS N/A 0° 5/5

ANDREW ADFD1820-9090B-XDM 1B-AWS N/A 0° 5/5

EXISTING EXISTING EXISTING EXISTING RRU/TMA MDT EDT

N/A 0' 3/3

EXISTING ANTENNA SCHEDULE

ANTENNA MANUFACTURER

ANDREW

PROPOSED ANTENNA SCHEDULE

	POSITION	ANTENNA RAD CENTER	PROPOSED AZIMUTH	PROPOSED TECH	ANTENNA MANUFACTURER	PROPOSED ANTENNA MODEL #	PROPOSED RRU/TMA	PROPOSED RRU/TMA	PROPOSED MDT	PROPOSED EDT
П	A-2	78'-0"	15'	N600,L600,L700,L600, L19,G19,U19,L21	RFS	APXVALL24_43-U-NA20	4480 B71+B85	4460 B25+B66	0.	3/3/3/3
П	A-3	78'-0"	15'	L2500,N2500	ERICSON	AIR6449 B41	N/A	N/A	0,	2/2
П	B-2	78'-0"	135	N600,L600,L700,L600, L19,G19,U19,L21	RFS	APXVALL24_43-U-NA20	4480 B71+B85	4460 B25+B66	0.	5/5/5/5
1	B-3	78'-0"	135*	L2500,N2500	ERICSON	AR6449 B41	N/A	N/A	0'	2/2
	G-2	78'-0"	255*	N600,L600,L700,L600, L19,G19,U19,L21	RFS	APXVALL24_43-U-NA20	4480 B71+B85	4460 B25+B66	0.	5/5/5/5
		met er	0551	LOGOO NOGOO	CDIOCONI	MBS446 B44	11.71	11.71	01	0.70

PROPOSED ANTENNA MOUNTS (SEE DETAIL 3/A-4) PROPOSED 30"# X 9'-0" LONG RF FRIENDLY CANISTER (TYP OF 2 PER SECTOR, 6 TOTAL) (DESIGN BY OTHERS) PROPOSED (2) T-MOBILE 6x24 HYBRID CABLES (PAINTED TO MATCH) ROUTED ON EXTERIOR OF SILO (PER SECTOR, 3 SECTORS TOTAL) PROPOSED T-MOBILE 4480 B71+B85 RRU AND PROPOSED T-MOBILE 4460 B25+B66 RRU (BELOW RF FRIENDLY CANISTER) (TYP OF 2 RRUs PER SECTOR, 6 RRUs TOTAL) EXISTING T-MOBILE MESSENGER PIPE (TRIMMED AT 64'-6"± AGL) W/-PROPOSED (3) 6x24 HYBRID CABLES (PER MESSENGER PIPE, (2) MESSENGER PIPES TOTAL)

PROPOSED ANTENNA PLAN
SCALE: NTS

GENERAL CONTRACTOR NOTES

- THE ARTINIA MOUNTS AND CONNECTIONS THAT REC USED TO SUPPORT THE PROPOSED INSTITULATION ACT ON ENERPETED PROPO TO THE INSTITULATION OF THE PROPOSED EQUIPMENT, IF THE CONDITIONS OF THE MOUNTS AND CONNECTIONS ARE FOUND TO BE UNICCEPTUALE. THE ENGINEER SHALL BE NOTHED IMMEDIATELY AND THE UNICCEPTUALE ELEMENTS OF THE MOUNT OR ANTINIA MAD CONTROL OF THE MOUNT OR ANTINIA MAD CONTROL OF THE MOUNT ON THE MOUNT ON
- IMMEDIATELY.
 CONTRACTOR IS TO VERIFY ALL ANTENNA AZIMUTHS WITH THE T-MOBILE CONSTRUCTION MANAGER PRIOR TO CONSTRUCTION.

ANTENNA/RRU/TMA SPECS

CONFIGURATION	ERICSSON	4460 B25+B66	3	19.6*	15.7*	12.1*	109 LBS
PROPOSED RRU CONFIGURATION	ERICSSON	4480 B71+B85	3	21.8"	15.7"	7.5*	84 LBS
FINAL	MANUFACTURER	RRU MODEL #	QUANTITY	HEIGHT	WIDTH	DEPTH	WEIGHT
TMAs	GENERIC	TWIN STYLE 1B-AWS TO BE REMOVED	3	10.04"	9.29"	4.84"	22.5 LB
EXISTING	MANUFACTURER	TMA MODEL #	QUANTITY	HEIGHT	WIDTH	DEPTH	WEIGHT
CONFIGURATION	ERICSON	AIR6449 B41	3	33.1"	20.5"	8.3*	103 LBS
PROPOSED ANTENNA	RFS	APXVAALL24_43-U-NA20	3	95.9"	24"	8.5*	122.8 LB
FINAL	MANUFACTURER	ANTENNA MODEL #	QUANTITY	HEIGHT	WIDTH	DEPTH	WEIGHT
ANTENNAS	ANDREW	ADFD1820-9090B-XDM TO BE REMOVED	3	51.7*	12.1*	4.5*	22.05 LB
EXISTING	MANUFACTURER	ANTENNA MODEL #	QUANTITY	HEIGHT	WIDTH	DEPTH	WEIGHT





Щ	SCI	HEDULE OF REVISIONS							
5									
4									
3									
2									
1	11-17-2021	ZONING COMMENTS							
0	11-05-2021	ISSUED FOR CONSTRUCTION							
REV NO.	DATE	DESCRIPTION OF CHANGES							
DI	DRAWN BY: EDZ								
CI	HECKED BY	f: MRL							

SCALE: JOB NO: 19E0047.001 DRAWING TITLE:

> **ANTENNA PLAN** & NOTES


DRAWING SHEET:




FRALEY FAMILY - ROCKVILLE 7WAN162B 17800 BOWIE MILL ROAD **DERWOOD, MARYLAND 28055**

SHEET NO. 5 OF 13



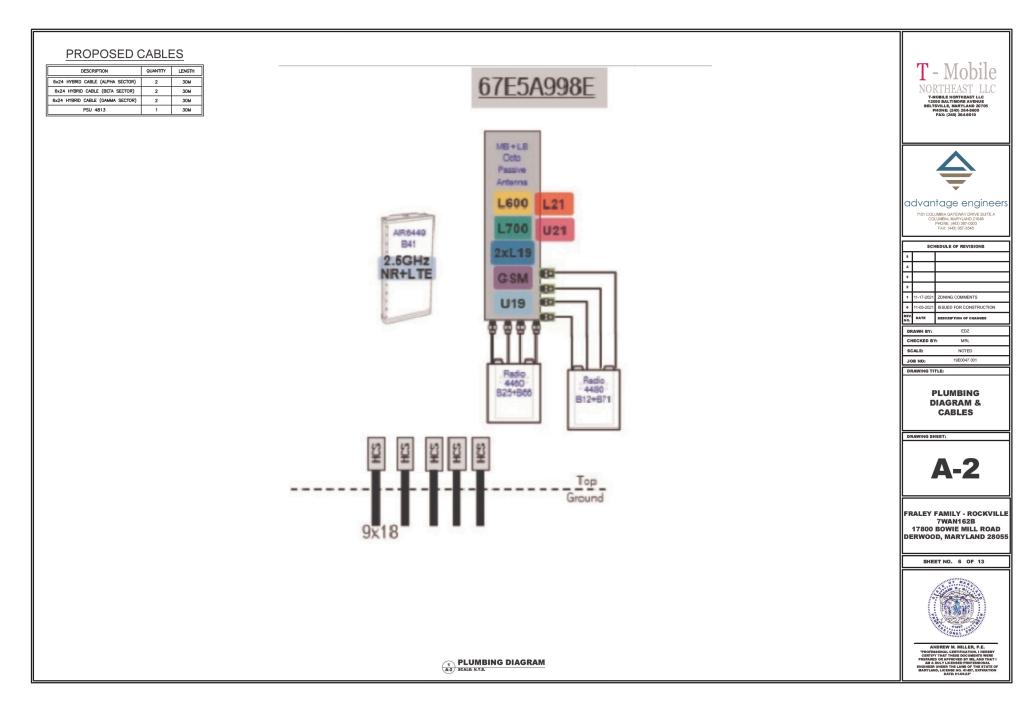

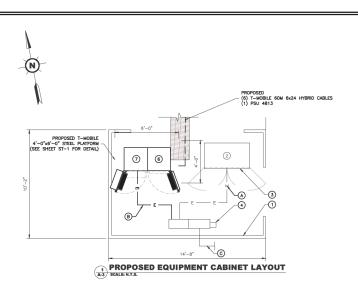

T-MOBILE CABINET PLAN KEY										
IDENTIFIER	IDENTIFIER CABINET AND STATUS DI									
1	EXISTING 14"-0"x10'-2" EQUIPMENT AREA TO REMAIN	N/A								
2	EXISTING 6102 EQUIPMENT CABINET TO REMAIN	N/A								
(3)	EXISTING (1) DUW30, (6) RUS01 B2 AND (6) RUS01 B4 TO BE REMOVED	N/A								
4	EXISTING 120/240V, 200A, 1PH PPC TO REMAIN	N/A								
(5)	EXISTING RBS 2106 EQUIPMENT CABINET TO BE REMOVED	N/A								
6	PROPOSED B160 BATTERY CABINET TO BE INSTALLED	D-2								
7	PROPOSED 6160 EQUIPMENT CABINET TO BE INSTALLED	D-1								

CABINET INSTALLATION NOTES

- SEE SHEET D-1 FOR 6160 EQUIPMENT CABINET SPECIFICATIONS AND ERICSSON SUGGESTED INSTALLATION INSTRUCTIONS.
- SEE SHEET D-2 FOR B160 BATTERY CABINET SPECIFICATIONS AND ERICSSON SUGGESTED INSTALLATION INSTRUCTIONS.





REV.	DATE	DESCRIPTION OF CHANGES
0	11-05-2021	ISSUED FOR CONSTRUCTION
1	11-17-2021	ZONING COMMENTS
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3		
4		
5		
	SCI	HEDULE OF REVISIONS

DESCRIPTION OF CHANGES
EDZ
f: MRL
NOTED
19E0047.001

PROPOSED &
EXISTING
EQUIPMENT
CABINET LAYOUT

DRAWING SHEET:



FRALEY FAMILY - ROCKVILLE 7WAN162B 17800 BOWIE MILL ROAD DERWOOD, MARYLAND 28055

SHEET NO. 7 OF 13




*PROFESSIONAL CERTIFICATION. I HEREB CERTIFY THAT THESE DOCUMENTS WERN PREPARED OR APPROVED BY ME, AND THA' AM A DULY LICENSED PROFESSIONAL MINISTER OF THE STATE MARYLAND, LICENSE NO. 41487, EXPIRATE DATE: 91-95-22"

	ELECTRICAL AT T-MOBI	LE CABINETS KEY	
IDENTIFIER	ITEM AND STATUS	ROUTING/LOCATION	DETAIL
A	EXISTING (3) #1/0 & (1) #6 GND IN EXISTING CONDUIT TO BE REMOVED (SEE NOTE)	FROM EXISTING T-MOBILE 200A PPC TO EXISTING 6102 EQUIPMENT CABINET	N/A
B	PROPOSED (3) #2 & (1) #8 GND IN PROPOSED 1-1/2" CONDUIT	FROM EXISTING T-MOBILE 200A PPC TO PROPOSED 6160 EQUIPMENT CABINET	N/A
0	EXISTING CONDUIT & CONDUCTORS TO REMAIN	FROM EXISTING 200A ENCLOSED BREAKER TO EXISTING PPC	N/A


NOTE


RE-USE EXISTING CONDUIT AND (3) #1/0 & (1) #6 GND CONDUCTORS FOR RELOCATED 6102 EQUIPMENT CABINET AS POSSIBLE. REPLACE AS SHOWN IF EXISTING CONDUIT AND CONDUCTORS CANNOT BE RECONNECTED TO RELOCATED 6102 EQUIPMENT CABINET.

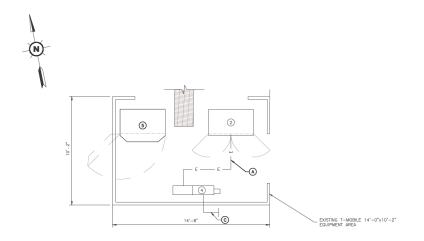



EXISTING EQUIPMENT CABINET LAYOUT


A3 SCALE N.Y.S.

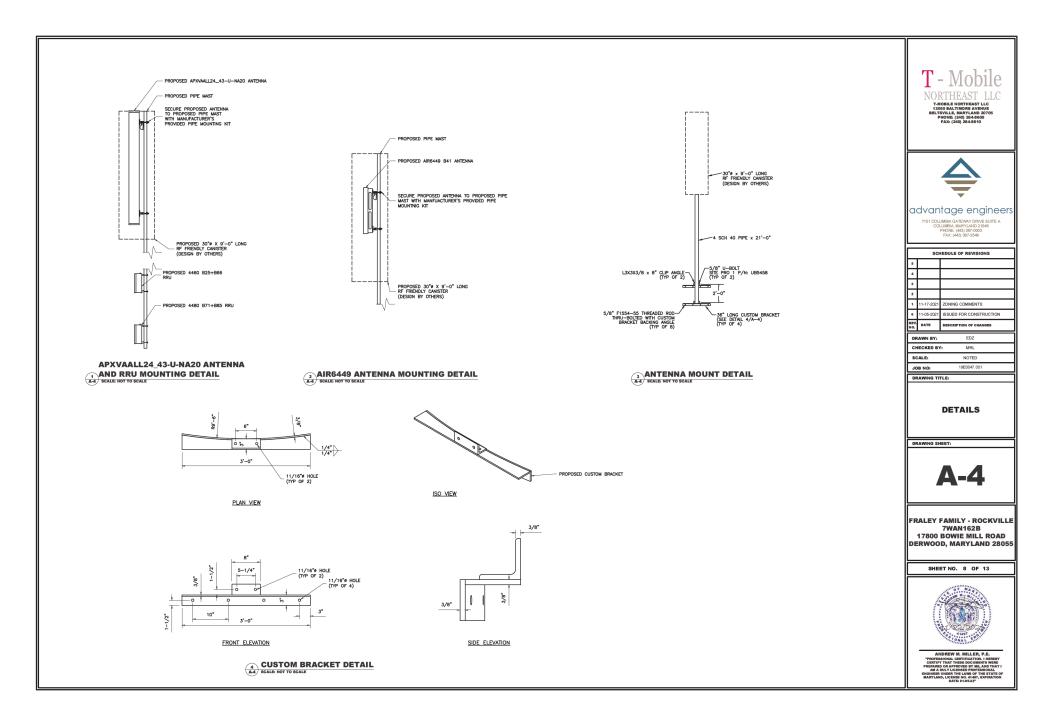

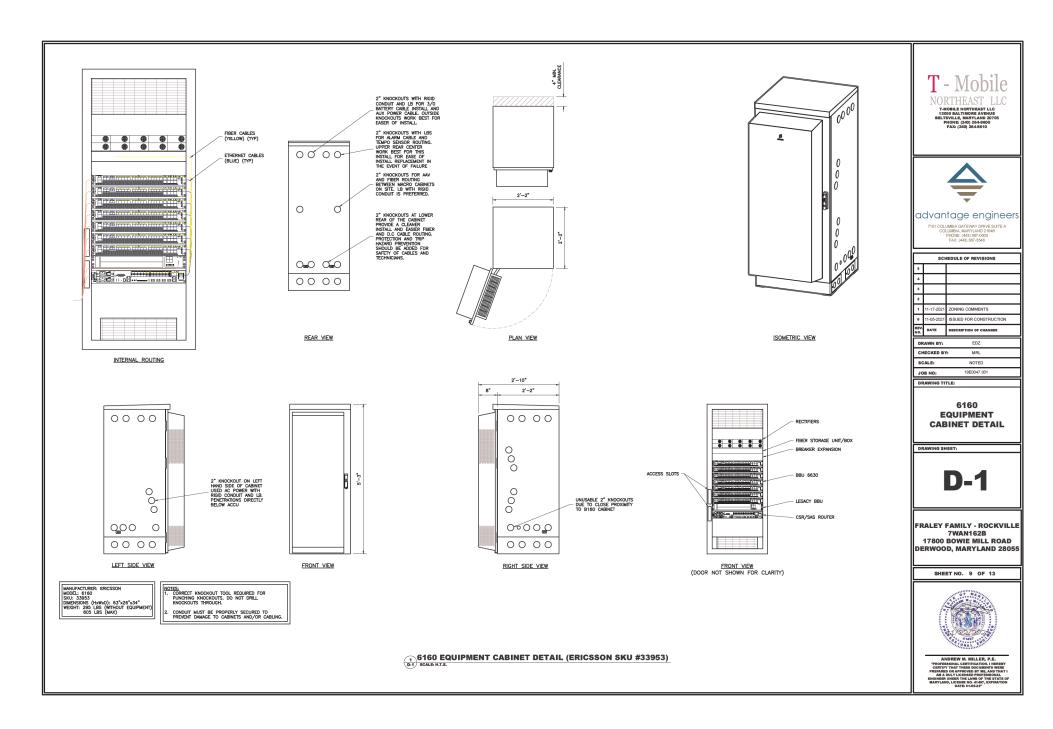

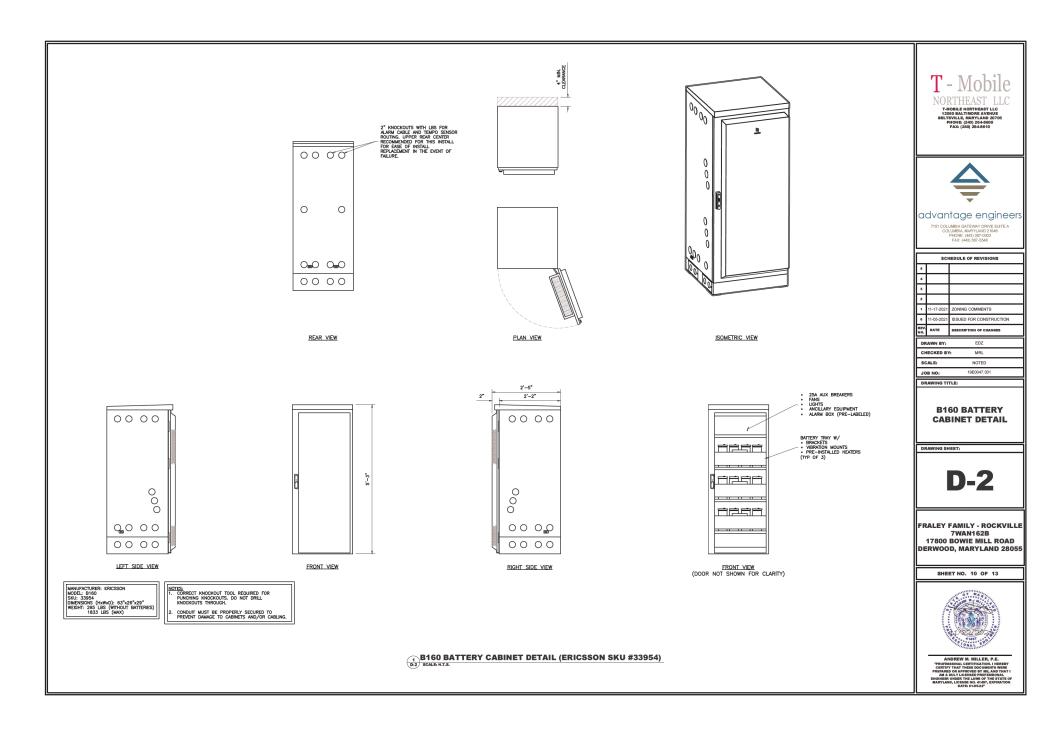

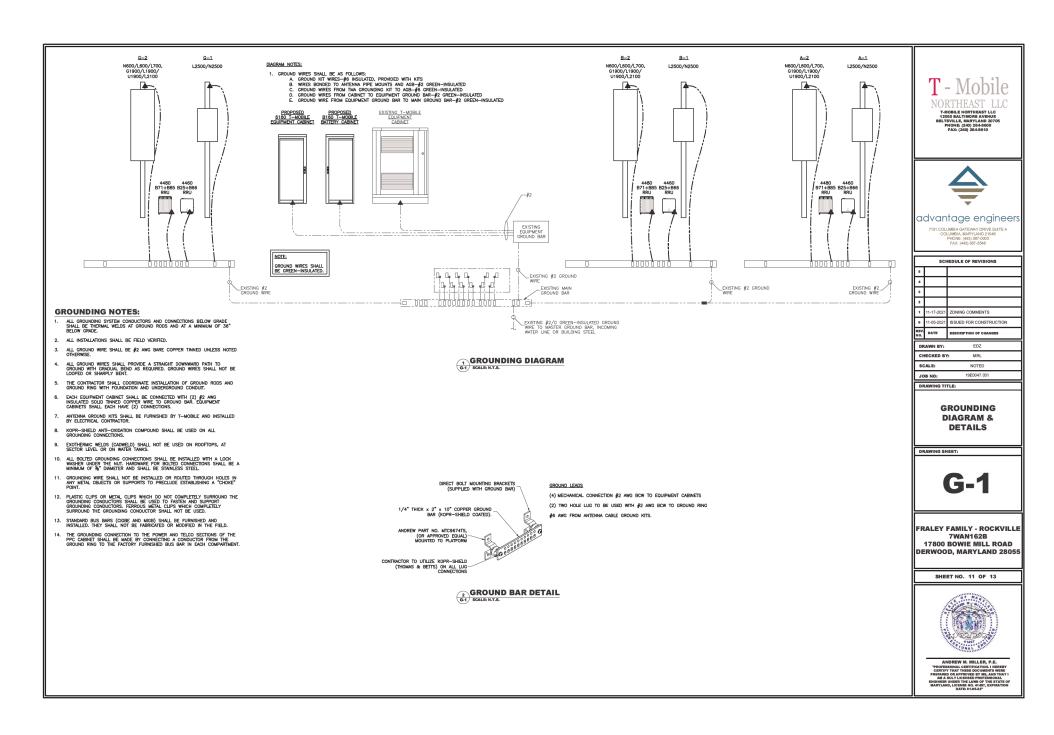

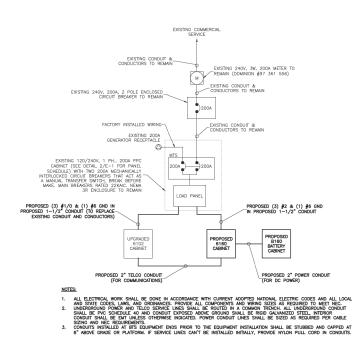

ELECTRICAL SYMBOLS

TRANSFORMER Ø PHASE M) -r--r- TELCO WIRE CIRCUIT BREAKER ď



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1	11-17-2021	ZONING COMMENTS
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REV. NO.	DATE	DESCRIPTION OF CHANGES
DF	RAWN BY:	EDZ

CHECKED BY: SCALE: JOB NO: 19E0047.001

DRAWING TITLE:

ELECTRICAL DETAILS

DRAWING SHEET:

E-1


FRALEY FAMILY - ROCKVILLE 7WAN162B 17800 BOWIE MILL ROAD DERWOOD, MARYLAND 28055

SHEET NO. 12 OF 13



ELECTRICAL ONE LINE DIAGRAM B1 SCALE N.T.S.

													120/240 VAC, 1PH, 200 AMP F	EEDER IS EXISTING													
			Pane	l Circuit a	and Load	Sched	ule														SIGNA	TION: T-M T-MOBI	OBILE P	PANEL			
	Load			Load per	rphase (VA)	99	non			0		9	#3/0-0-0-	0-#4	9		e			none	sno	Load per	phase (VA)			Load	
	Description	QTY.	Unit	Р	hase	outino	South		Poles	28 80	A.I.C	Wire Type	5 § ((5 6	re Type	A.I.C	225	Poles		Contin	듇	Pha	ase	Unit	QTY.	Ddeli	
	Description	QIT.	V.A.	Α	В	ö	Nen			VOID		N.	100A	60A	8		N.			Non-	8	Α	В	V.A.	QIT.	Description	
1 2	PROPOSED 6160 CABINET	1	8200 8200	8,200	8,200	X		100	2	2	10,000 T			150A RED	THWN-2 THWN-2	10,000		2	60			0	0			SURGE SUPPRESSOR	7
3	UGHT	1	150	150	0,200	- "	X	20	1		10,000 T	HWN-2	BUX	BLK	THWN-2	10,000						0					9
4	GFI	1	180		180		X				10.000 T	HWN-2	RED	RED	THWN-2	10.000	#1/0	_			Х		10,250	10250	1	UPGRADED 6102	10
5	SPACE			0							10.000 T	HWN-2	BLK 10A	BLK	THWN.2	10.000	#1/O	2	150		Х	10,250		10250	1	CABINET	11
6	FAN	1	200		200		X	10	1		10,000 TI	HWN-2	RED	RED	THWN-2	10,000							0				12
		Sub1 Contin		8,200	8,200								'									10,250	10,250	Sub		TOTAL CONTINUOUS x 125	10 100
		SubT Non-Con		150	380																	0	0	Sub Non-Cor		IOTAL CONTINUOUS X 125	46.125
Voltage:	120/240	Cycle: 6	0		Phase: 1				Wire: 3						Manufac	turer: St	QUARE	D								TOTAL NON-CONTINUOUS	0.53
	200 Amps														Model N												
	aker. 200 Amp Frame				A.I.C: 22,00	00			Trip: 20	0 Amps					APPRO											TOTAL KVA	46.66
Main Lug	s: 200 Amps	Main Bu	s:200 A	mps											Mounting	g: SURF	ACE									TOTAL AMPS	194.40

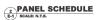

GENERAL ELECTRICAL NOTES & BASIC ELECTRICAL REQUIREMENTS

- ENERAL ELECTRICAL NOTES & BASIC ELECTRICAL REQUIREMENTS

 THE DRAWINGS ARE PROVIDED TO DEPICT DESIGN INTENT AND ARE NOT TO BE CONSIDERED MINISTRALING DAWNINGS. NOT ALL COMPONENTS OF CONNECTIONS ARE SHOWN. COURIEMENT AND RESIDNESS AND ALL CONTINUES AND ALL CONTINUES AND ALL CONTINUES AND ALL CONTINUES. THE CONTRACTOR SHALL BE RESPONSIBLE FOR DETERMINING PINAL CONDUIT STANDARDS. THE CONTRACTOR SHALL BE RESPONSIBLE FOR ALL RESIDANCIAN AND METHODS. THE CONTRACTOR SHALL BE RESPONSIBLE FOR ALL RESIDANCIAN COMPONENTS AND METHODS. THE CONTRACTOR SHALL BE RESPONSIBLE FOR ALL RESPONSIBLE FOR ALL RESIDANCIAN CONTRACTOR SHALL RESPONSIBLE FOR ALL RESPONSIBLE FOR ALL RESIDANCIAN CONTRACTOR SHALL RESPONSIBLE FOR ALL RESPONSIBLE FOR

- NATIONAL ELECTRICAL CODE AND OTHER PREVIATE ADDRESSITY ADDRESS DESCRIPTION OF THE NATIONAL ELECTRICAL CODE AND OTHER PREVIABLE CODES.

 9. THE CONTRACTOR SHALL BE RESPONSIBLE FOR GITANING ALL PERMITS AND INSPECTIONS MAD INSPECTIONS AND INSPECTIONS OF THE CONTRACTOR SHALL BE RESPONSIBLE FOR GITANING ALL PERMITS AND INSPECTIONS AND INSPECTION CONTRACTOR SHALL PROVIDE ALL LABOR, MATERIALS, INSURANCE, EQUIPMENT, MAD CONSTRUCTION DOCUMENTS, AS SECURED HERDIN AND/OR AS OTHERWISE REQUIRED.

 1. THE CONTRACTOR SHALL BE RESPONSIBLE FOR PROTECTION ALL EXISTING STREAM AND INSPECTION OF THE STACILITY.

 2. THE CONTRACTOR SHALL BE RESPONSIBLE FOR CLEANING OF THE WORK SITE AND RESPONSIBLE FOR ALL EXCHANGING, GRANING, TRECHES, BEOCHELLING, AND REMOVE OF EXCESSION ALL DECREMENT SHALL BE NEW AND IN EXPLANING AND SHALL BE AND APPROVED BY UNDERWRITER'S LABORATORIES (LL.) AND SHALL BEAR THE RESPECTION AND APPROVED BY UNDERWRITER'S LABORATORIES (LL.) AND SHALL BEAR THE RESPECTION AND APPROVED BY UNDERWRITER'S LABORATORIES (LL.) AND SHALL BEAR THE RESPECTION AND APPROVED BY UNDERWRITER'S LABORATORIES (LL.) AND SHALL BEAR THE RESPECTION AND APPROVED BY UNDERWRITER'S LABORATORIES (LL.) AND SHALL BEAR THE RESPECTION AND APPROVED BY UNDERWRITER'S LABORATORIES (LL.) AND SHALL BEAR THE RESPECTION AND APPROVED BY UND

- FINISHED AND READY FOR OPERATION.

 3. THE CONTRACTOR SHALL NOTIFY THE BUILDING OWNER FIVE (5) BUSINESS DAYS PRIOR TO ANY PLANNED POWER OR OTHER SERVICE OUTAGE. THE OWNER SHALL RESERVE THE RIGHT TO REFUSE SUCH OUTAGE, AND HAVE IT RESCHEDULED.

 42. ANY CODE VIOLATIONS DUE TO THE CONTRACTOR'S WORK SHALL BE CORRECTED AT THE

ELECTRICAL SPECIFICATIONS: ELECTRICAL MATERIALS AND EQUIPMENT

- RIGID CALVANIZED STEEL (RGS) CONDUTT SHALL BE USED FOR EXTEROR LOCATIONS ABOVE GROUND AND IN UNFINISHED INTERIOR LOCATIONS AND WHERE INDICATED ON THE DRAWNINGS. FOR UNDERGROUND RUMS. RIGID CONDUIT AND FITTINGS SHALL BE STEEL COATED WITH CONTROL OF THE CONTROL O

- MISTRUCTIONS.

 MISTRU

- MINIMUM SIZE CONDUIT SHALL BE WINCH.

 MINIMUM SIZE CONDUIT SHALL BE WINCH.

 PROVIDE PULL BOXES AND JUNCTION BOXES WHERE SHOWN OR REQUIRED BY THE MEC.

 PROVIDE VERTIONLE CAMES UPPORTED IN ALL VERTICAL CONDUITS WHERE SHOWN OR

 PROVIDE EXPANSION FITTINGS IN CONDUIT WHERE SHOWN OR REQUIRED BY THE MEC.

 ALL CONDUITS SHALL BE MET WITH BENDS MADE IN ACCORDANCE WITH MEC. NO RIGHT

 ANGLE DEVICE OTHER THAN STANDARD CONDUIT CLEONS WITH 12 INCH MINIMUM MISIDE

 THERE SHALL NOT BE MORE THAN THE COUNTAGEN OF FOUR OLD WATER BENDS (306)

 DEGREES TOTAL) BETWEEN PULL BOXES, CONDUIT BOXES AND BOXES. CONTRACTOR SHALL

 PERSISH AND INSTALL ANY JALL JUNCTION BOXES SEED IN ACCORDANCE WITH THE MEC.

 REQUIREMENTS AS REQUIRED FOR THE MISTALL MON.
- BUSHINGS. CONTRACTOR SHALL BE RESPONSIBLE FOR PROTECTING ALL CONDUITS DURING 12.
- CONTRACTOR SHALL BE RESPONSIBLE FOR PROTECTING ALL COMOUNTS DURING CONSTRUCTION.

 TOUR OWNER OF THE COUNTY STATEM SHALL BE PLUEGED OR CAPPED TO THE PROPERTY OF THE PROPERTY O

- THE STATE OF THE STATES OF THE LEGISLATION OF THE STATES O
- THIS PURPOSE.

 ONDUTIS SHALL BE FASTENED SECURELY IN PLACE WITH APPROVED NON-PERFORATED CONDUTIS SHALL BE FASTENED SECURELY IN PLACE WITH APPROVED NON-PERFORATED STRUCKER AND INNOCESSARY PERSONAL TO THE PROVIDER AND INNOCESSARY PERSONAL TO THE STRUCKURE AND KEEP CONDUTIS IN TIGHT ENVILOPES. CONDUTI SHALL BE INSTALLED IN A HEAT AND WORMANIJEE MANKER, PARALLEL AND PERPONALIZED AT THE PROMOMENT OF THE PROPERTY OF THE PROPERTY OF THE PROPERTY OF THE PROPERTY OF THE PLACE OF TH
- LOCKNUT ON OUTSIDE AND INSIDE.

 20. SPARE CONDUITS SHALL BE FURNISHED WITH PULL LINES AND CAPPED WITH FACTORY CAPS.

CONDUCTORS

- 1. CONDUCTORS AND CABLE SHALL BE FLAME-RETARDANT, MOISTURE AND HEAT RESISTANT THERMOPLASTIC, SINGLE CONDUCTOR, COPPER, TYPE THHN/THWN-2, 600 VOLT, OR TYPE XHHW, 600V OR XHHW-2, 600V. SIZE AS INDICATED. #12 AWG SHALL BE THE MINIMUM SIZE

- CONDUCTOR.

 #10 AME AND SMALLER CONDUCTORS SHALL BE SOUD AND #8 AWG AND LARGER CONDUCTORS SHALL BE STRANDED.

 ONDUCTORS SHALL BE STRANDED.

 THE CONDUCTORS SHALL BE STRANDED.

 ALL CONDUCTORS SHALL BE TAGGED AT BOTH FROM STANDED.

 ALL CONDUCTORS SHALL BE TAGGED AT BOTH FROM SO SHALL BE CONDUCTOR, AT ALL PULL BOXES, JUNICORD BOXES, DUPLOTED BOXES, ENDEROM BOXES, BOUNDED.
- BOXES, JUNCTION BOXES, EQUIPMENT AND UNBITED HIS STREET OF THE APPROVED PLASTIC TAGS.

 CONTRACTOR SHALL PROVIDE STRAIN-RELIEF AND CABLE SUPPORTS FOR ALL CABLE

 ASSEMBLES, COAN CABLES, AND AISO RET CABLES. CABLE STRAIN-RELIEF & CABLE

 SUPPORTS SHALL BE APPROVED FOR THE PURPOSE. ZIP TIES OR VELCO STRAPS ARE NOT

ELECTRICAL SPECIFICATIONS: ELECTRICAL MATERIALS AND EQUIPMENT, CONTINUED

DISCONNECT SWITCHES

- DIANCE DIABOSE

 SHITD FOR USE AT 120/240V, SINGE PHASE, THREE WIRE PLUS GROUND, OR 120/200V, SINGLE PHASE, THREE WIRE PLUS GROUND OR 120/200V, THREE PHASE, FUUL WIRE PLUS GROUND OR SECOND OR THE DIABOSE PHASE, FUUL WIRE PLUS GROUND OR SECOND OR THE DIABOSE PHASE OR THE SECOND OF THE DIABOSE PHASE OR THE SECOND OR THE DIABOSE, AND HAVE A SHORT CHICAT WITH STAND BATTON OF 22,000 AC MINIMUM. AND HAVE A SHORT CHICAT WITH STAND BATTON OF 22,000 AC MINIMUM. THE WAN BREAKET SHALL BE OF ADMINISTED OR THE SHALL HAVE A NUMBER OF GROUND THE WAS TH

- INSTALED.
 ALL PANEL DIRECTORIES SHALL BE DYPEWRITTEN, NOT HANDWRITTEN,
 PANEL DIRECTORIES SHALL BE UPDATED TO ACCURATELY REFLECT THE FINAL CIRCUITING
 ALL UNUSED CIRCUIT BREAKERS SHALL BE SWITCHED OFF AND LABELED "SPARE".

EXTERNALLY MOUNTED SURGE PROTECTION DEVICES

- RATED FOR THE INTENDED APPLICATION AND AS INDICATED ON THE DRAWINGS: 120/240V, SINGLE PHASE, OR 120/200V, SINGLE PHASE, OR 120/200V, THREE PHASE, OR 480/277V, SINGLE PHASE OR 480/277V, REPORT PHASE OR 480/277V, REPORT PHASE OR 480/27V, REPOR

- POWER PROTECTION CABBETC (PEC)

 MATED FOR USE AT 120/240Y, SINGLE PHASE, THREE WIRE PLUS GROUND OR 120/200Y, SINGLE MATED FOR USE AT 120/240Y, SINGLE PHASE, THREE WIRE PLUS GROUND OR 120/200Y, SINGLE PHASE, SINGLE PHASE, SINGLE PHASE AND ASSESSMENT OF THE DEPARTMENT OF A SHORT OF THE DEPARTMENT OF A SHORT OF THE PARTMENT OF T

- WEATHERPROOF ENCLOSURE WHICH INCLUDES A 1204, 20A GFCI RECEPTACLE AND A 1204, 20A 1000LE WHITE. DESCRIPTION OF THE PROPERTY OF THE PROPERTY OF THE PROPERTY OF THE PROPERTY OF THE DRAWNES OF THE DRAWNES OTHERWISE MOTED ON THE DRAWNES OTHERWISE MOTED ON THE DRAWNES OF APPROVED EDUAL.

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NORTHEAST LLC



advantage engineers

7151 COLUMBIA GATEWAY DRIVE SUITE A COLUMBIA, MARYLAND 21046

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1	11-17-2021	ZONING COMMENTS
0	11-05-2021	ISSUED FOR CONSTRUCTION
REV. No.	DATE	DESCRIPTION OF CHANGES

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DRAWN BY:		EDZ
CHECKED BY:		f: MRL
SCALE:		NOTED

DRAWING TITLE:

ELECTRICAL NOTES

DRAWING SHEET:

FRALEY FAMILY - ROCKVILLE 7WAN162B 17800 BOWLE MILL BOAD DERWOOD, MARYLAND 28055

SHEET NO. 13 OF 13



ANDREW M. MILLER, P.E. ENGINEER UNDER THE LAWS OF THE STATE OF MARYLAND, LICENSE NO. 41497, EXPIRATION DATE: 01-05-22"

