

**MONTGOMERY COUNTY HISTORIC PRESERVATION COMMISSION**  
**STAFF REPORT**

<b>Address:</b>	37 West Irving Street, Chevy Chase	<b>Meeting Date:</b>	1/27/2021
<b>Resource:</b>	Contributing Resource Chevy Chase Village Historic District	<b>Report Date:</b>	1/20/2021
		<b>Public Notice:</b>	1/13/2021
<b>Applicant:</b>	Roslyn Mazer and David Holzworth (Jonathan Kuhn, Agent)	<b>Tax Credit:</b>	N/A
<b>Review:</b>	HAWP	<b>Staff:</b>	Michael Kyne

**Permit Number:** 937249


**PROPOSAL:** Construction of a new addition

**STAFF RECOMMENDATION:**

Staff recommends that the HPC **approve** the HAWP application.

**ARCHITECTURAL DESCRIPTION:**

**SIGNIFICANCE:** Contributing Resource within the Chevy Chase Village Historic District  
**STYLE:** Colonial Revival  
**DATE:** 1916-1927

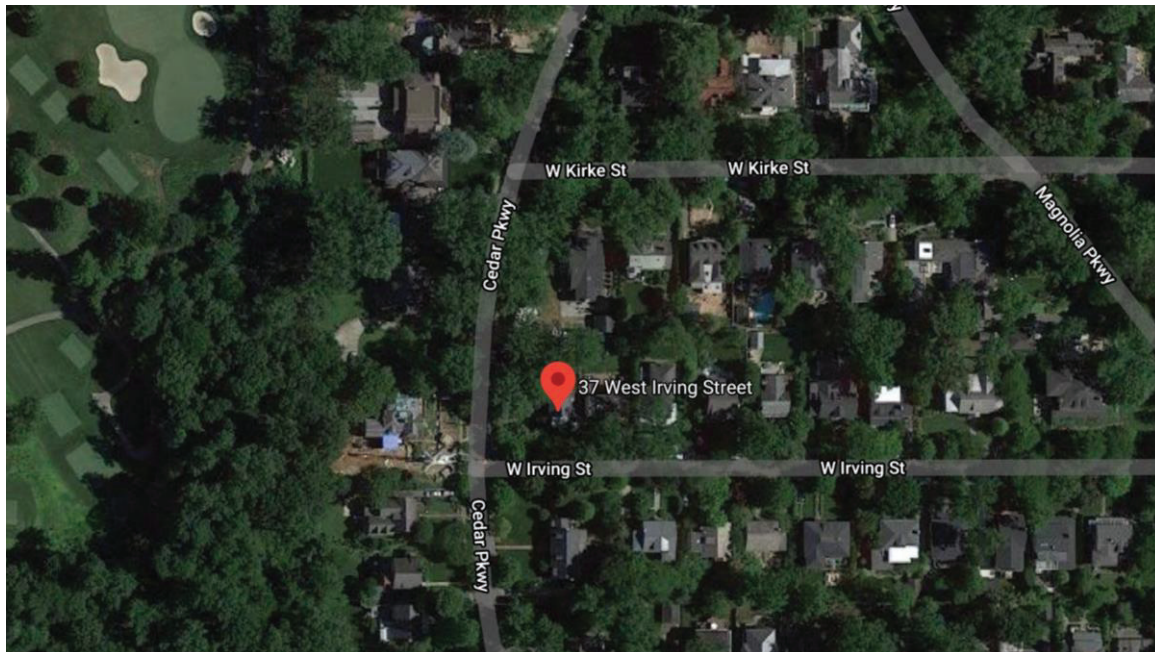

*Fig. 1: Subject property.*

**BACKGROUND:**

The applicants appeared before the Commission for a preliminary consultation at the July 29, 2020 HPC meeting.<sup>1</sup>

**PROPOSAL:**

The applicants propose a building addition at the subject property.

**APPLICABLE GUIDELINES:**

When reviewing alterations and new construction within the Chevy Chase Village Historic District several documents are to be utilized as guidelines to assist the Commission in developing their decision. These documents include *Montgomery County Code Chapter 24A (Chapter 24A)*, the historic preservation review guidelines in the approved and adopted amendment for the *Chevy Chase Village Historic District (Guidelines)*, and the *Secretary of the Interior's Standards for Rehabilitation (Standards)*. The pertinent information in these documents is outlined below.

***Montgomery County Code; Chapter 24A-8***

- (a) The commission shall instruct the director to deny a permit if it finds, based on the evidence and information presented to or before the commission that the alteration for which the permit is sought would be inappropriate, inconsistent with or detrimental to the preservation, enhancement or ultimate protection of the historic site or historic resource within an historic district, and to the purposes of this chapter.
- (b) The commission shall instruct the director to issue a permit, or issue a permit subject to such conditions as are found to be necessary to insure conformity with the purposes and requirements of this chapter, if it finds that:
  - (1) The proposal will not substantially alter the exterior features of an historic site or historic resource within an historic district; or
  - (2) The proposal is compatible in character and nature with the historical, archeological, architectural or cultural features of the historic site or the historic district in which an historic resource is located and would not be detrimental thereto or to the achievement of the purposes of this chapter; or
  - (3) The proposal would enhance or aid in the protection, preservation and public or private utilization of the historic site or historic resource located within an historic district in a manner compatible with the historical, archeological, architectural or cultural value of the historic site or historic district in which an historic resource is located; or
  - (4) The proposal is necessary in order that unsafe conditions or health hazards be remedied; or
  - (5) The proposal is necessary in order that the owner of the subject property not be deprived of reasonable use of the property or suffer undue hardship; or

<sup>1</sup> Link to July 29, 2020 preliminary consultation staff report: <https://montgomeryplanning.org/wp-content/uploads/2020/07/II.A-37-West-Irving-Street-Chevy-Chase.pdf>

Link to July 29, 2020 audio/video transcript: [http://mncppc.granicus.com/MediaPlayer.php?publish\\_id=fc70ce7d-d290-11ea-b5c3-0050569183fa](http://mncppc.granicus.com/MediaPlayer.php?publish_id=fc70ce7d-d290-11ea-b5c3-0050569183fa)

- (6) In balancing the interests of the public in preserving the historic site or historic resource located within an historic district, with the interests of the public from the use and benefit of the alternative proposal, the general public welfare is better served by granting the permit.
- (c) It is not the intent of this chapter to limit new construction, alteration or repairs to any 1 period or architectural style.
- (d) In the case of an application for work on an historic resource located within an historic district, the commission shall be lenient in its judgment of plans for structures of little historical or design significance or for plans involving new construction, unless such plans would seriously impair the historic or architectural value of surrounding historic resources or would impair the character of the historic district. (Ord. No. 9-4, § 1; Ord. No. 11-59.)

### ***Chevy Chase Village Historic District Guidelines***

The *Guidelines* state that the following five basic policies should be adhered to:

1. Preserving the integrity of the proposed Chevy Chase Village Historic District. Any alterations should, at a minimum, perpetuate the ability to perceive the sense of time and place portrayed by the district.
2. Preserving the integrity of the contributing structures in the district. Alterations to contributing structures should be designed in such a way that the altered structure still contributes to the district.
3. Maintaining the variety of architectural styles and the tradition of architectural excellence.
4. Design review emphasis should be restricted to changes that will be visible from the front or side public right-of-way, or that would be visible in the absence of vegetation or landscaping.
5. Alterations to the portion of a property that are not visible from the public right-of-way should be subject to very lenient review. Most changes to rear of the properties should be approved as a matter of course.

The *Guidelines* break down specific projects into three levels of review – Lenient, Moderate and Strict Scrutiny.

“Lenient Scrutiny” means that the emphasis of the review should be on issues of general massing and scale, and compatibility with the surrounding streetscape, and should allow for a very liberal interpretation of preservation rules. Most changes should be permitted unless there are major problems with massing, scale and compatibility.

“Moderate Scrutiny” involves a higher standard of review than “lenient scrutiny.” Besides issues of massing, scale and compatibility, preserving the integrity of the resource is taken into account. Alterations should be designed so that the altered structure still contributes to the district. Use of compatible new materials, rather than the original building materials, should be permitted. Planned changes should be compatible with the structure’s existing design, but should not be required to replicate its architectural style.

“Strict Scrutiny” means that the planned changes should be reviewed to insure that the integrity of the significant exterior architectural or landscaping features and details is not compromised. However, strict scrutiny should not be “strict in theory but fatal in fact” i.e. it does not mean that there can be no changes but simply that the proposed changes should be reviewed with extra care.

The *Guidelines* that pertain to this project are as follows:

***Major additions*** should, where feasible, be placed to the rear of the existing structure so that they are less visible from the public right-of-way. Major additions which substantially alter or obscure the front of the structure should be discouraged but not automatically prohibited. For example, where lot size does not permit placement to the rear, and the proposed addition is compatible with the street scape, it should be subject to moderate scrutiny for contributing resources, but strict scrutiny for outstanding resources.

### ***Secretary of the Interior’s Standards for Rehabilitation***

The Secretary of the Interior defines rehabilitation as “the act or process of making possible a compatible use for a property through repair, alterations, and additions while preserving those portions or features, which convey its historical, cultural, or architectural values.” The *Standards* are as follows:

1. A property shall be used for its historic purpose or be placed in a new use that requires minimal change to the defining characteristics of the building and its site and environment.
2. The historic character of a property shall be retained and preserved. The removal of historic materials or alteration of features and spaces that characterize a property shall be avoided.
3. Each property shall be recognized as a physical record of its time, place, and use. Changes that create a false sense of historical development, such as adding conjectural features or architectural elements from other buildings, shall not be undertaken.
4. Most properties change over time; those changes that have acquired historic significance in their own right shall be retained and preserved.
5. Distinctive features, finishes, and construction techniques or examples of craftsmanship that characterize a historic property shall be preserved.
6. Deteriorated historic features shall be repaired rather than replaced. Where the severity of deterioration requires replacement of a distinctive feature, the new feature shall match the old in design, color, texture, and other visual qualities and, where possible, materials. Replacement of missing features shall be substantiated by documentary, physical, or pictorial evidence.
7. Chemical or physical treatments, such as sandblasting, that cause damage to historic materials shall not be used. The surface cleaning of structures, if appropriate, shall be undertaken using the gentlest means possible.
8. Significant archaeological resources affected by a project shall be protected and preserved. If such resources must be disturbed, mitigation measures shall be undertaken.
9. New additions, exterior alterations, or related new construction shall not destroy historic materials that characterize the property. The new work shall be differentiated from the old and shall be compatible with the massing, size, scale, and architectural features to protect the historic integrity of the property and its environment.

10. New additions and adjacent or related new construction shall be undertaken in such a manner that if removed in the future, the essential form and integrity of the historic property and its environment would be unimpaired.

### **STAFF DISCUSSION:**

The subject property is located on a corner lot, with West Irving Street to the south and Cedar Parkway to the west. The house is addressed on West Irving Street, although its west elevation is experienced as the traditional front from Cedar Parkway. There is an existing non-historic addition at the north side of the house and an existing non-historic open-air deck at the west side of the addition. The addition and deck are highly visible from the public right-of-way of Cedar Parkway.

The applicants propose to construct a one-story sleeping porch addition at the west side of the existing non-historic addition within the footprint of the existing non-historic deck.

The *Guidelines* state that “major additions should, where feasible, be placed to the rear of the existing structure so that they are less visible from the public right-of-way. Major additions which substantially alter or obscure the front of the structure should be discouraged but not automatically prohibited. For example, where lot size does not permit placement to the rear, and the proposed addition is compatible with the street scape, it should be subject to moderate scrutiny for contributing resources, but strict scrutiny for outstanding resources.”

Staff finds that, because the west elevation is experienced as the front of the house from the public right-of-way, it is within the spirit of the *Guidelines* to review the proposed addition as a front/side addition; however, staff does not find that the proposed addition will substantially alter or obscure the perceived front of the house. Furthermore, staff finds that the lot size and building restriction lines to the north and east (see the applicants’ narrative) make it infeasible to construct the proposed addition elsewhere on the property. Accordingly, staff finds that the proposed addition should be reviewed with moderate scrutiny.

The *Guidelines* define moderate scrutiny as:

...a higher standard of review than “lenient scrutiny.” Besides issues of massing, scale and compatibility, preserving the integrity of the resource is taken into account. Alterations should be designed so that the altered structure still contributes to the district. Use of compatible new materials, rather than the original building materials, should be permitted. Planned changes should be compatible with the structure’s existing design, but should not be required to replicate its architectural style.

As noted on Page Two, the applicants appeared before the Commission for a preliminary consultation at the July 29, 2020 HPC meeting. Initially, the applicants proposed a non-traditional building form, with the northwest wall of the proposed addition following the angle of the existing deck. However, prior to the preliminary consultation, the applicants provided revised architectural drawings (dated 7/21/2020), removing the non-traditional angled wall from the proposal.

At the July 29, 2020 preliminary consultation, the Commission provided the following comments/guidance:

- The Commission supported the proposed building addition footprint and location, due to site restrictions.
- The Commission indicated support for the proposed revisions (architectural set dated 7/21/2020), finding that the removal of the angled northwest wall results in an addition that is compatible with the subject property and surrounding streetscape.



- The Commission requested additional information regarding the proposed materials.
- A minority (3 of 8) found the flat roof incompatible with the subject property and surrounding streetscape. One suggested alternative was a cross gable roof.

Staff finds that the applicants have responded to the Commission's comments and recommendations. The current proposal is generally consistent with the previously submitted architectural drawings dated 7/21/2020. The main difference is that, in the current submission, an awning has been added behind the proposed projection at the north side of the house. The proposed awning is intended to cover two new HVAC units.

The proposed materials include stucco siding to match the first floor of the historic house and existing north side addition, membrane roofing (with metal coping on the parapet), and aluminum-clad, SDL, fixed and casement windows.

Staff supports the applicants' proposal, finding it to be consistent with *Guidelines*, as outlined above. Additionally, staff finds that the proposal will not remove or alter character-defining features of the subject property or surrounding streetscape, in accordance with *Standards #2* and *#9*. In accordance with *Standard #10*, the proposed alterations can be removed in the future without impairing the essential form and integrity of the historic property and its environment.

After full and fair consideration of the applicant's submission staff finds the proposal as being consistent with the Criteria for Issuance in Chapter 24A-(b) 1 and 2, and (d), having found the proposal is consistent with the *Secretary of the Interior's Standards for Rehabilitation #2, #9, and #10*, and the *Chevy Chase Village Historic District Guidelines* outlined above.

### **STAFF RECOMMENDATION**

Staff recommends that the Commission **approve** the HAWP application under the Criteria for Issuance in Chapter 24A-8(b) (1), (2), and (d), having found that the proposal is consistent with the *Chevy Chase Village Historic District Guidelines* identified above, and therefore will not substantially alter the exterior features of the historic resource and is compatible in character with the district and the purposes of Chapter 24A;

and with the *Secretary of the Interior's Standards for Rehabilitation #2, #9, and #10*;

and with the general condition that the applicant shall present the **3 permit sets of drawings, if applicable to Historic Preservation Commission (HPC) staff for review and stamping** prior to submission for the Montgomery County Department of Permitting Services (DPS) building permits;

and with the general condition that final project design details, not specifically delineated by the Commission, shall be approved by HPC staff or brought back to the Commission as a revised HAWP application at staff's discretion;

and with the general condition that the applicant shall notify the Historic Preservation Staff if they propose to make **any alterations** to the approved plans. Once the work is completed the applicant will contact the staff person assigned to this application at 301-563-3400 or [michael.kyne@montgomeryplanning.org](mailto:michael.kyne@montgomeryplanning.org) to schedule a follow-up site visit.



FOR STAFF ONLY:

HAWP# 937249

DATE ASSIGNED

# APPLICATION FOR HISTORIC AREA WORK PERMIT

HISTORIC PRESERVATION COMMISSION  
301.563.3400

## APPLICANT:

Name: Roslyn Mazer and David Holzworth

E-mail: homeruns@aol.com

Address: 37 W. Irving Street

City: Chevy Chase

Zip: 20815

Daytime Phone: 202-362-3638

Tax Account No.: 00455281

## AGENT/CONTACT (if applicable):

Name: Jonathan Kuhn

E-mail: jonathan@kuhnarchitect.com

Address: 1 P Street NW

City: Washington, DC

Zip: 20001

Daytime Phone: 202-494-5061

Contractor Registration No.: \_\_\_\_\_

**LOCATION OF BUILDING/PREMISE:** MIHP # of Historic Property \_\_\_\_\_

Is the Property Located within an Historic District? ☒ Yes/District Name Chevy Chase Village

☐ No/Individual Site Name \_\_\_\_\_

Is there an Historic Preservation/Land Trust/Environmental Easement on the Property? If YES, include a map of the easement, and documentation from the Easement Holder supporting this application.

Are other Planning and/or Hearing Examiner Approvals /Reviews Required as part of this Application? (Conditional Use, Variance, Record Plat, etc.?) If YES, include information on these reviews as supplemental information.

Building Number: 37 Street: West Irving

Town/City: Chevy Chase Village Nearest Cross Street: Cedar Parkway Lot: 7 Block: 32

Subdivision: Chevy Chase Section II Parcel: 07-009-00455281

**TYPE OF WORK PROPOSED: See the checklist on Page 4 to verify that all supporting items for proposed work are submitted with this application. Incomplete Applications will not be accepted for review. Check all that apply:**

- |  |  |  |
|--|--|--|
| <input type="checkbox"/> New Construction    | <input type="checkbox"/> Deck/Porch Fence    | <input type="checkbox"/> Shed/Garage/Accessory Structure |
| <input checked="" type="checkbox"/> Addition | <input type="checkbox"/> Hardscape/Landscape | <input type="checkbox"/> Solar                           |
| <input type="checkbox"/> Demolition          | <input type="checkbox"/> Roof                | <input type="checkbox"/> Tree removal/planting           |
| <input type="checkbox"/> Grading/Excavation  | <input type="checkbox"/>                     | <input type="checkbox"/> Window/Door                     |
|  |  | <input type="checkbox"/> Other: _____                    |

I hereby certify that I have the authority to make the foregoing application, that the application is correct and accurate and that the construction will comply with plans reviewed and approved by all necessary agencies and hereby acknowledge and accept this to be a condition for the issuance of this permit.

*Emily Hirst*  
\_\_\_\_\_  
Signature of owner or authorized agent

23.December.2020

Date

**Description of Property:** Please describe the building and surrounding environment. Include information on significant structures, landscape features, or other significant features of the property:

The home sits on a corner lot at the intersection of West Irving Street and Cedar Parkway in the Chevy Chase Village District. The main structure, 2-story plus basement, is of the colonial revival type built in the first quarter of the 20<sup>th</sup> century. An addition was placed on the north, considered to be the rear of the house, that included a family room with bathroom and storage at the first floor and guest bedroom above. An open-air deck is located along the addition and faces Cedar Parkway with some exposure to Lot 8 to the north. The lot is heavily landscaped including mature tulip poplars to the Cedar Parkway face of the house and in proximity to the existing deck.

**Description of Work Proposed:** Please give an overview of the work to be undertaken:

Please see attached that includes additional notes of the existing and a detailed description of the proposed including a justification for the work.



37 West Irving Street is a corner lot bounded by West Irving Street on the front (south side) and Cedar Parkway on the west side. The house was built in 1920 before the Building Restriction Line (BRL) referenced in Section 8-16(c) of the Chevy Chase Building Regulations was established. As a result, the BRL actually runs through a segment of the original house from the edge of front door steps to the northwest corner of the original house. The western wall of the original house is 50 feet from Cedar Parkway at its farthest point at the southeast corner of the main structure. Because Cedar Parkway curves toward the east as it goes north, the distance between Cedar Parkway and the house decreases by approximately 2 feet at the northwest corner of the house. At the point where the BRL exits Lot 7 to Lot 8, it has moved east by approximately 11 feet. The trajectory of the BRL goes through the house from the front door steps and through the existing at-grade level deck.

The deck has three points of entry from the house: one opens to the deck from the original house through a pair of French doors in the dining room; one opens to the deck from a breakfast alcove; and the third opens through a set of sliding doors from the family room. The last two points of entry are from additions to the house.

The proposed sleeping porch addition would be a first floor extension of an existing condition. It would extend from the western face of the house on the line of the original structure -- within the footprint of the existing at-grade deck -- incorporating or replacing the piers built for the deck. It may be necessary to add additional piers, but they would conform to the geometry of the extended line of the original house and the line of the deck for the portion of the addition that ties into the northern wall of the existing addition. The angled northern wall of the sleeping porch is the only wall on the perimeter of the existing deck. The attached photos show the existing condition from several perspectives, including Cedar Parkway views, which are characterized by dense shrubbery and tall trees.

The proposed addition is designed to (1) fall within the footprint of the existing at-grade deck with the exception of the angled northern wall, (2) conform the materials and geometry of the windows, walls and roof line to the design elements and materials of the original house and previous additions, and (3) limit to the greatest extent possible any disturbance of the root structure of the trees nearest to the deck footprint. This is especially important for the old growth tulip poplar, which accounts for the angled north wall of the proposed addition. This approach will ensure both continuity with the existing structure and compatibility with the streetscape.

## JUSTIFICATION FOR THE ADDITION:

### **Accommodation for Aging in Place and Senior Living:**

We purchased this lovely property in 2017 to live in during our retirement years (we are both retired). One of the most attractive features of the home is a ground level room (now called the Family Room) with en suite bath that is adjacent to the deck on the west side of the property. Currently, the deck may be accessed from the Family Room via a set of sliding doors, from the dining room via a set of French doors, and from a kitchen nook area via a single door (See Photo # ). As we age, we anticipate that one or both of us will eventually need to live on the ground level of the house and will not be able to navigate stairs. Now that we have lived in the house for 2+ years, we appreciate more fully that the Family Room can be usefully converted to a master bedroom with two key modifications: (1) enlarging the current small inaccessible en suite bath (we are proceeding that that project separately), and (2) incorporating the deck into a 4-season room that can be accessed from at least two of the current access points described above.

If we are able to build the addition, the 4-season room would augment and enhance the existing Family Room space. Once built, it would be used now as supplementary space for small casual gatherings, dining, reading, and as a sleeping porch. Once we convert the Family Room into a first floor master bedroom, the room would be used to facilitate ground-level family visits, care giver visits, and to store items needed to support the bedroom.

### **Infeasibility of Alternate Locations for the Proposed Addition:**


As seen in the attached photos, it is not feasible to build an addition adjacent to the Family Room and en suite bathroom in any other location. The following restrictions pertain to the east and north of the current house footprint:

To the East: Section 8-16(g) of the Montgomery County Building Code, *Building and Dwellings Regulations*, provides that “no part of any building or structure shall be erected or maintained within seven (7) feet of the side or rear lots, nor within ten (10) feet of the nearest adjacent dwelling . . .” As shown in Photo # XX, the eastern wall of the house stands a few inches over 7 feet from the lot line, making it infeasible to build an addition there.

To the North: As shown in Photo # XX and the boundary survey, the northern wall stands 26.22 from the lot line, making it infeasible to build an addition there. Section 16 (h) – “Rear setback for main building. No part of any main building shall be erected within twenty (20) feet of the rear lot line of the property upon which it is located.”] Furthermore, space between the house and the fence is occupied by another very large tulip poplar. As noted above, our intent is to minimize disturbance of old growth trees.

**HAWP APPLICATION: MAILING ADDRESSES FOR NOTIFYING**  
 [Owner, Owner's Agent, Adjacent and Confronting Property Owners]

Owner's mailing address 37 W Irving Street Chevy Chase Village, MD 20815	Owner's Agent's mailing address
Adjacent and confronting Property Owners mailing addresses	
Sasan Talali/Shadi Pezeshki 35 W Irving Street Chevy Chase Village, MD 20815	David O'Neil/Laura M Billings 5904 Cedar Parkway Chevy Chase Village, MD 20815
Martin J. + Lori Weinstein 5815 Cedar Parkway Chevy Chase Village, MD 20815	John D. + Ellen F. Talbot + 5906 Cedar Parkway Chevy Chase Village, MD 20815
Tom + Melissa Dann 34 West Kirke Street Chevy Chase Village, MD 20815	

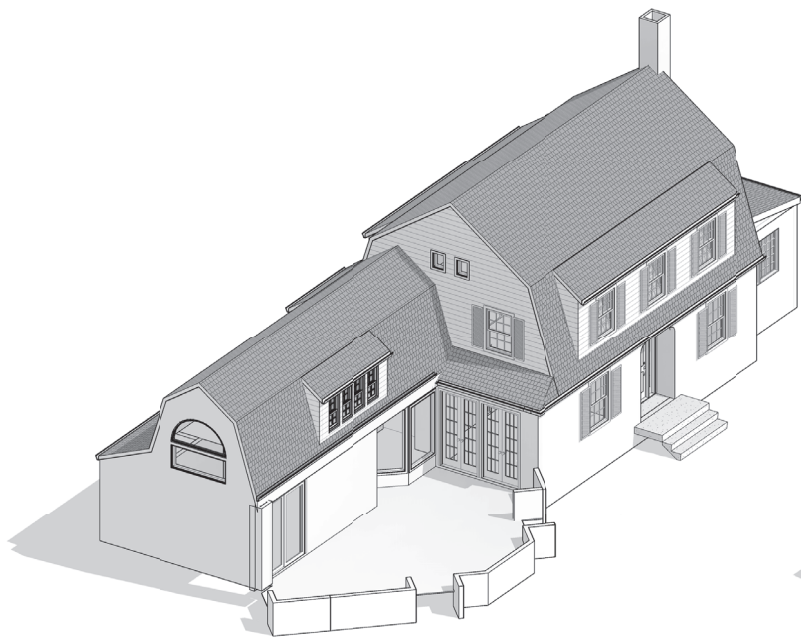

EXISTING RENDERING



PROPOSED RENDERING

## Mazer Holzworth Residence

37 West Irving Street, Chevy Chase,  
Montgomery County, MD 20815

I hereby certify that these documents  
were prepared or approved by me, and  
that I am a duly licensed architect under  
the laws of the State of Maryland, license  
number 15238, exp. date of 10.24.21.



JONATHAN KUHN ARCHITECT  
ONE P STREET NW WASHINGTON DC 20001  
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JONATHAN@KUHNARCHITECT.COM  
WWW.KUHNARCHITECT.COM



## Mazer Holzworth Residence

37 West Irving Street, Chevy Chase,  
Montgomery County, MD 20815  
12 October, 2020 Issued for Permit

Symbol	Angle	Alt	MFR	Manufacturer(S)
#	Number	Alt	Minimum	Miscellaneous
A	Centimetre	MTD	Masonry	Operating
1	One-inch nominal thickness	MTD	Moulded	
1X	Two inch nominal thickness	MTD	Moulding	
ABV	Above	NW	Microwave Oven	
AC	Air	NC	North	
ACCUST	Acoustical	NIC	Not in Contract	
ACJ	Adjustable Ceiling Tile	NID	Number	
ADJ	Adjustable, Adjustable	NTS	Not to Scale	
AFF	Aluminum	OV	Overall	
AHU	Air Handler Unit	OD	Outside Diameter	
ALT	Alternate	OC	On Center	
ALUM	Aluminum	OCFCI	Offer Furnished, Contractor Installed	
ANDOX	Andoxized	OFF	Off	
APPROX	Approximate	OP	Opposite Hand	
B	Board (or Board, if applicable)	OPNG	Opening	
BTWN	Between	OTF	Outside Finished	
BLDG	Building	PART	Partition	
BLKG	Blocking	PERF	Perforated	
BLT	Bolt	PL	Plate/Property Line	
BM	Beam	PLM	Plastic Laminite	
BSM	Bottom	PLX	Plexus	
BRG	Bearing	PLYWD	Plywood	
BSMT	Basement	POLY	Polyethylene	
CAB	Cabinet	PR	Pair	
CBS	Cable	PSF	Pound Per Square Foot	
CH	Ceiling	PSI	Pound Per Square Inch	
CHJ	Ceiling Joint	PT	Pressure Treated	
CL	Cladding	PDI	Painted	
CLD	Cladding	POLYCLD	Polyvinyl Chloride	
CLO	Closet	QTY	Quantity	
CLR	Clear	R	Radius	
COL	Column	RO	Rough Opening	
CONC	Concrete	RL	Rain Leader	
CONST	Construction	RCP	Reflected Ceiling Plan	
CONC	Concrete	RECC	Recessed	
CORR	Corrugated	REF	Refrigerator	
CPT	Cut	REG	Register	
CS	Cast Stone	RENF	Reinforcing	
CSK	Casement	REQD	Required	
CSMT	Casement	RESIL	Resilient	
CTR	Ceramic Tile	REV	Revision	
CTR	Center/Counter	RL	Rain Leader	
DBL	Centered	RM	Room	
QW	Core	RS	Road Top	
CRL	Double	S	South	
DEMOL	Demolish, Demolition	S4S	Surface Four Sides	
DET	Detail	SC	Solid Core	
DF	Drainage Foundation	SCHED	Schedule(s)	
DH	Drainage Houting	SECT	Section	
DA	Diamond	SHT	Sheet	
DM	Dimension	SIM	Similar	
DN	Down	SF	Square Feet	
DR	Door	SF	Specification	
DWS	Downspout	SQ	Square	
DW	Downspout	SS	Stainless Steel	
DWG	Drawing	STD	Standard	
E	East	STRUT	Strut	
EA	Elevation	STUR	Storage	
ELJ	Elevation Joint	STRUT	Strutture	
ELEC	Electrical	SUSP	Suspend	
EMER	Emergency	T&G	Tongue and Groove	
EQ	Equipment	TBD	To Be Determined	
EQUIP	Equipment	TEL	Telephone	
EW	Exhaust Water Cooler	TEMP	Temperature	
EXIST	Existing	THK	Thick	
EXH	Exhaust	TILE	Tile	
EXP	Expansion, Exposed	TO	Top of ( )	
EXT	Exterior	TY	Type	
FA	Fire Alarm	UL	Underwriters Laboratories, Inc.	
FBO	Furnished by Owner	UNFN	Unfinished	
FD	Floor Door	UNF	Unless Noted Otherwise	
FND	Foundation	US	Underseite	
FEC	Fire Extinguisher Cabinet	UTL	Utility	
FF	Finish Floor	V	Vapor Barrier	
FFL	Finish Floor	VCM	Vinyl Composition Tile	
FN	Finish	VENT	Ventilator(s)	
FLASH	Flashings	VERT	Vertical	
FLUR	Floor	VNF	Ventilate in Field	
FOM	Face of Masonry	VNR	Veneer	
FOS	Face of Structure (or Face of Window, if applicable)	W	West	
FRT	Fireproof	WC	Water Closet	
FRT	Fireproof	WO	Wood	
FRM	Form	WF	Water-Resistant	
FRM	Forming	WH	Water Heater	
FTG	Footing	W	With	
FURN	Furniture/Furnish	WO	Without	
FURN	Furning	WTM	Weight	
FVC	Fire Valve Cabinet	WWM	Welded Mesh	
GA	Galvanneal			
GALV	Galvanized			
GEN	General			
GL	Ground Fault Interrupter			
GWB	Gypsum Wall Board			
GYP	Gypsum			
HB	House Bldg			
HC	Half-Corner Handicap			
HD	Head			
HOWE	Hardwood			
HM	Heavy Metal			
HORIZ	Horizontal			
HT	Height			
HTR	Heater			
HVAC	Heating/Ventilation/Air-Conditioning			
HW	Hot Water			
IG	Insulation			
INCAN	Incandescent			
INCL	Included(s)			
INSUL	Insulation			
INT	Interior			
JAN	Janitor			
JO	Joint			
KIT	Kitchen			
LAV	Lavatory			
LEV	Level			
MAS	Masonry			
MAX	Maximum			
MF	Medium Density Fiberglass			
MD	Medium Density Overlay			
MECH	Mechanical			
MEZZ</				

[illegible]

**DRAWING BLOCK TITLE**

**INTERIOR ELEVATION MARKER**

**EXTERIOR ELEVATION MARKER**



**BUILDING & WALL SECTION MARKER**

**SECTION DETAIL REFERENCE MARKER**

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## A.001





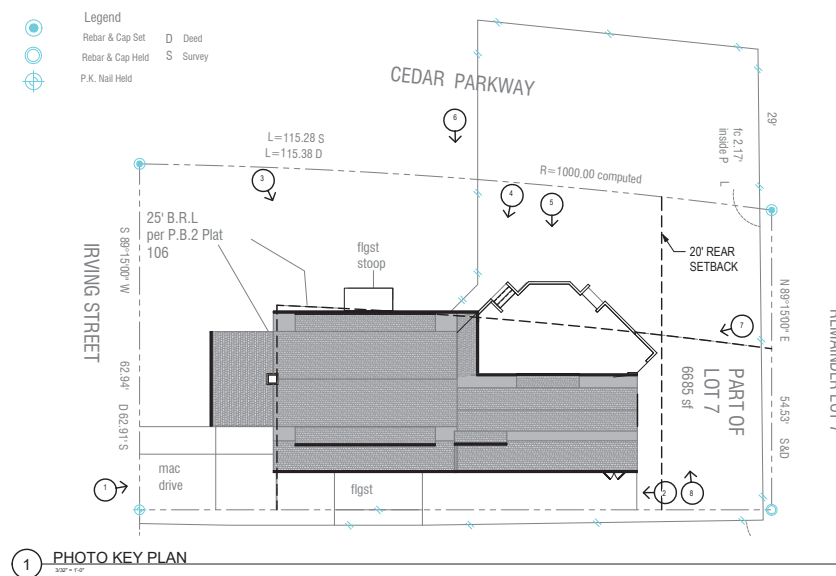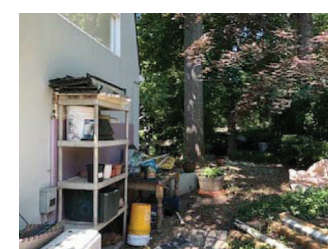


**Mazer Holzworth Residence**  
37 West Irving Street, Chevy Chase,  
Montgomery County, MD 20815

REAL


SHEET NO.

**D.100**



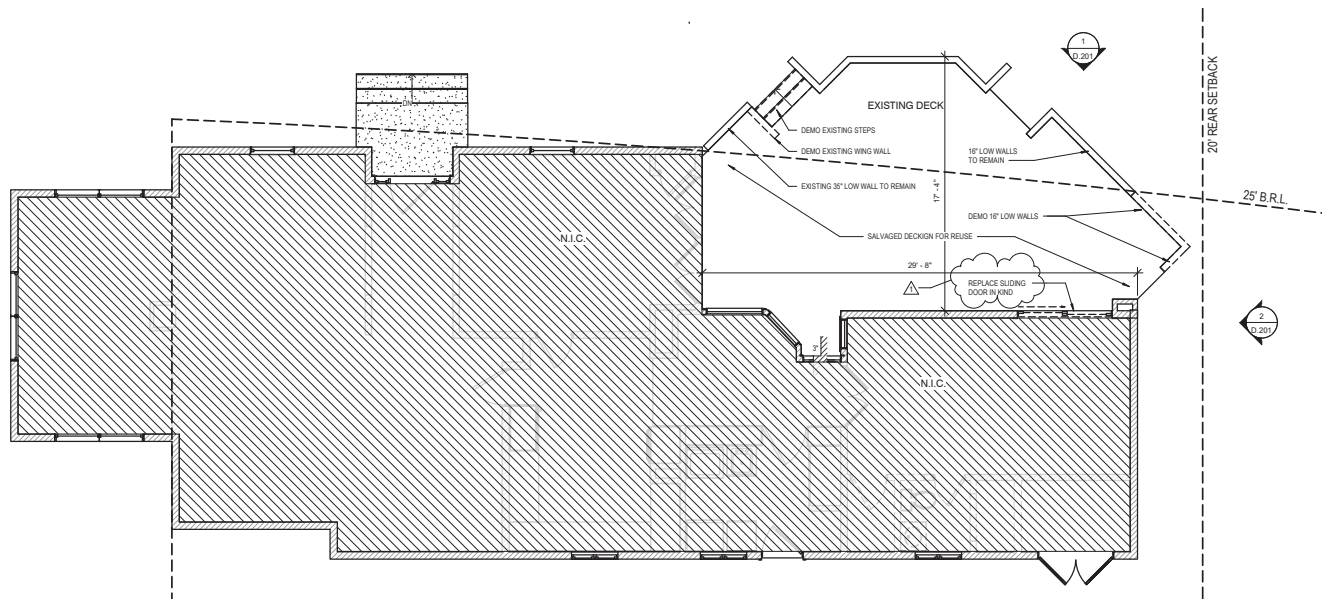

1 EXISTING FIRST FLOOR  
1/8" = 1'-0"

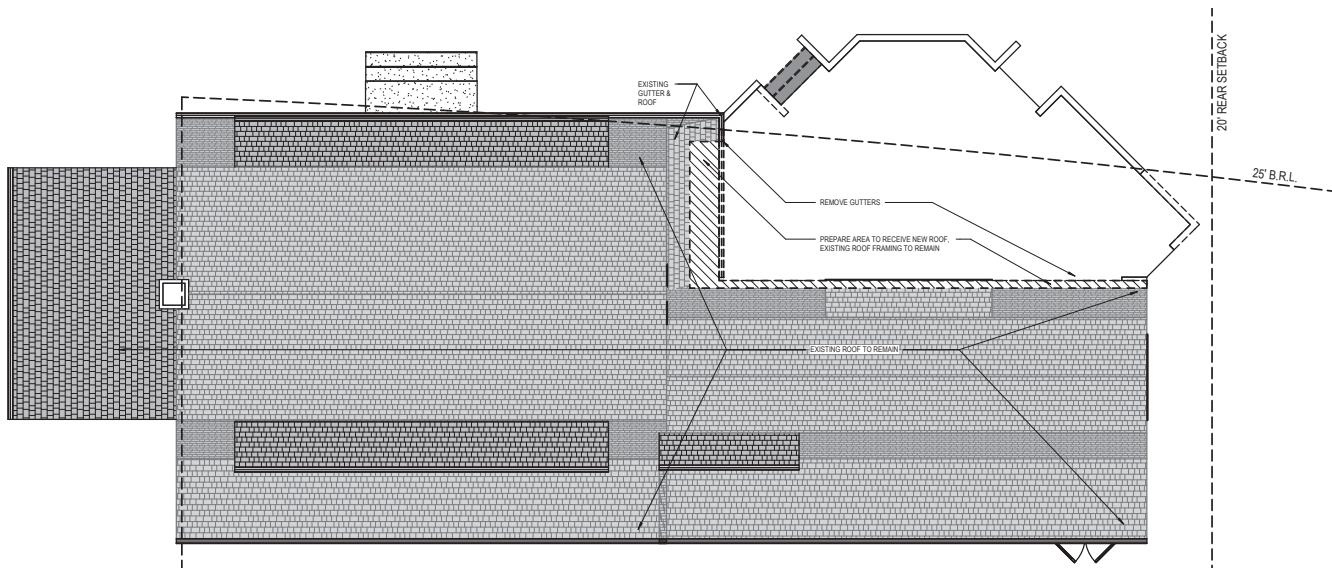

2 EXISTING ROOF PLAN  
1/8" = 1'-0"

### DEMOLITION NOTES

1. ALL WORK SHALL BE COMPLETED IN ACCORDANCE WITH THE REGULATIONS SET BY THE BUILDING DEPARTMENTS AND AGENCIES HAVING JURISDICTION.
2. DEMOLITION INCLUDES, BUT IS NOT LIMITED TO, WHAT IS INDICATED ON THE DRAWINGS. THE INTENT IS TO PROVIDE THE GENERAL SCOPE OF DEMOLITION REQUIRED TO COMPLETE THE WORK DEMONSTRATED IN THE CONTRACT DRAWINGS. COORDINATE DEMOLITION WITH THE PROPOSED LAYOUT, FURNISHINGS, FIXTURES AND MATERIALS INDICATED IN THE FOLLOWING DRAWINGS.

### WALL KEY:

- [ - - - - ] EXISTING WALLS TO BE DEMOLISHED
- [ // // ] EXISTING WALLS TO REMAIN

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12.October. 2020  
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NO. DATE  
1 12.11.20





SHEET NAME  
**EXISTING FIRST  
FLOOR & ROOF PLANS**

SCALE  
As indicated

SHEET NO.

**D.101**

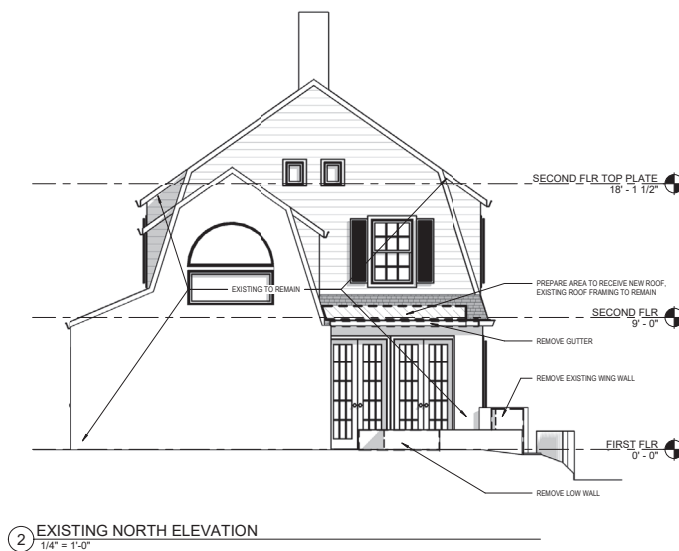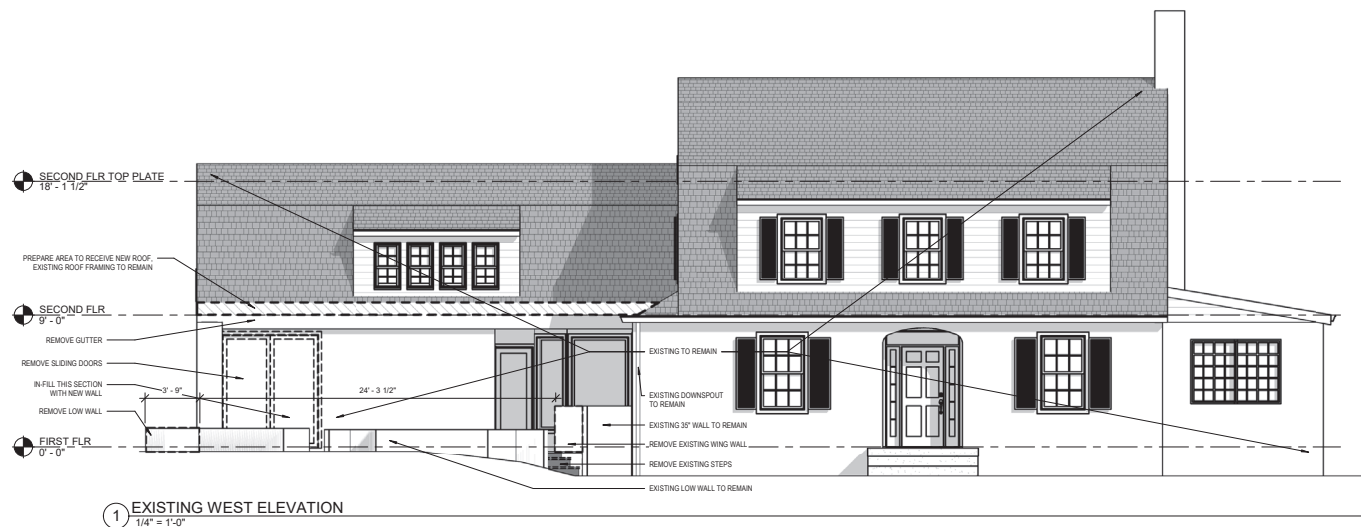

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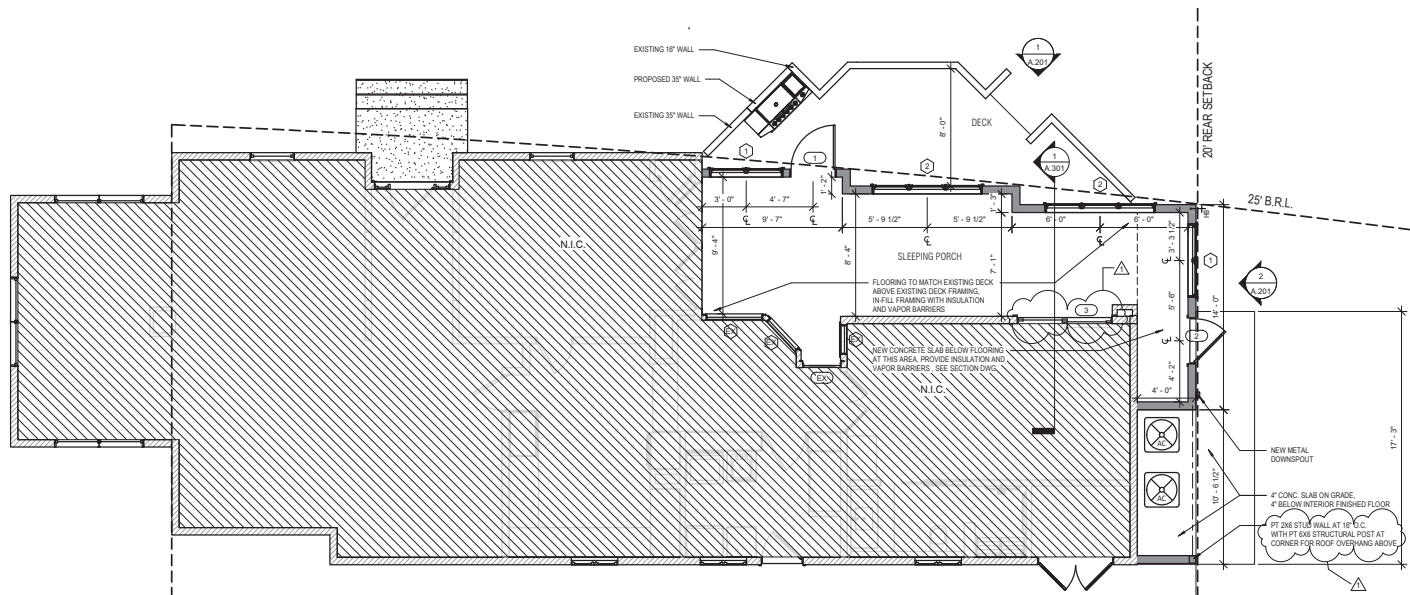


SHEET NAME  
EXISTING ELEVATIONS


SCALE  
1/4" = 1'-0"

SHEET NO.

D.201



1 PROPOSED FIRST FLOOR

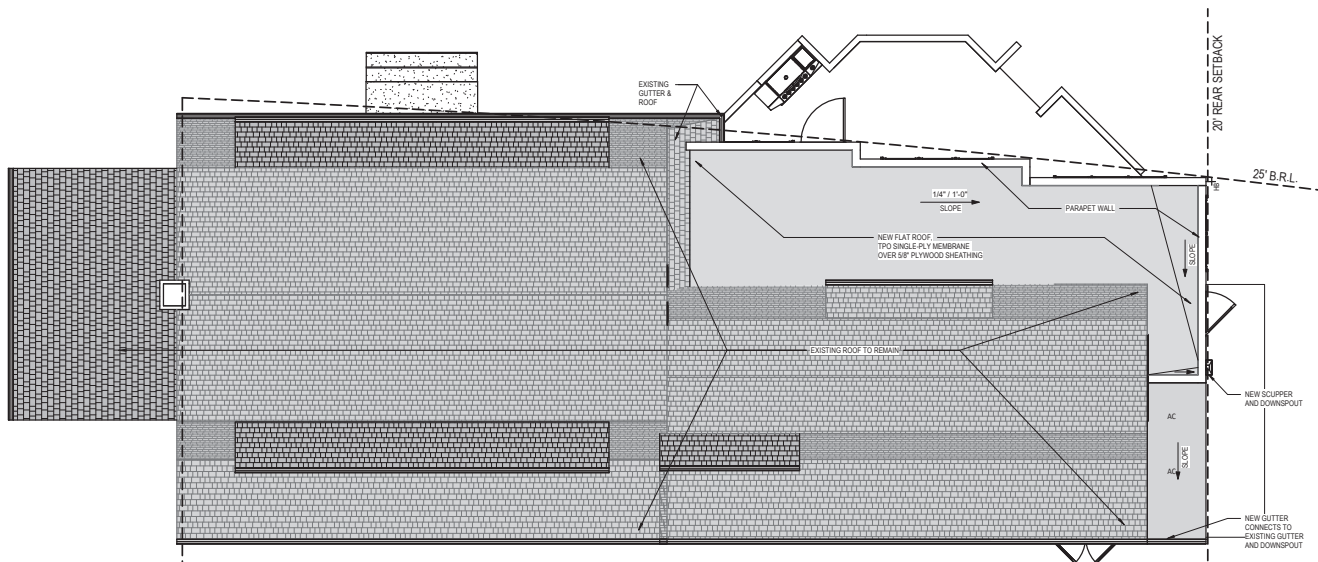

2 PROPOSED ROOF PLAN

### PLAN GENERAL NOTES

1. TYPICAL INTERIOR WALL IS 2X4 WOOD STUD AT 16" O.C. WITH 1/2" DRYWALL TO BOTH SIDES, U.N.O.
2. USE MOISTURE RESISTANT "PURPLE BOARD" DRYWALL AT ALL WET LOCATIONS.
3. DOORS ARE TO BE LOCATED 6" FROM THE NEAREST PERPENDICULAR WALL OR CENTERED ON WALL, U.N.O.
4. DOORS AT CLOSETS SHALL BE LOCATED AT THE CENTER OF THE INTERIOR FINISHED SPACE, U.N.O.
5. MIN U FACTOR FOR GLAZING WILL MEET 0.35

### WALL KEY:

- EXISTING WALLS TO REMAIN
- NEW WALL

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JONATHAN KUHN ARCHITECT

SHEET NAME  
PROPOSED FIRST  
FLOOR & ROOF PLANS


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As indicated

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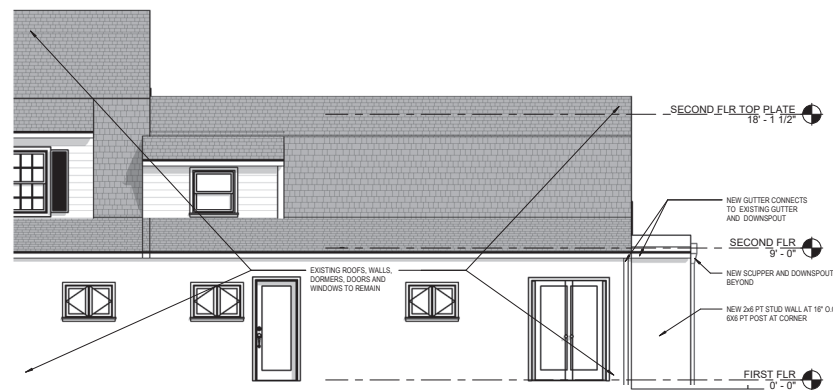
A.101



1 PROPOSED WEST ELEVATION  
1/4" = 1'-0"

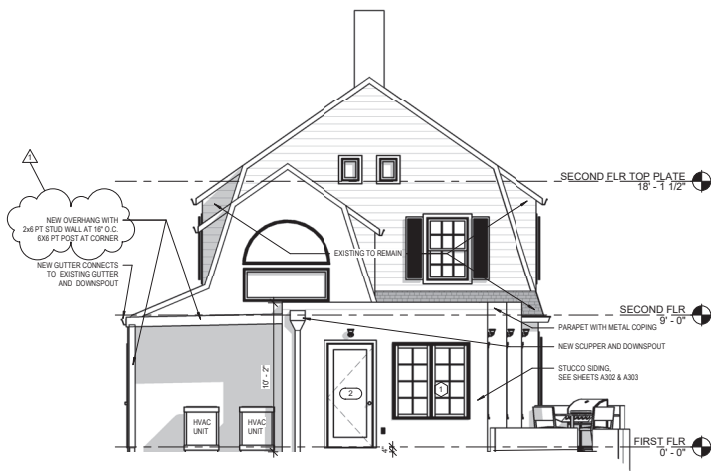

2 PROPOSED NORTH ELEVATION  
1/4" = 1'-0"



3 PROPOSED EAST ELEVATION  
1/4" = 1'-0"

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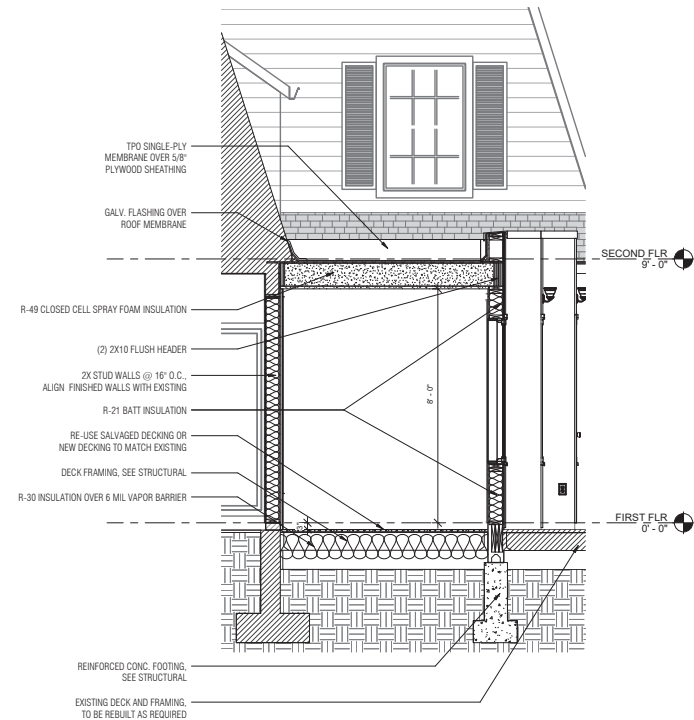
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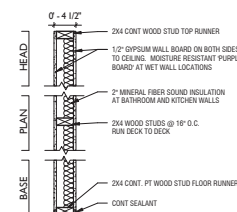
SHEET NAME  
PROPOSED ELEVATIONS

SCALE  
1/4" = 1'-0"


SHEET NO.  
A.201



1 SECTION AT SLEEPING PORCH  
1/2" = 1'-0"




INTERIOR PARTITION WALL ASSEMBLY  
SCALE: 1" = 1'-0"

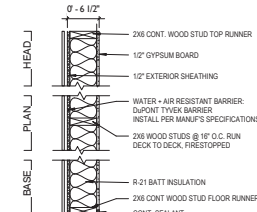


EXTERIOR FRAMED WALL ASSEMBLY  
SCALE: 1" = 1'-0"

WALL TYPES  
1" = 1'-0"




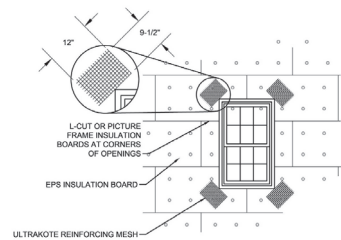


1 TYP. REINFORCED MESH AT OPENINGS

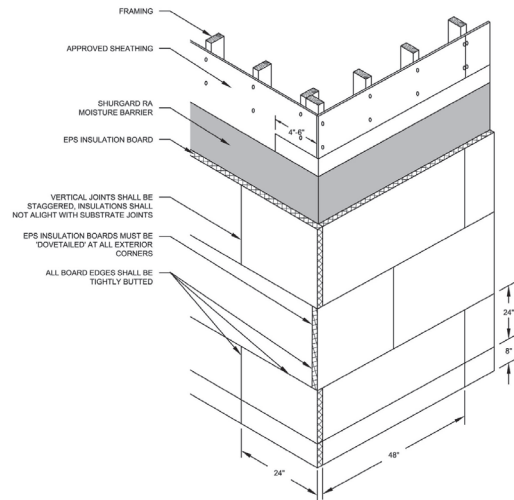


2 TYP. INSULATION BOARD LAYOUT

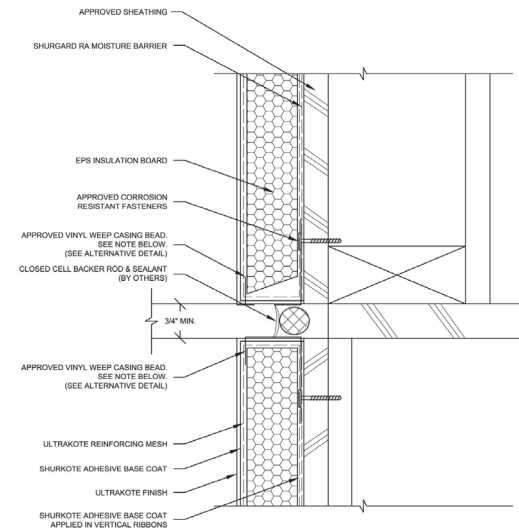


3 CONTROL JOINT DETAIL @ FLOOR LINE

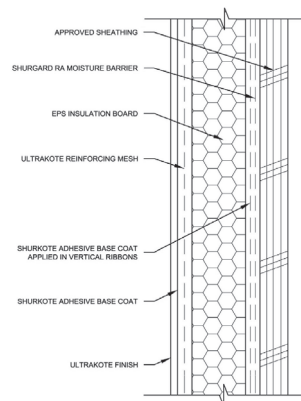


4 TYP. CROSS SECTION

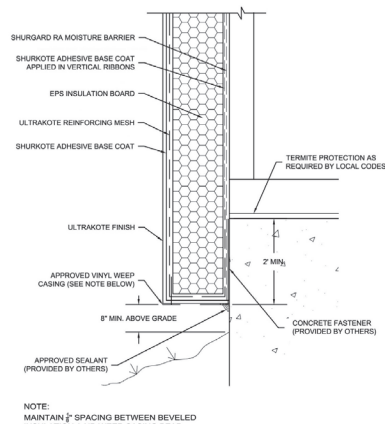

5 TERMINATION @ FOUNDATION LINE

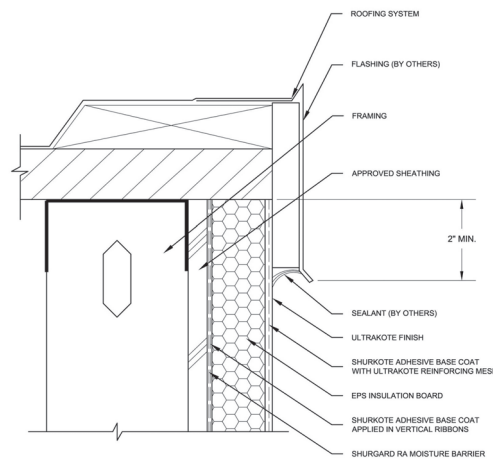

6 FLAT ROOF TERMINATION

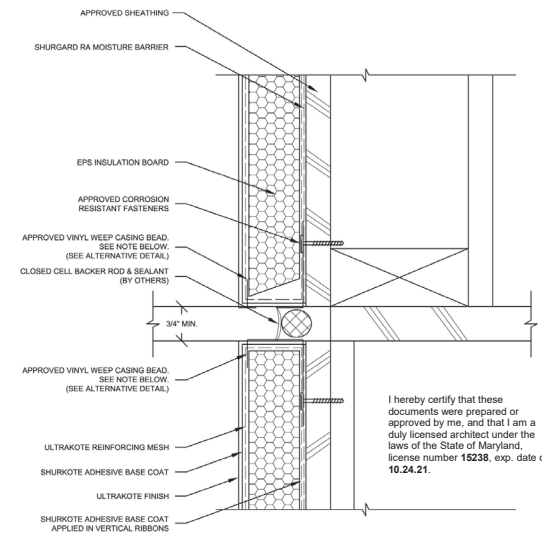

7 DETAIL @ BUILDING EXPANSION JOINT

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SHEET NAME  
STUCCO SIDING  
TYPICAL DETAILS

SCALE  
6" = 1'-0"

SHEET NO.


A.302

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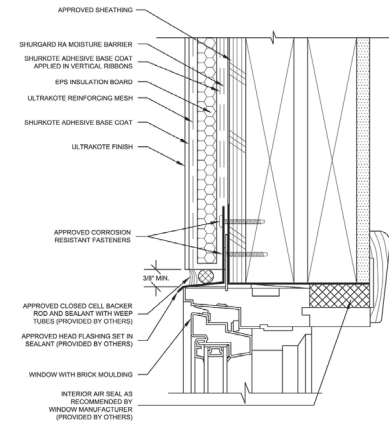
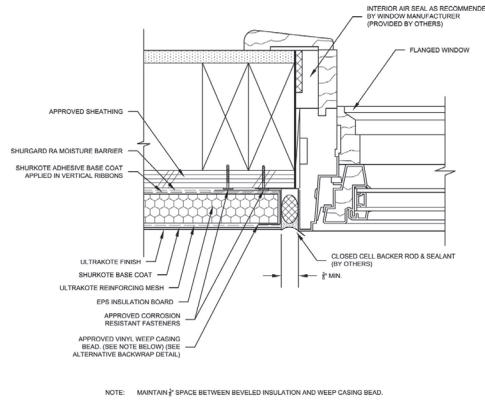
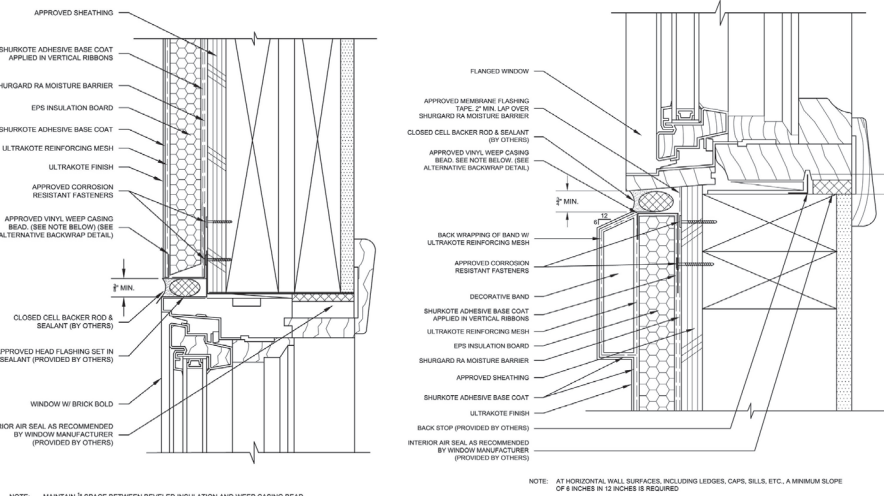


SHEET NAME  
STUCCO SIDING  
TYPICAL DETAILS

SCALE  
6" = 1'-0"

SHEET NO.

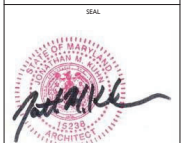A.303






1 TYP. DETAIL @ WINDOW HEAD

2 TYP. DETAIL @ WINDOW SILL

3 TYP. DETAIL @ WINDOW JAMB

4 ALTERNATE BACKWRAP

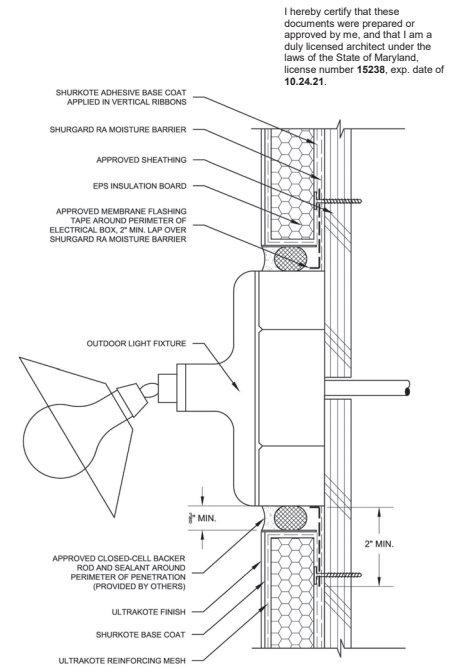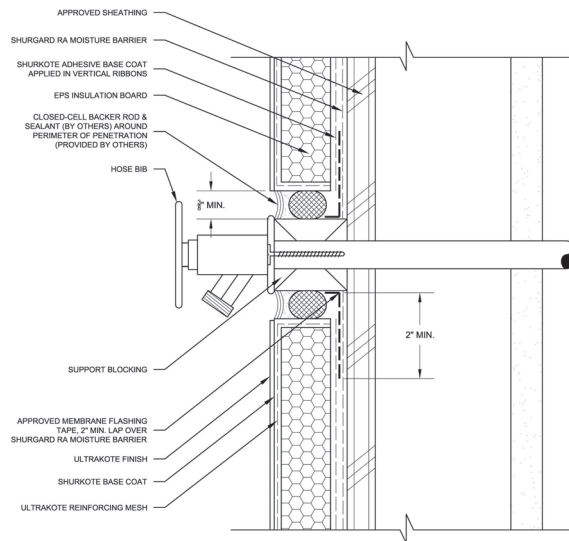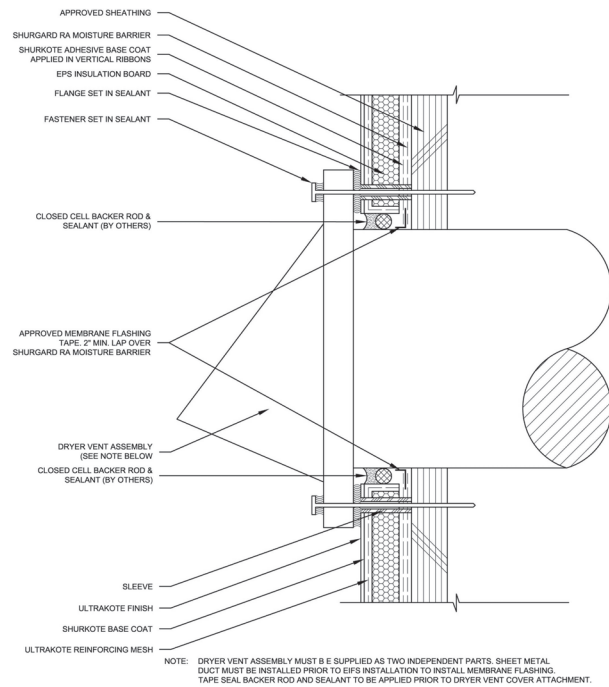


5 DETAIL @ EXHAUSTED VENT

6 DETAIL @ PIPE PENETRATION

7 TYP. ELEC. BOX PENETRATION



DOOR SCHEDULE							
TYPE MARK	DIMENSIONS		TYPE	FINISH	FRAME MATERIAL	U-FACTOR	SHGC
	WIDTH	HEIGHT					
01	3'-0"	7'-0"	FIBERGLASS	PTD	PTD WD	MAX 0.35	MAX 0.4
02	3'-0"	7'-0"	FIBERGLASS	PTD	PTD WD	MAX 0.35	MAX 0.4
03	3'-0"	6'-8"	SOLID CORE HARDBOARD	PTD	PTD WD	MAX 0.35	MAX 0.4

NOTES:  
A. INTERIOR DOOR TYPE IS FLUSH-PANEL SOLID CORE HARDBOARD PRE-HUNG STYLE. PAINT GRADE.  
B. EXTERIOR DOORS AND ENTRANCE DOOR TO INCLUDE LOCKSET, DEADBOLT, AND SELF CLOSER.  
C. FRAMES ARE SOLID POPLAR JAMB WITH SQUARE CORNER HINGE.  
D. FRAME DEPTH VARIES. FIELD VERIFY PRIOR TO ORDERING.  
E. MINIMUM U-FACTOR FOR GLAZING AT EXTERIOR DOORS WILL MEET 0.35.

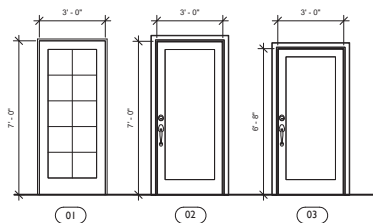

WINDOW SCHEDULE						
TYPE MARK	DIMENSIONS		MANUF/STYLE	TYPE	SHGC VALUE	U VALUE
	WIDTH	HEIGHT				
01	5'-0"	5'-0"	JELD-WEN/ CLAD WOOD	FIXED	MAX 0.40	MAX 0.35
02	7'-6"	5'-0"	JELD-WEN/ CLAD WOOD	CASEMENT/FIXED/CASEMENT	MAX 0.40	MAX 0.35

WINDOW SCHEDULE NOTES:  
A. CONTRACTOR TO VERIFY ALL WINDOWS AND MASONRY OPENINGS IN FIELD  
B. EXPRESS UNITS TO MEET OR EXCEED THE FOLLOWING CODE DIMENSION -  
CLEAR OPENING AREA: 5.7 SQ FT, CLEAR OPENING WIDTH 20", CLEAR OPENING HEIGHT 24"  
C. ALL GLAZING IN HAZARDOUS LOCATIONS AS DEFINED BY IBC 2406.4 SHALL BE SAFETY GLAZING AND BE LABELED PER IBC 2406  
D. OPERABLE WINDOWS TO COMPLY WITH IBC 2015 SECTION 1013.8 WINDOW SILLS - FOR OPERABLE WINDOWS WITH SILL HEIGHT LESS THAN 36" ABOVE FINISH FLOOR AND LOCATED MORE THAN 12" FROM EXTERIOR SURFACE, PROVIDE WINDOW LIMIT DEVICE TO RESTRICT WINDOW OPENING FOR 4" OR MORE.  
E. U-FACTOR FOR GLAZING MAXIMUM 0.35 AND SHGC MAXIMUM 0.40

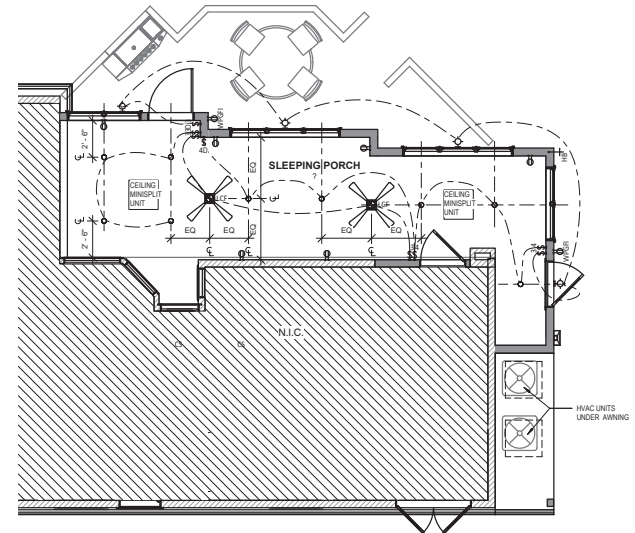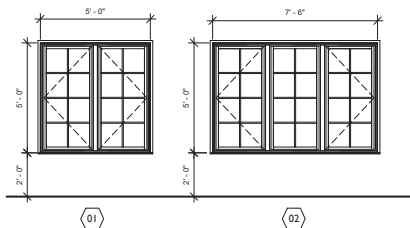

1 FIRST FLOOR-REFLECTED CEILING PLAN  
1/4" = 1'-0"

## RCP + ELECTRICAL KEY

○	RECESSED CAN	S	SINGLE POLE SWITCH
⊕	EXTERIOR SCENE	S	DIMMER SWITCH
⊕	CEILING FAN WITH LIGHT	S	3-WAY SWITCH
⊕	HOSE BIB	S	4-WAY SWITCH
⊕		⊕	TYPICAL DUPLEX RECEPTACLE, WILL BE AT 18" AFF. UND
		⊕	GFI AT WET LOCATIONS
		⊕	GFI AT EXTERIOR LOCATIONS w/WATERPROOF COVER
		⊕	WFI IN ALL INHABITABLE SPACES
		⊕	TYPICAL DUPLEX RECEPTACLE, WATERPROOF

## GENERAL RCP NOTES

- ALL ELECTRICAL REQUIREMENTS INCLUDING SWITCHING, RECEPTACLES (SPACING AND LOCATIONS) WILL ADHERE TO THE 2011 NFPA NATIONAL ELECTRICAL CODE
- ALL OUTLETS TO BE WHITE STANDARD TYPE
- ALL SWITCHES TO BE WHITE TOGGLE TYPE
- RECEPTACLE AND SWITCH COVER PLATES ARE WHITE, U.N.O.
- ALL VISIBLE SCREWS TO BE HORIZONTALLY ALIGNED
- ALL LIGHTS TO BE CENTERED IN ROOM, U.N.O.
- RECEPTACLES SHOWN ALONGSIDE SWITCHES ARE TO BE CENTERED BELOW SWITCHES, U.N.O.
- RECEPTACLES SHOWN BELOW WINDOWS WILL BE CENTERED ON WINDOW OPENING. ALL ELECTRICAL REQUIREMENTS INCLUDING SWITCHING, RECEPTACLES (SPACING AND LOCATIONS) WILL ADHERE TO THE 2014 NFPA NATIONAL ELECTRICAL CODE
- RECESSED LIGHT FIXTURES INSTALLED IN THE BUILDING THERMAL ENVELOPE SHALL BE AIR TIGHT, IC RATED, AND SEALED TO THE DRYWALL
- A MIN OF 75% OF LAMPS IN PERMANENT FIXTURES OR 75% OF PERMANENT FIXTURES SHALL USE HIGH EFFICIENCY LAMPS.

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SHEET NAME  
REFLECTED CEILING  
PLAN, DOOR  
SCHEDULE, WINDOW  
SCHEDULE  
SCALE  
As indicated  
SHEET NO.  
A.501

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## Barcelona BAW-6

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### DESCRIPTION

6" Barcelona Wall Mount

- **Dimensions:** 5.75"W x 11"H x 6.5"D
- **Extension:**
- **Canopy/Back Plate Dimensions:** 5.25" x 6"
- **Mounting Center to Top:** 5.25"
- **Bulb Type:** 1-100W Medium (not included)
- **Safety Rating:** Suitable for Wet Locations
- **Finish Shown:** Bronze
- **Ships Via:** Small Parcel

### Glass



White Opalescent

### Finish

Slate





## OPERATOR SECTIONS

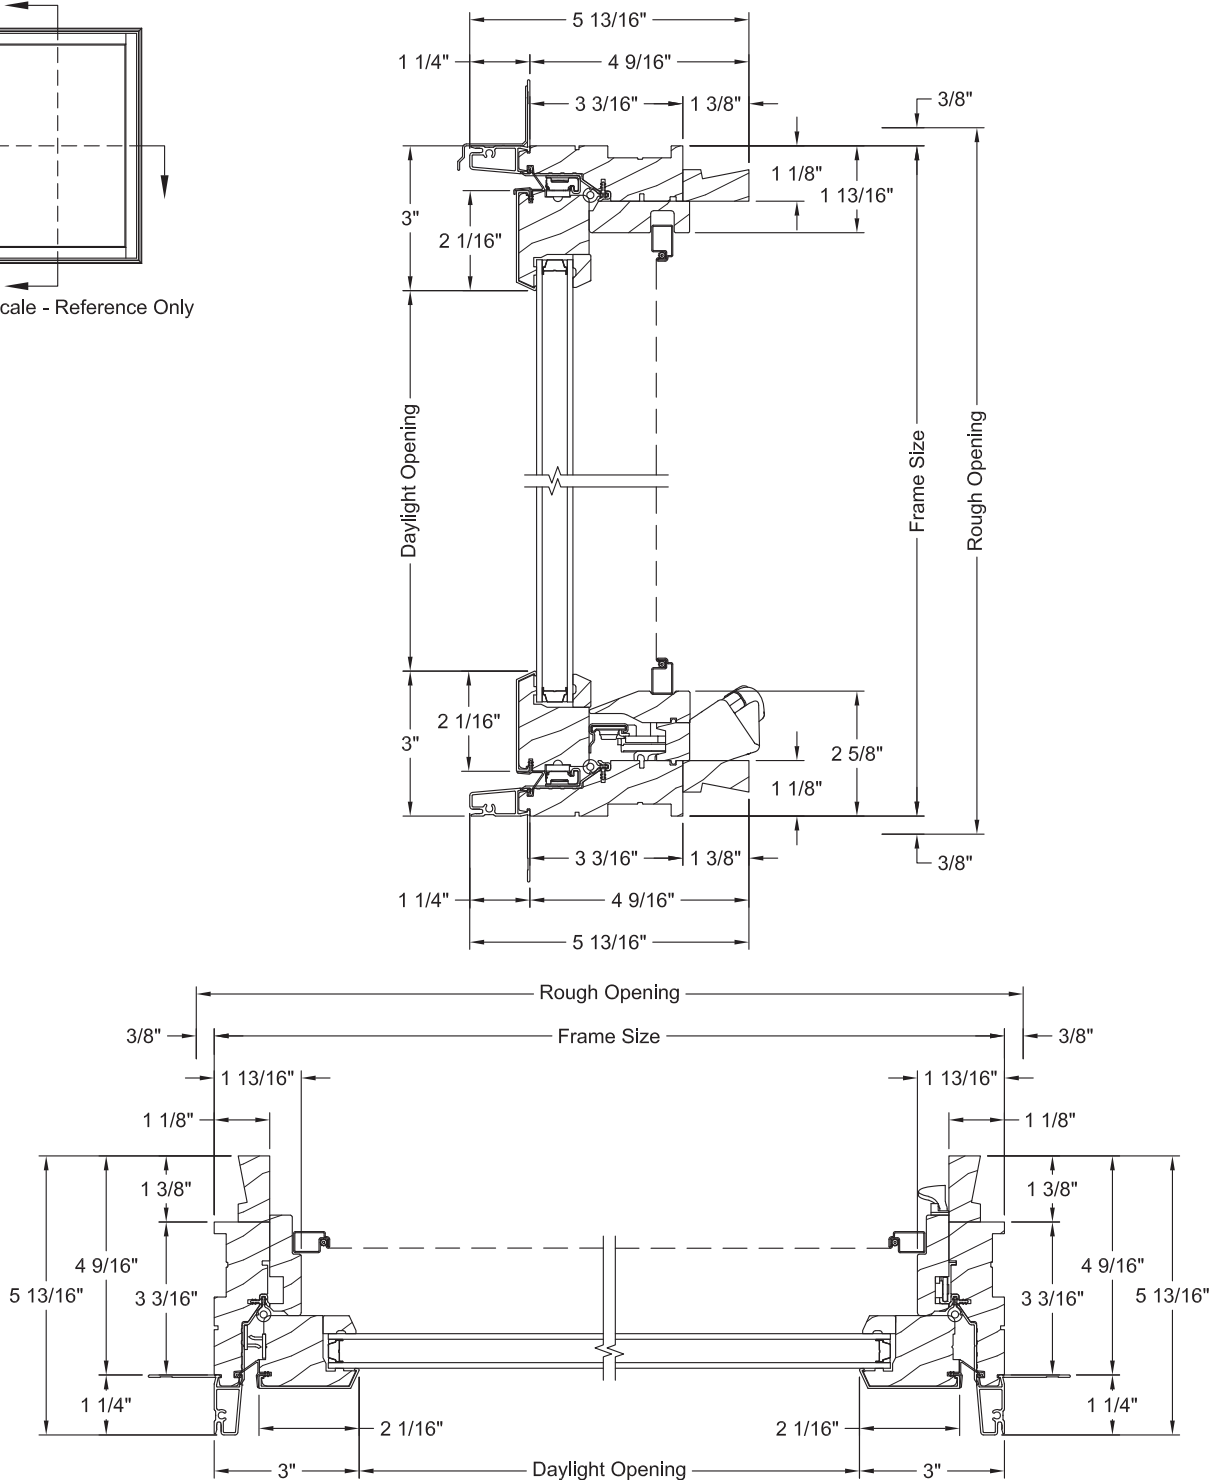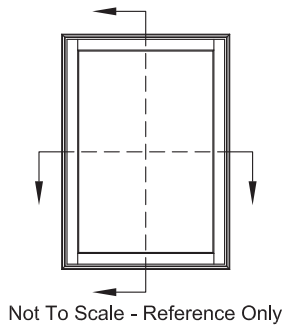



STATIONARY SECTIONS

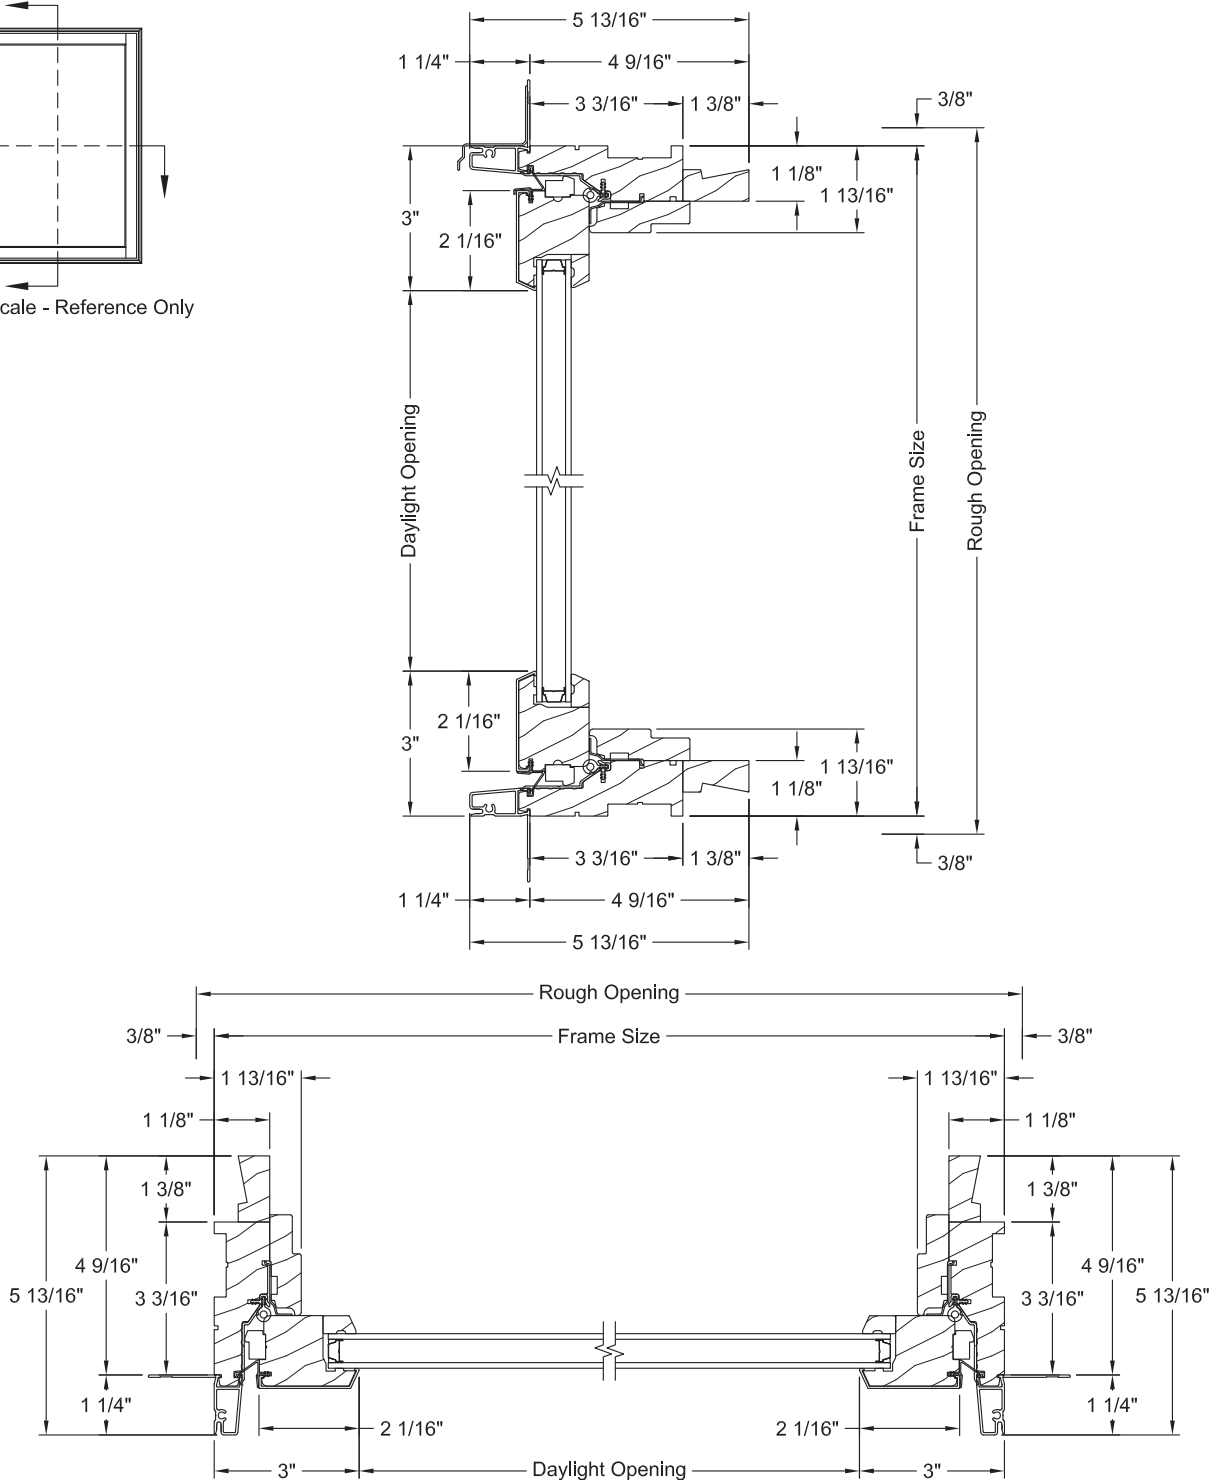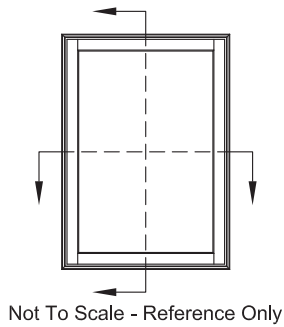






## GRID & GLASS STOP OPTIONS


Exterior ← → Interior

### SDL Options

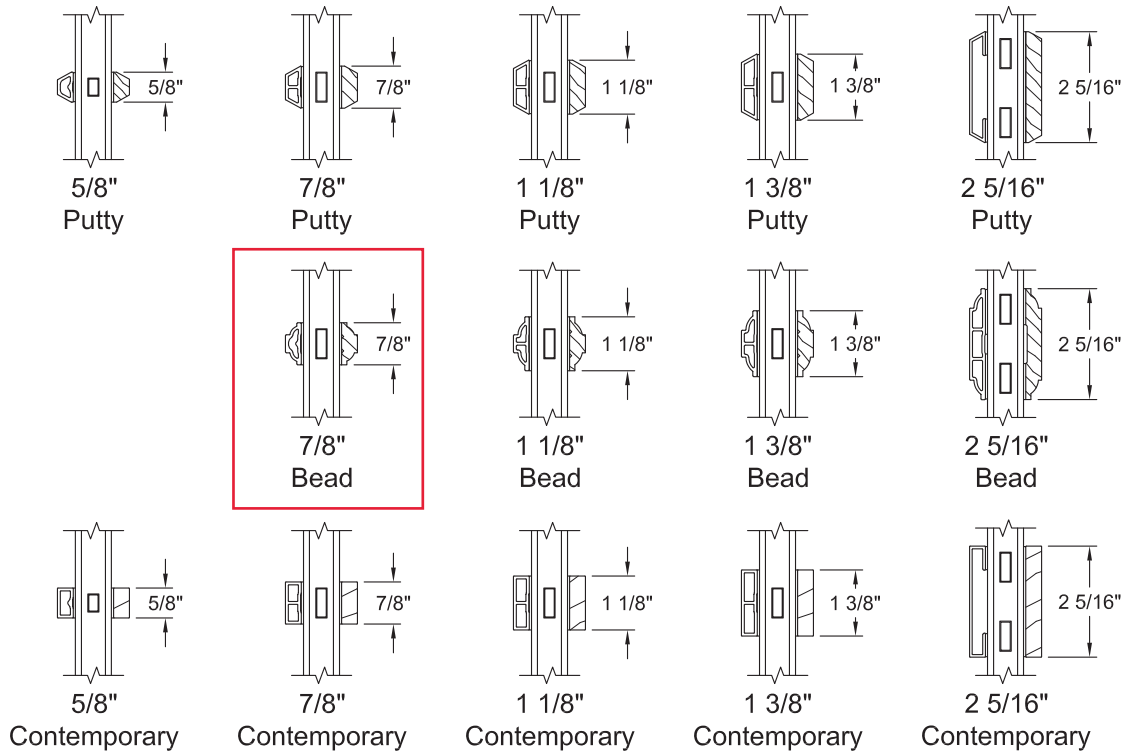


Note: Various Combinations of the SDL Bars Shown are Available


### GBG Options

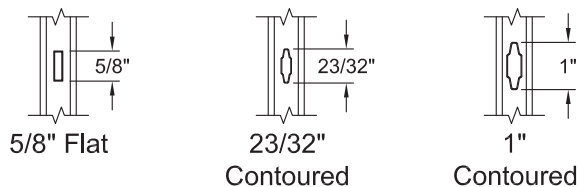

### Grille Options

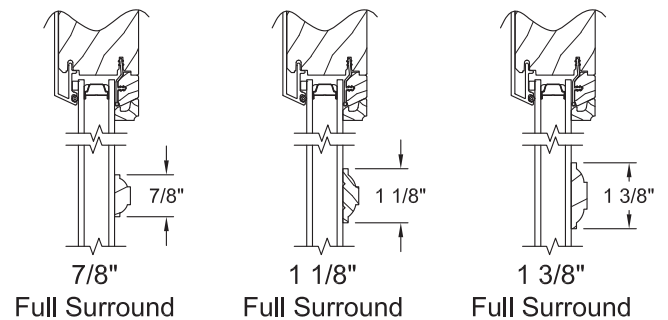


### Glass Stop Options

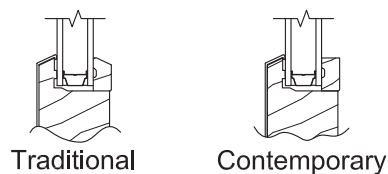





MULLION OPTIONS

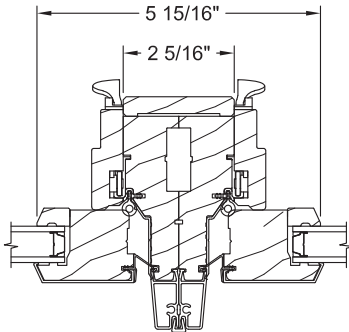


Operator / Operator

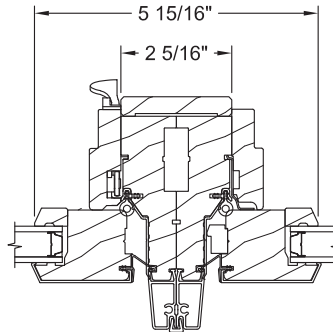


Operator / Stationary

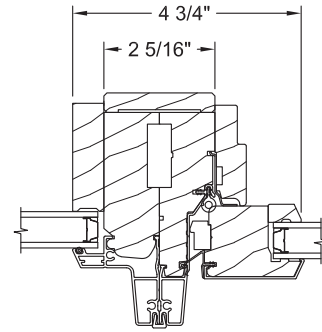


Direct Set / Operator

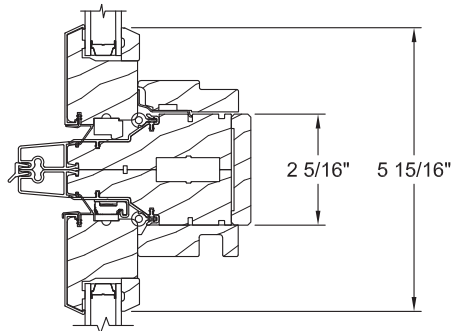


Stationary  
Operator

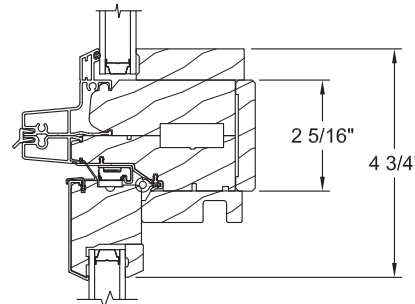

Direct Set  
Operator

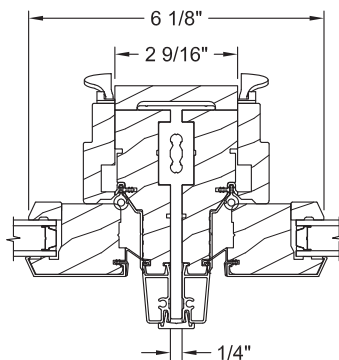

Operator / Operator  
1/4" Structural Mull

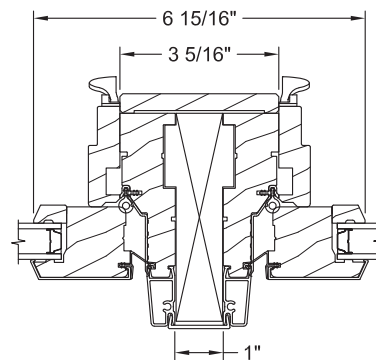

Operator / Operator  
1" Solid Spread Mull



[View full-size in new tab](#)

# Mitsubishi MXZ-2C20NA2-U1 - M-Series Multi-Zone Outdoor Heat Pump Unit, 20K BTU, R410A, 208-230/1/60

Item: MXZ2C20NA2U1    MFR: MXZ-2C20NA2-U1

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Sign in or register for pricing.

### Quantity \*

1

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Save products for later, or create order templates to quickly re-buy items for routine jobs.

Add To Order Template

## Inventory At Nearby Branches

### North Carolina

- 0 Charlotte #704
- 10 Hickory #703
- 5 Raleigh #708
- 7 Wilmington #706
- 1 Winston - Salem #701

### Virginia

2	Chesapeake #713
3	Newport News #714
0	<b>Richmond #711</b>

Description

Specifications

Name	Mitsubishi MXZ-2C20NA2-U1 - M-Series Multi-Zone Outdoor Heat Pump Unit, 20K BTU, R410A, 208-230/1/60
Gemaire Item Number	MXZ2C20NA2U1
Manufacturer Product Number	MXZ-2C20NA2-U1
SKU - PIM Number	6461263476817593
ERP Number	374085
Unit of Measure	EA
Weight	126.0 Pounds (Lb)
Length	13.0 Inches (In)
Width	33.1 Inches (In)
Height	27.9 Inches (In)
Country of Origin	JPN
Brand	Mitsubishi
Tonnage	1.5
SEER	20
EER	10-12.7
Refrigerant	R-410a
CFM	1342-1458
Cooling Capacity	5700-20000
Heating Capacity	7400-25000
Voltage	208-230 VAC
Phase	Single
Cycle/Hertz	60 Hz
Circuit Breaker - Max Amps	20
Rated Load Amps	10.7
Suction Line Fitting	Flare
Suction Line Size (OD)	3/8"
Liquid Line Fitting	Flare
Liquid Line Size (OD)	1/4"
Multi Zone	Yes

<b>Color</b>	White
<b>Inverter</b>	Yes
<b>Warranty Offered</b>	Yes
<b>Energy Star Rated</b>	Yes
<b>UL Listed</b>	No
<b>Product Family</b>	MXZ
<b>Equipment Type</b>	Heat Pump
<b>Number of HVAC Zones</b>	2
<b>GEM - Case Quantity</b>	

Matched Systems

Job Name:

System Reference:

Date:



### GENERAL FEATURES

- Ceiling-recessed cassette (24"x24") ductless heat pump
- Install SLZ in a drywalled ceiling (with an access panel for servicing) or in a 2'x2' drop ceiling
- Wide airflow pattern for excellent air distribution
- Fresh air intake provided in the main body
- Built-in drain condensate lift mechanism (lifts to 33")
- Multiple control options available:
  - kumo cloud® smart device app for remote access
  - Third-party interface options
  - Wired or wireless controllers
- Long-life air filter included
- Individual vane control



## SPECIFICATIONS: SLZ-KF09NA

Cooling Capacity <sup>1, 3</sup>		Btu/h	9,000
Heating Capacity <sup>2, 3</sup>		Btu/h	11,000
Electrical	Voltage, Phase, Frequency		208/230V, 1 phase, 60Hz
	Guaranteed Voltage Range	V AC	187-253
	Voltage: Indoor - Outdoor, S1-S2	V AC	208/230
	Voltage: Indoor - Outdoor, S2-S3	V DC	24
	Voltage: Indoor - Remote controller	V DC	12
MCA		A	0.25
Fan Motor Full Load Amperage		A	0.20
Fan Motor Output		W	50
Airflow Rate at Cooling, Dry		CFM	300-265-230
Airflow Rate at Cooling, Wet		CFM	270-239-207
Airflow Rate at Heating, Dry		CFM	335-265-230
Sound Pressure Level (Cooling) <sup>1</sup>		dB(A)	31-28-25
Sound Pressure Level (Heating) <sup>2</sup>		dB(A)	31-28-25
External Static Pressure		in.WG	N/A
Drain Pipe Size		In. (mm)	1 1/4 (32)
Condensate Lift Mechanism, Maximum Distance		In. (mm)	33 (850)
Heat Exchanger Type		Plate fin coil	
External Finish Color		Munsell 1.0Y 9.2/0.2	
Unit Dimensions	W: In. (mm)		22-7/16 (570)
	D: In. (mm)		22-7/16 (570)
	H: In. (mm)		9-21/32 (245)
Package Unit Dimensions	W: In. (mm)		24-13/32 (620)
	D: In. (mm)		27-15/16 (710)
	H: In. (mm)		9-7/16 (240)
Unit Weight		Lbs. (kg)	31 (13.9)
Package Unit Weight		Lbs. (kg)	37 (17)
Refrigerant	Type		R410A
	Charge	Lbs, oz	2, 5
Piping	Gas Pipe Size O.D. (Flared)	In.(mm)	3/8 (9.52)
	Liquid Pipe Size O.D. (Flared)	In.(mm)	1/4 (6.35)

**Notes:**

Nominal Conditions	<sup>1</sup> Cooling (Indoor // Outdoor)	°F	80 DB, 67 WB // 95 DB, 75 WB
	<sup>2</sup> Heating at 47°F (Indoor // Outdoor)	°F	70 DB, 60 WB // 47 DB, 43 WB

<sup>3</sup>Capacity varies based on the number of indoor units operating and the model of the Multi-zone Outdoor Unit. For reference to connected capacity charts, please refer Multi-zone Outdoor Unit Operational Performance.




## ACCESSORIES: SLZ-KF09NA

Wireless Signal Receiver	□ PAR-FA32MA-W
Wireless Signal Receiver	□ PAR-FA32MA-E
Wireless Remote Receiver Panel	□ PAR-SF9FA-E
Wireless Remote Controller	□ PAR-SL100A-E
Backlit, Wall-mounted, Wireless Controller	□ MHK1
Portable Central Controller	□ MCCH1
Wired MA Controller	□ PAR-33MAA
Simple MA Controller	□ PAC-YT53CRAU
Touch MA Controller	□ PAR-CT01MAU-SB
Wired Remote Sensor	□ PAC-SE41TS-E
Wireless Temperature and Humidity Sensor	□ PAC-USWHS003-TH-1
Outside Air Sensor for MHK1	□ MOS1
Flush Mount Remote Temperature Sensor	□ PAC-USSEN001-FM-1
System Control Interface	□ MAC-333IF-E
Wireless Interface	□ PAC-USWHS002-WF-1
Thermostat Interface	□ PAC-US444CN-1
kumo station®	□ PAC-WHS01HC-E
USNAP Interface	□ PAC-WHS01UP-E
IT Extender	□ PAC-WHS01IE-E
BACnet® and MODBUS® Interface	□ PAC-UKPRC001-CN-1
External Fan / Heater Control Relay Adapter	□ CN24RELAY-KIT-CM3
Wire for Remote on/off with CN32 connector	□ PAC-715AD
Connector and wire for Operation status/error using CN51	□ PAC-725AD
Connector cable for remote display	□ PAC-SA88HA-EP
Connector for CN32 (remote on/off)	□ PAC-SE55RA-E
Remote Operation Adapter <sup>1</sup>	□ PAC-SF40RM-E
Grille (required)	□ SLP-18FAU
3D i-see Sensor™ Corner Panel	□ PAC-SF1ME-E
Grille with 3D i-see Sensor™	□ SLP-18FAEU
Blue Diamond Sensor Extension Cable — 15 Ft.	□ C13-103
Blue Diamond Alarm Extension Cable — 6.5 Ft.	□ C13-192
Blue Diamond MultiTank — collection tank for use with multiple pumps	□ C21-014
Blue Diamond Rubber Foot Pads	□ F10-010
Mini Condensate Pump — 230 volt application	□ SI30-230
MegaBlue Advanced Blue Diamond Condensate Pump w/ Reservoir & Sensor	□ X87-835 - 110 to 250V
Advanced Blue Diamond Mini Condensate Pump w/ Reservoir & Sensor (208/230V) [recommended]	□ X87-721 - 208/230V
Drain Pan Level Sensor	□ DPLS2
(30A/600V/UL) [fits 2" X 4" utility box] - Black	□ TAZ-MS303
(30A/600V/UL) [fits 2" X 4" utility box] - White	□ TAZ-MS303W


<sup>1</sup> Unable to use with wireless remote controller

# DIMENSIONS: SLZ-KF09NA

Unit: inch (mm)

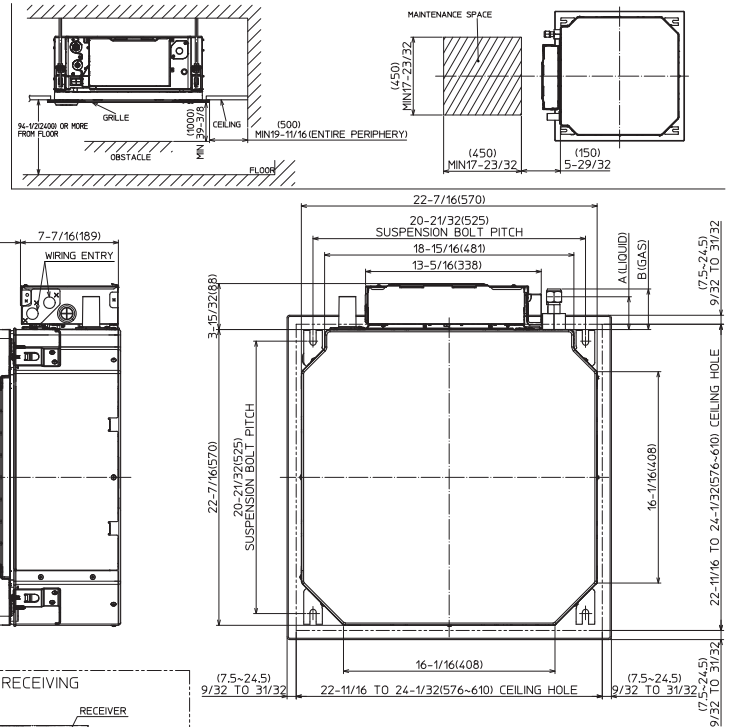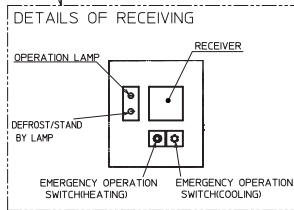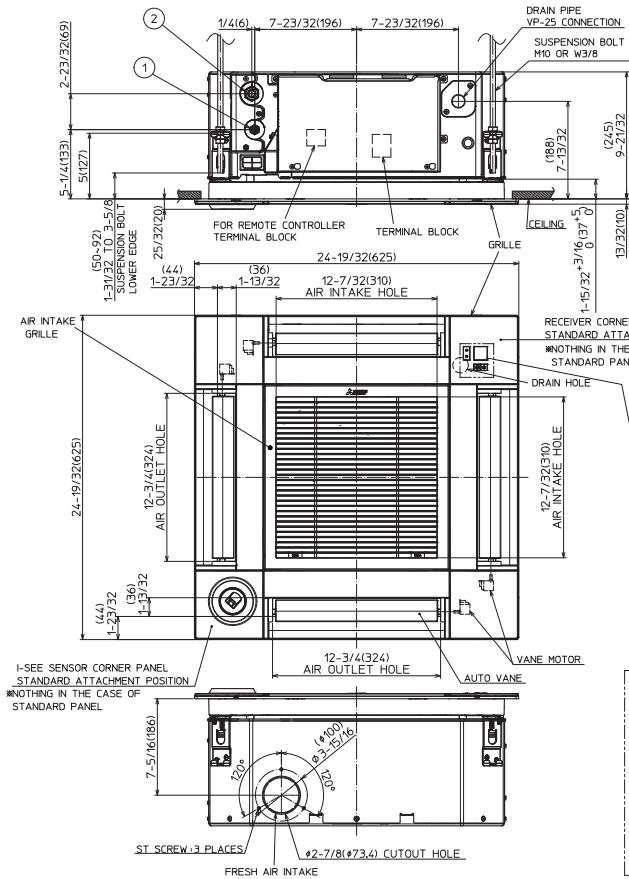

MODELS	Ø REFRIGERANT PIPE (LIQUID)	Ø REFRIGERANT PIPE (GAS)	A	B
SLZ-KF09/12NA.TH	#1/4(φ6.35mm) FLARED CONNECTION 1/4F	#3/8(φ9.52mm) FLARED CONNECTION 3/8F	(63mm) 2-15/32	(72mm) 2-27/32
SLZ-KF15/18NA.TH	#1/4(φ6.35mm) FLARED CONNECTION 1/4F	1/2(φ12.7mm) FLARED CONNECTION 1/2F	(63mm) 2-15/32	(78mm) 3-1/16

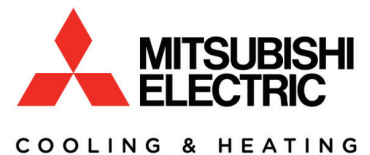

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FORM# SLZ-KF09NA FOR MULTI-ZONE HEAT PUMP SYSTEMS - 201901

Specifications are subject to change without notice.

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