MONTGOMERY COUNTY HISTORIC PRESERVATION COMMISSION STAFF REPORT

Address: 24 W. Kirke St., Chevy Chase Meeting Date: 9/11/2019

Resource: Contributing Resource **Report Date:** 9/4/2019

Chevy Chase Village Historic District

Applicant: John & Marilyn Montgomery **Public Notice:** 8/28/2019

Jordan Day, Architect

Review: HAWP **Tax Credit:** N/A

Case Number: 35/13-19LL Staff: Dan Bruechert

Proposal: Rear Porch Enclosure

STAFF RECOMMENDATION

Staff recommends that the HPC approve the HAWP application.

ARCHITECTURAL DESCRIPTION

SIGNIFICANCE: Contributing Resource within the Chevy Chase Village Historic District

STYLE: Craftsman DATE: 1913



Figure 1: 24 W. Kirke St. is near the intersection of W. Kirke St. and Magnolia Pkwy.

PROPOSAL

The applicant proposes to enclose the non-historic rear porch using materials and a design that matches the 2013 rear addition.

APPLICABLE GUIDELINES

When reviewing alterations and new construction within the Chevy Chase Village Historic District several documents are to be utilized as guidelines to assist the Commission in developing their decision. These documents include the historic preservation review guidelines in the approved and adopted amendment for the Chevy Chase Village Historic District (*Guidelines*), *Montgomery County Code Chapter 24A* (*Chapter 24A*), and the *Secretary of the Interior's Standards for Rehabilitation (Standards)*. The pertinent information in these documents is outlined below.

Chevy Chase Village Historic District Guidelines

The *Guidelines* break down specific projects into three levels of review - Lenient, Moderate and Strict Scrutiny.

"Lenient Scrutiny" means that the emphasis of the review should be on issues of general massing and scale, and compatibility with the surrounding streetscape, and should allow for a very liberal interpretation of preservation rules. Most changes should be permitted unless there are major problems with massing, scale or compatibility.

"Moderate Scrutiny" involves a higher standard of review than "lenient scrutiny." Besides issues of massing, scale and compatibility, preserving the integrity of the resource is taken into account. Alterations should be designed so that the altered structure still contributes to the district. Use of compatible new materials, rather than the original building materials, should be permitted. Planned changes should be compatible with the structure's existing design, but should not be required to replicate its architectural style.

"Strict Scrutiny" means that the planned changes should be reviewed to insure that the integrity of the significant exterior architectural or landscaping features and details is not compromised. However, strict scrutiny should not be "strict in theory but fatal in fact" i.e. it does not mean that there can be no changes but simply that the proposed changes should be reviewed with extra care.

HAWP applications for exterior alterations, changes, and/or additions to non-contributing/out-of-period resources should receive the most lenient level of review. Most alterations and additions should be approved as a matter of course. The only exceptions would be major additions and alterations to the scale and massing of the structure, which affect the surrounding streetscape and/or landscape and could impair the character of the district as a whole.

- o <u>Doors</u> should be subject to moderate scrutiny if they are visible from the public right-of-way, lenient scrutiny if they are not.
- <u>Exterior trim</u> (such as moldings on doors and windows) on contributing resources should be subject to moderate scrutiny if it is visible from the public right-of-way, lenient scrutiny if it is not. Exterior trim on Outstanding resources should be subject to strict scrutiny if it is visible from the public right-of-way.
- o <u>Lot coverage</u> should be subject to strict scrutiny, in view of the critical importance of preserving the Village's open park-like character.
- o <u>Porches</u> should be subject to moderate scrutiny if they are visible from the public right-ofway, lenient scrutiny if they are not. Enclosures of existing side and rear porches have

- occurred throughout the Village with little or no adverse impact on its character, and they should be permitted where compatibly designed.
- o <u>Siding</u> should be subject to moderate scrutiny if it is visible from the public right-of-way, lenient scrutiny if it is not.
- O <u>Windows</u> (including window replacement) should be subject to moderate scrutiny if they are visible from the public right-of-way, lenient scrutiny if they are not. Addition of compatible exterior storm windows should be encouraged, whether visible from the public-right-of-way or not. Vinyl and aluminum windows (other than storm windows) should be discouraged.

The *Guidelines* state five basic policies that should be adhered to, including:

- Preserving the integrity of the Chevy Chase Village Historic District. Any alterations should, at a minimum, perpetuate the ability to perceive the sense of time and place portrayed by the district.
- o Preserving the integrity of contributing structures. Alterations to should be designed in such a way that the altered structure still contributes to the district.
- o Maintaining the variety of architectural styles and the tradition of architectural excellence.
- O Design review emphasis should be restricted to changes that will be visible from the front or side public right-of-way, or that would be visible in the absence of vegetation or landscaping.
- Alterations to the portion of a property that are not visible from the public-right-of-way should be subject to a very lenient review. Most changes to the rear of the properties should be approved as a matter of course.

Montgomery County Code; Chapter 24A-8

- (b) The commission shall instruct the director to issue a permit, or issue a permit subject to such conditions as are found to be necessary to insure conformity with the purposes and requirements of this chapter, if it finds that:
 - (1) The proposal will not substantially alter the exterior features of an historic site or historic resource within an historic district; or
 - (2) The proposal is compatible in character and nature with the historical, archeological, architectural or cultural features of the historic site or the historic district in which an historic resource is located and would not be detrimental thereto or to the achievement of the purposes of this chapter;

Secretary of the Interior's Standards for Rehabilitation

- 2. The historic character of a property will be retained and preserved. The removal of distinctive materials or alteration of features, space and spatial relationships that characterize a property will be avoided.
- 9. New additions, exterior alterations, or related new construction will not destroy historic materials, features, and spatial relationships that characterize the property. The new work shall be differentiated from the old and will be compatible with the historic materials, features, size, scale and proportions, and massing to protect the integrity of the property and its environment.
- 10. New additions and adjacent or related new construction will be undertaken in such a manner that, if removed in the future, the essential form and integrity of the historic property and its environment would be unimpaired.

STAFF DISCUSSION

The applicant proposes enclosing the rear porch constructed off of the non-historic rear addition (approved by the HPC and constructed in 2013). Staff finds that the proposal complies with the *Guidelines*, *Chapter 24A*, and the *Standards* and recommends approval of this HAWP.

The proposed rear porch enclosure will maintain the existing support posts and roofing. The walls will be covered with wood shingles that match the exterior of the addition. The windows and doors will match the Andersen 400 series windows approved and installed in 2013. Staff finds that due to the orientation of the house and placement of the addition, confirmed by a site visit, the existing porch is not visible from the public right-of-way.

The *Guidelines* state that a compatibly designed porch enclosure should be approved as a matter of course; Staff finds the porch details are compatible with the historic house and its addition. Additionally, the *Guidelines* state that rear porch enclosures are to be reviewed under lenient scrutiny when they cannot be seen from the public right-of-way. Staff finds the siding, windows, doors, and roofing proposed for the enclosure are all consistent with the approval for the 2013 addition; and are *less* visible from the public right-of-way than the addition (per Standard 2 and 24A-8(b)(2)). Finally, the porch enclosure will not destroy any historic fabric and could be removed without any impact on the character of the building in the future, per Standards 9 and 10 and 24A-8(b)(2).

STAFF RECOMMENDATION

Staff recommends that the Commission <u>approve</u> the HAWP application under the Criteria for Issuance in *Chapter 24A-8(b)(1) and (2)*, having found that the proposal will not substantially alter the exterior features of the historic resource and is compatible in character with the district, the *Chevy Chase Village Historic District Design Guidelines*, and the purposes of *Chapter 24A*; and with the *Secretary of the Interior's Standards for Rehabilitation #2, #9, and #10*,

and with the general condition that the applicant shall present the **3 permit sets of drawings**, **if applicable**, **to Historic Preservation Commission (HPC) staff for review and stamping** prior to submission for the Montgomery County Department of Permitting Services (DPS) building permits;

and with the general condition that final project design details, not specifically delineated by the Commission, shall be approved by HPC staff or brought back to the Commission as a revised HAWP application at staff's discretion;

and with the general condition that the applicant shall notify the Historic Preservation Staff if they propose to make **any alterations** to the approved plans. Once the work is completed the applicant will contact the staff person assigned to this application at 301-563-3400 or dan.bruechert@montgomeryplanning.org to schedule a follow-up site visit.

#885574





DP8 -#

HISTORIC PRESERVATION COMMISSION 301/563-3400

APPLICATION FOR HISTORIC AREA WORK PERMIT

Contact mail: Team @ [lack	Contact Person: Jordan Day
	in (RLArchs.	Deytime Phone No.: 301-320-0107
Tex Account No.: 09457280	,	
Name of Property Owner: John an	Marilm Montaumer	70 Daystime Phone No.: 301 - 312 - 6463
Address: 24 West Kir	rest Chery Cl	hase MD 20815
	ŕ	1000
		Phone No.:
Agent for Owner:		Daytime Phone No.:
C. MON OF BUILDING PREMISE		
House Number: 24 West	Cirtie st smer	
Towarciny: Chery Chase	Nearest Cross Street: A	Magnolia Parkway
tot: P13 Block: 32	Subdivision:	
Liber: Folia:	Percel:	
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1A CHECK ALL APPLICABLE	CHECK ALL AP	,
_	Renovate A/C ():	ALL CONTRACTOR CONTRAC
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		(complete Section 4)
18 Construction cost estimate: \$ 20		
1C. If this is a revision of a previously appro	red active permit, see Permit #	
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28. Type of water supply: 61 A	WSSC 02 13 West	93 🗆 Other;
PANTALES CONTRACTOR VEGE	WEST WINE WATE	
	rchez	
38. Indicate whether the fence or retaining		
On party line/property line		
- verteard was bathful at 1000		☐ On public right of way/nesement
I hereby certify that I have the authority to n approved by all agencies fisted and I hereby	ake the foregoing application, that the application	cation is correct, and that the construction will comply with plans
	accommission and accommiss to be a contri	Man 18F the Issuance of this permit.
/ techanol 1	1. ggm.	816/19
Signature of owner or au	hanzed egent	Date
	<u> </u>	
Approved:	For Chairperson	n, Historic Preservation Commission
Disapproved: Sk	AMURE:	Date:
Application/Permit No.:	Date Filed	7119 Date Issued:
Edit 6/21/99	SEE REVEASE SIDE FOR IN	STRUCTIONS

WRITTEN DESCRIPTION OF PROJECT

Description of existing structure(s) and environmental setting, including their historical features and significance.

The existing structure is a two-story traditional house, built in 1913, with an addition to the rear built in 2013. The house is a representative example of houses built in streetcar suburbs at the beginning of the 20th century.

General description of project and its effect on the historical resource(s), the environmental setting, and where applicable, the historic district.

The project encloses an existing screened porch at the rear of an addition from 2013 already approved by DPS. Because the addition is contained entirely on the screened porch's existing slab, it will have a minimal impact on its environmental setting. The renovated area is located on the rear façade of the house, in an area not visible from the street. New clapboard siding, historic-style trim, and traditional double-hung windows will match the existing elements of the resource. Due to these factors, and the project's minimal disruption of the site, the project will have a negligible impact on the historic resource and district.

HAWP APPLICATION: MAILING ADDRESSES FOR NOTIFING [Owner, Owner's Agent, Adjacent and Confronting Property Owners]


Owner's mailing address John and Marilyn Montgamery 24 West Kirke Street chevy Chase, MD, 20815	Owner's Agent's mailing address
Adjacent and confrontin	g Property Owners mailing addresses
Donna and Francisco Arbide	West Kirke Street Trust
28 West Kirke Street Chevy Chase, MD, 20815	20 West Kirke Street Cherr Chase, MD, 20815
Elizabeth and thomas Brown	Bryan and Kathleen Anderson
27 west Kirke Street	29 West Kirtre street
thery Chase, MD, 20815	ChevyChase, MD, 20815
baron and Charlotte Kramer	Brenden and Margaret Bookington
27 W. Irving Street Chevy chase, MD, 20815	25 W. Irving Street
chery chase, MD, 20815	CheryChase, MD, 20815



NORTH FACADE, PUBLIC ROW



WEST FACADE

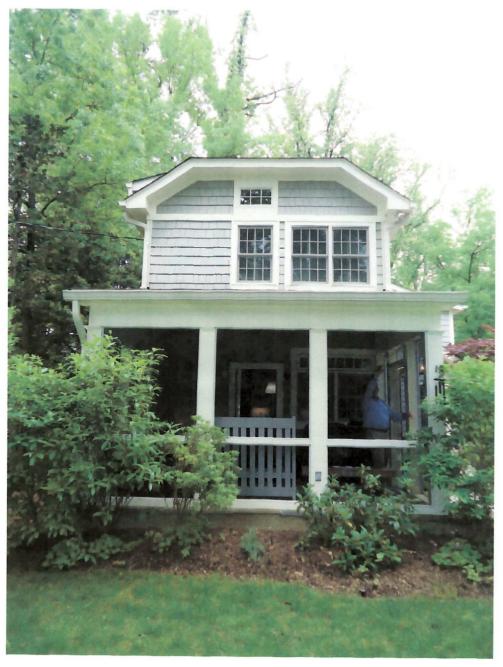

SOUTH FACADE



EAST FACADE

SYMBOLS GENERAL NOTES 02 SITE WORK 1. All construction shall be in accordance with I.R.C., One and Two Family Dwelling Code, 2015 edition, and all MONTGOMERY COUNTY additions and revisions thereto. EARTH/UNDISTURBED 2. Design Live Loads: EARTH/COMPACT FILL -Sleeping room load 30 lbs./ sq. ft. -Floor load 40 lbs./ sq ft. POROUS FILL/GRAVEL -Roof load 30 lbs./ sq. ft. -Deck load 40 lbs./ sq. ft. 03 CONCRETE -Garage load 50 lbs./ sq. ft. 3. Soil bearing to be 2000 lbs./ sq. ft. minimum, or unless otherwise specified. CAST IN PLACE Design wind load shall be 20 lbs./ sq. ft., per IRC 90 mph. Maximum height of fill above basement slab shall be seven feet (7'-0"). Bottom of all concrete footings shall be 24" minimum below finished grade. SAND/MORTAR 7. Foundation walls shall comply with I.R.C. Section R-401 through R-404. 8. Foundation drainage shall comply with I.R.C. Section R-405. 04 MASONRY Roundation dramage shall comply with I.R.C. Section R-405. Foundation waterproofing shall comply with I.R.C. Section R-406. Top of Garage slab shall be four inches (4") below adjacent finished floors Attached Garages shall comply with I.R.C. Section R-309. Concrete floors shall comply with I.R.C. Section R-506. All concrete shall be 150 lbs./ cubic ft. and conform to A.C.I. 318 specifications. BRICK CONCRETE MASONRY CONCRETE MASONRY - Concrete at porches, garages, slabs, steps and all areas exposed to weather shall be 3500 UNIT, GROUTED SOLID p.s.i., air-entrained concrete. STONE - Foundation walls, exterior walls and other vertical concrete work exposed to weather shall be 3000 p.s.i., air-entrained concrete. - All other concrete shall be 3000 p.s.i. FLAG STONE 14. All Concrete masonry units (CMU) used in basements and foundation walls shall be load-bearing units 5" RANDOM ASHLAR conforming to A.S.T.M. C 90-70 for hollow units. At all wood post and wood beam bearing locations on CMU walls, CMU cells shall be grouted solid with grout or mortar at top two courses (minimum). 15. All CMU walls shall have standard truss-type 'DUR-O-WALL' or equiv. Bed joint reinforcing, at maximum 16" 05 METAL vertical spacing. ALUMINUM 16. All brick units used in construction exposed to weather, shall conform to A.S.T.M. C 62 or A.S.T.M. C 216. 17. All mortar shall be Type 'S' and shall conform with A.S.T.M. C 270-82. BRASS/BRONZE 18. Stone and masonry veneer shall comply with I.R.C. Section R-703.7. Backfilling against basement walls shall not be performed until floor framing at top of wall is in place, and top of reinforced CMU walls are braced against overturning. Maximum allowable lateral pressure on basement walls shall be 30 p.s.f. Reinforcing steel shall be Grade '40' and conform to A.S.T.M. Spec. A-615, unless otherwise noted. STEEL 06 WOOD & PLASTIC 22. Steel post cap plates shall conform with A.S.T.M. Spec. A-36. PLYWOOD -F(y) = 36,000 p.s.i.- Bolts shall comply with A.S.T.M. A-307 (minimum) 23. Steel columns in basement shall be adjustable 3" (I.D.), S-40 columns, unless otherwise noted. FINISH 24. All structural wood framing, including roof and floor sheathing, shall be in accordance with the "National Design Specifications for Wood Construction", published by the National Forest Products Association. ROUGH BLOCKING 25. All headers shall be (3) 2x10 unless otherwise noted. 26. Provide double jack studs at each end of all headers and beams of spans greater than 5'-0", unless otherwise 07 THERMAL & MOISTURE noted. 27. Splices at the top and bottom course of a double top plate shall be staggered a minimum of 4'-0", and shall not occur at any stud interval which provides bearing for joist and/or rafter above. 28. All roof, floor and girder trusses shall be designed by the Manufacturer to carry required loads and to be installed by the Contractor / SubContractor according to the Manufacturers specifications. 29. Contractor shall provide Architect with Shop Drawings of all floor and roof designs for approval prior to ordering. 30. Provide solid blocking under all jack studs not bearing directly on joists or T.J.i. member. **PROTECTION** BATT/LOOSE FILL RIGID INSULATION 31. Where installation of plumbing, heating or other pipes necessitates cutting of top plates, a metal tie of 18 gauge (min.), 45/1000" thickness and 1-1/2" width shall be fastened to the plate with 16d nails (min.)- across and to each STRUCTURAL LVL side of the opening. 32. Double beams, double hips and double valley rafters shall be joined securely, per manufacturers RIGID VENT recommendations, to ensure the members act conjointly in resisting the applied load. (COR-A-VENT) 33. Unless specified otherwise, provide the following lintels at masonry openings: 08 DOOR & WINDOW Masonry Type Span Lintel Size Brick 3'-0" or less 3.5" x 3.5" x 1/4" GLASS 5'-0" or less 3.5" x 4.0" x 1/4" GLASS BLOCK 8'-0" or less 3.5" x 5.0" x 5/16" 9'-0" or less 3.5" x 6.0" x 5/16" 09 FINISHES Stone 3'-0" or less 6.0" x 4.0" x 5/16" Stone 5'-0" or less 6.0" x 6.0" x 5/16" ACOUSTICAL TILE Stone 8'-0" or less 6.0" x 6.0" x 3/8" Stone 9'-0" or less 6.0" x 8.0" x 7/16 STUCCO/PARGING 34. All untreated lumber shall be a minimum of 8" above finished exterior grade. CERAMIC TILE 35. All lumber in contact with concrete or CMU shall be pressure-treated lumber. 36. All prefabricated fireplace construction shall comply with I.R.C. Chapter 10, and with Figure R-1003.1. 37. Chimney / fireplace construction shall comply with I.R.C. Chapter 10 and R-1003.1. 38. Fire-stopping shall comply with I.R.C. Section R-602.8. 39. Draft-stopping shall comply with I.R.C. Section R-602.8. CARPET AND PAD HARD WOOD FLOOR 40. Radon mitigation shall comply with I.R.C. Appendix 'F'. 41. Provide interconnected smoke detectors to protect all floors, bedrooms, and basements referenced in I.R.C. TERRAZZO PŁYWOOD Section R-317. 42. Stairways shall comply with I.R.C. Section R-314. - Minimum headroom shall be 6'-8" clear to all points. - Minimum tread depth from edge of nosing to face of riser shall be 9". - Maximum riser shall be 8-1/4" per Reg. 36-01 amendments. 43. Handrails and guardrails shall comply with I.R.C. Section R-315. 44. All exits shall comply with I.R.C. Section R-311. 45. Sleeping rooms shall comply with I.R.C. Section R-310. Maximum sill height at sleeping rooms shall be 44" above finished floor. 46. All glazing shall comply with I.R.C. Section R-308. 47. All ceiling heights shall comply with I.R.C. Section R-305. 48. All exterior wall coverings shall comply with I.R.C. Section R-703. 49. All gas piping shall comply with N.F.P.A. 54.

recommended by Manufacturer.

50. Electrical wiring shall comply with the latest National Electric Code and Montgomery County requirements.

Note: Floor and Roof framing plans (including Shop Drawings as required), bearing the signature and seal of the Manufacturer, shall be furnished by the General Contractor at time of Inspection. Brace all members as

MONTGOMERY RESIDENCE



885574

PROJECT TEAM

BUILDING OWNER:

JOHN & MARILYN MONTGOMERY 24 WEST KIRKE STREET CHEVY CHASE, MD, 20815

ARCHITECT:

RICHARD LEGGIN ARCHITECTS 6500 SEVEN LOCKS RD. CABIN JOHN, MD 20818 301.320.0107 RLEGGIN@RLARCHS.COM

SCOPE OF WORK

- ENCLOSE EXISTING SCREENED PORCH, ADD DOOR/WINDOWS
- ADD CASED OPENING BETWEEN EXISTING KITCHEN AND RENOVATED ROOM


INDEX OF SHEETS

A000	COVER PAGE
A001	SITE PLAN
A002	SITE PHOTOS
A100	FIRST FLOOR EXISTING
A101	FIRST FLOOR DEMOLITION
A102	FIRST FLOOR PROPOSED
A200	EAST ELEVATION EXISTING
A201	EAST ELEVATION PROPOSED
A202	SOUTH ELEVATION EXISTING
A203	SOUTH ELEVATION PROPOSED
A204	WEST ELEVATION EXISITING
A205	WEST ELEVATION PROPOSED
A206	INTERIOR ELEVATIONS
A300	ROOM SECTION
A400	WALL SECTION
A500	DETAILS

PROFESSIONAL CERTIFICATION

I hereby certify that these documents were prepared or approved by me, and that I am duly licensed architect under laws of the State of Maryland.

License No. 7023 Expiration Date: 04/05/2020

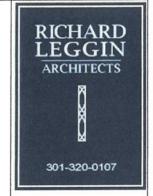

MacArthur Plaza II, Suite #210 6500 Seven Locks Road Cabin John, MD 20818

Montgomery Residence west KIRKE STREET, CHEVY CHASE, MD, 20815

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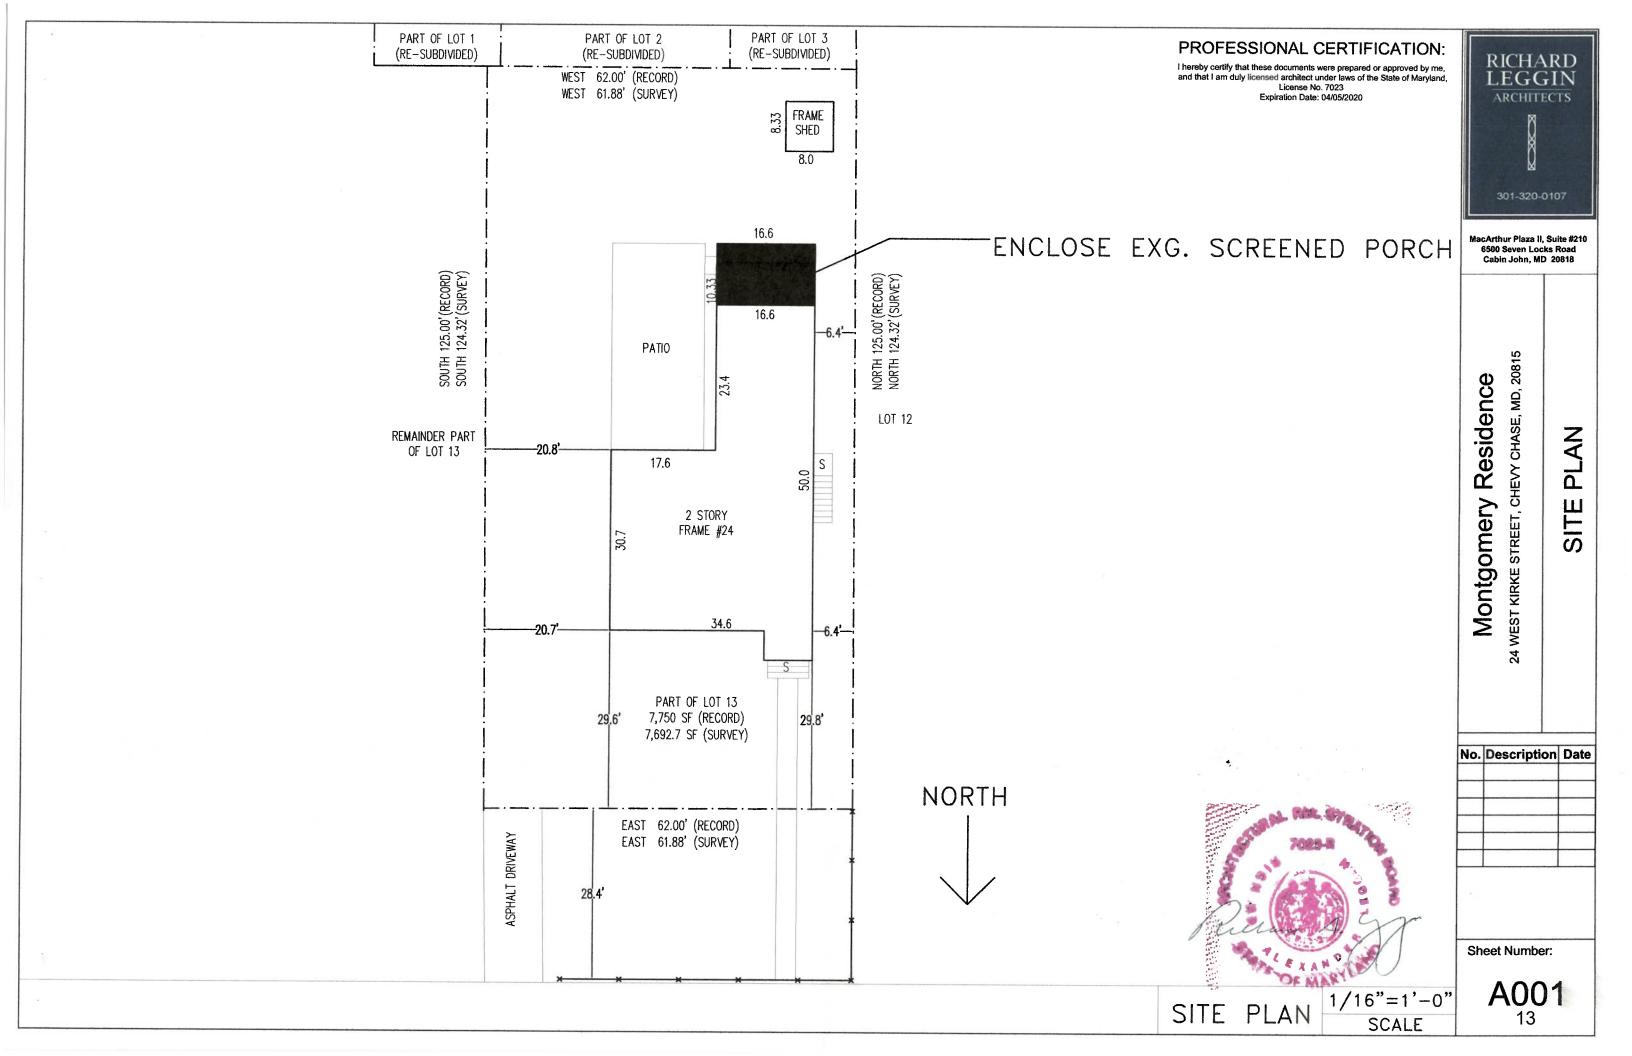
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COVE

No. Description Date

Sheet Number:



SAME PART

SOUTH FACADE


EAST FACADE



PROFESSIONAL CERTIFICATION

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License No. 7023 Expiration Date: 04/05/2020

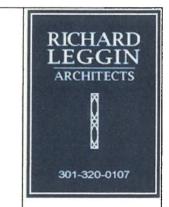

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PHOTOS

24 WEST KIRKE STREET, CHEVY CHASE, MD, 20815 Montgomery Residence

No. Description Date

Sheet Number:

A002


WEST FACADE






NORTH FACADE, FROM PUBLIC ROW



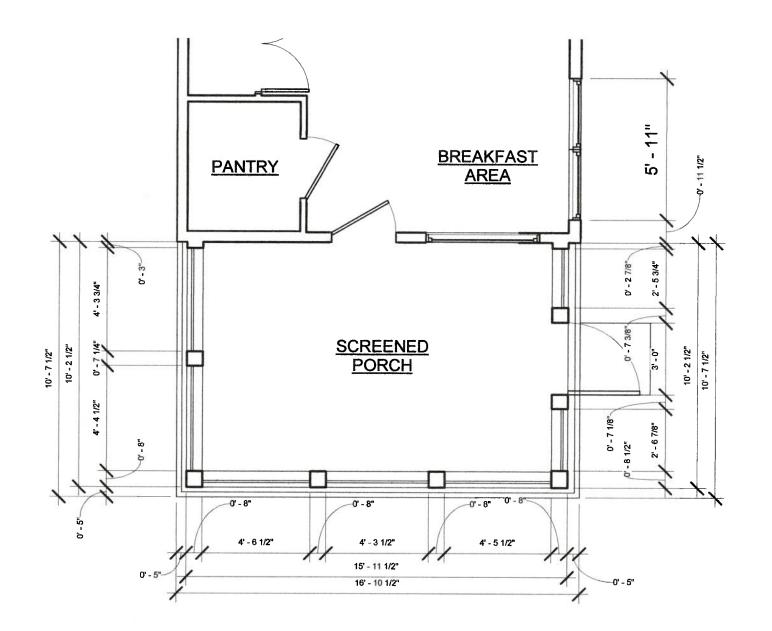



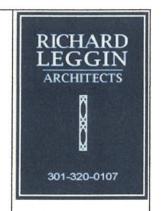


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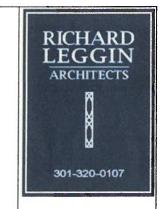
24 WEST KIRKE STREET, CHEVY CHASE, MD, 20815 FIRST FLOOR EXISTING

Montgomery Residence

No. Description Date

Sheet Number:



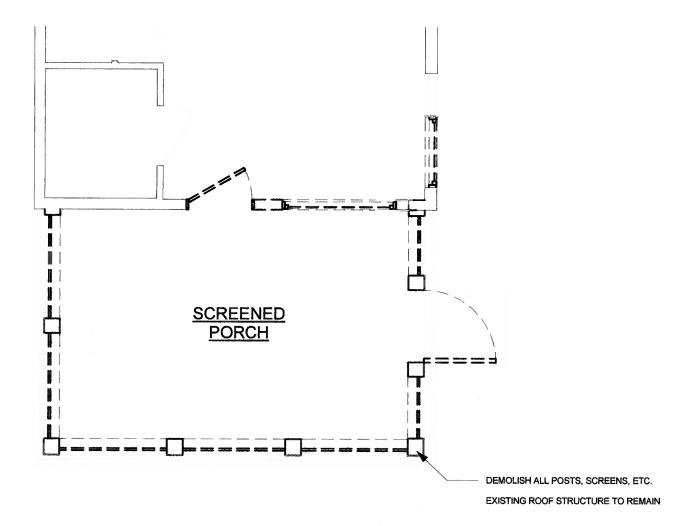

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Montgomery Residence 24 WEST KIRKE STREET, CHEVY CHASE, MD, 20815 FLOOR DEMOLITION

FIRST

No. Description Date


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A101

FIRST FLOOR DEMOLITION

D"

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WEST KIRKE STREET, CHEVY CHASE, MD, 20815 Montgomery Residence


PLAN

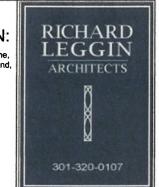FLOOR

No. Description Date


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A102

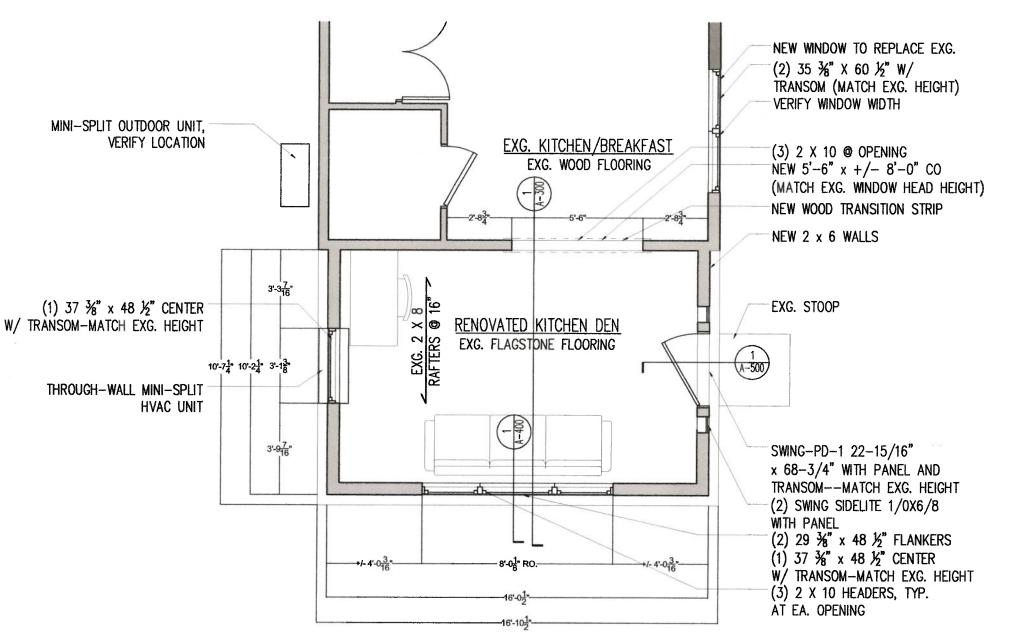

NOTE: SUBMIT WINDOW ORDER TO ARCHITECT BEFORE PLACING ORDER

PROFESSIONAL CERTIFICATION: I hereby certify that these documents were prepared or approved by me, and that I am duly licensed architect under laws of the State of Maryland, License No. 7023 Expiration Date: 04/05/2020 Montgomery Residence 1/4"=1'-0" WEST ELEVATION EXISTING **SCALE**

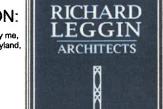

MacArthur Plaza II, Suite #210 6500 Seven Locks Road Cabin John, MD 20818

301-320-0107

Capill Collin, IND 20010

24 WEST KIRKE STREET, CHEVY CHASE, MD, 20815
ELEVATION


No. Description Date

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Sheet Number:

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Expiration Date: 04/05/2020



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ELEVATION

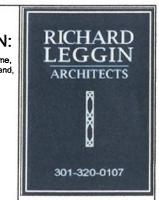24 WEST KIRKE STREET, CHEVY CHASE, MD, 20815 Montgomery Residence

No. Description Date

Sheet Number:

A201

EXG. ADDITION RENOVATED MATCH EXG. SIDING


MINI-SPLIT HVAC UNIT

(1) 37 3/8" x 48 1/2" CENTER W/ TRANSOM-MATCH EXG. HEIGHT

WEST ELEVATION PROPOSED 1/4"=1'-0"
SCALE

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ELEVATION

24 WEST KIRKE STREET, CHEVY CHASE, MD, 20815 Montgomery Residence

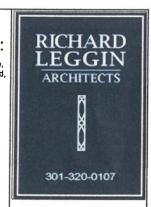No. Description Date

Sheet Number:

SCALE


A202 20



SOUTH ELEVATION EXISTING

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Expiration Date: 04/05/2020

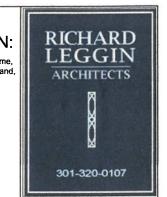

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ELEVATION

24 WEST KIRKE STREET, CHEVY CHASE, MD, 20815

Montgomery Residence

No. Description Date

(2) 29 ¾" x 48 ½" FLANKERS (1) 37 ¾" x 48 ½" CENTER W/ TRANSOM-MATCH EXG. HEIGHT

MATCH EXG. SIDING

9'-9" 8'-11"

6'-9"

Sheet Number: A203

1/4"=1'-0"

SCALE

SOUTH ELEVATION PROPOSED

PROFESSIONAL CERTIFICATION: I hereby certify that these documents were prepared or approved by me, and that I am duly licensed architect under laws of the State of Maryland, License No. 7023 Expiration Date: 04/05/2020



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24 WEST KIRKE STREET, CHEVY CHASE, MD, 20815 Montgomery Residence

ELEVATION


No. Description Date

Sheet Number:

SCALE

I hereby certify that these documents were prepared or approved by me, and that I am duly licensed architect under laws of the State of Maryland, License No. 7023

Expiration Date: 04/05/2020

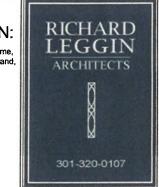

MacArthur Plaza II, Suite #210 6500 Seven Locks Road Cabin John, MD 20818

24 WEST KIRKE STREET, CHEVY CHASE, MD, 20815

ELEVATION

Montgomery Residence

No. Description Date

Sheet Number:

A205

1/4"=1'-0"


SCALE



(2) 35 ¾" X 60 ½" W/ TRANSOM (MATCH EXG. HEIGHT)


NOTE: SUBMIT WINDOW ORDER TO ARCHITECT BEFORE PLACING ORDER

EAST ELEVATION PROPOSED

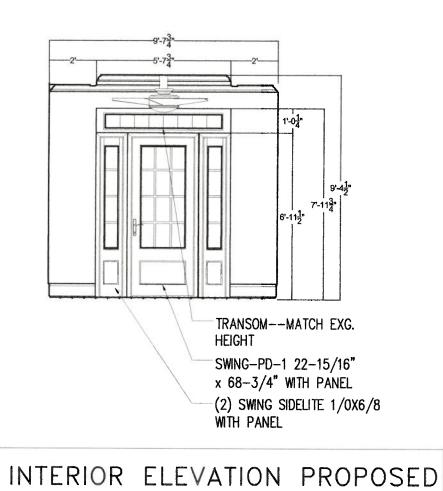

and that I am duly licensed architect under laws of the State of Maryland,
License No. 7023

Expiration Date: 04/05/2020

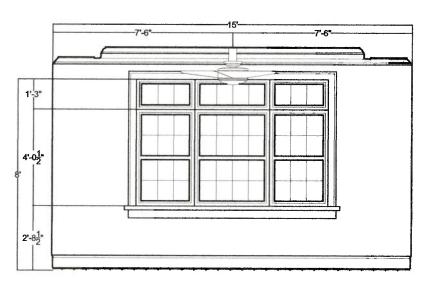

RICHARD ARCHITECTS 301-320-0107

MacArthur Plaza II, Suite #210

6500 Seven Locks Road Cabin John, MD 20818

WEST KIRKE STREET, CHEVY CHASE, MD, 20815 Montgomery Residence

ELEVATION


INTERIOR ELEVATION PROPOSED

1/4"=1'-0"

SCALE

1/4"=1'-0"

SCALE

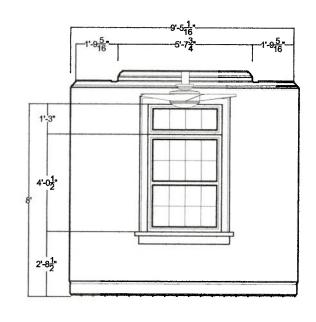

No. Description Date

Sheet Number:


A206

INTERIOR ELEVATION PROPOSED 1/4"=1'-0"

1/4"=1'-0"

SCALE

INTERIOR ELEVATION PROPOSED

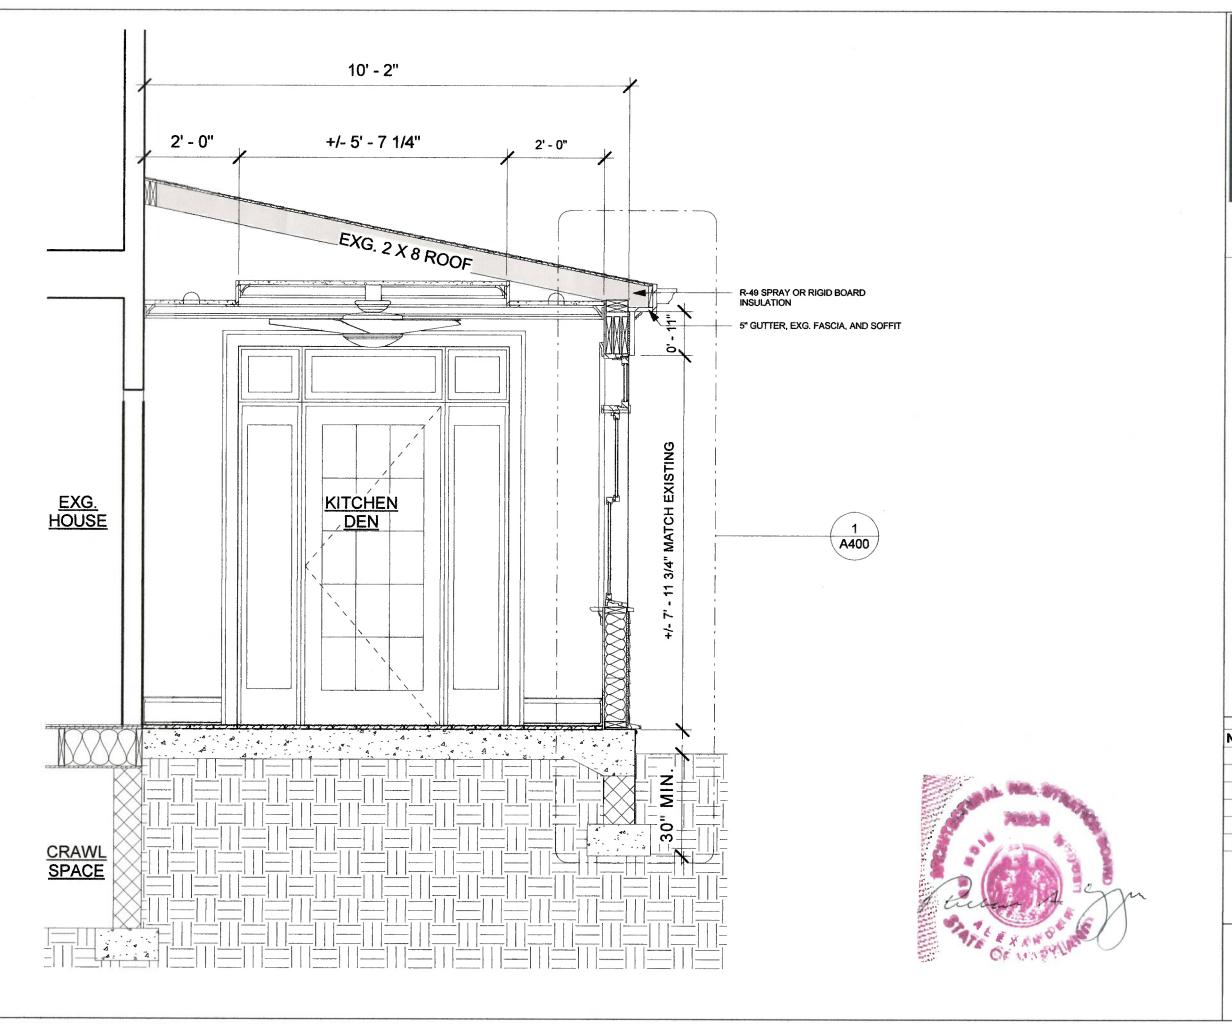

RICHARD LEGGIN ARCHITECTS 301-320-0107


MacArthur Plaza II, Suite #210 6500 Seven Locks Road Cabin John, MD 20818


24 WEST KIRKE STREET, CHEVY CHASE, MD, 20815 ROOM SECTION

Montgomery Residence

No. Description Date

Sheet Number:

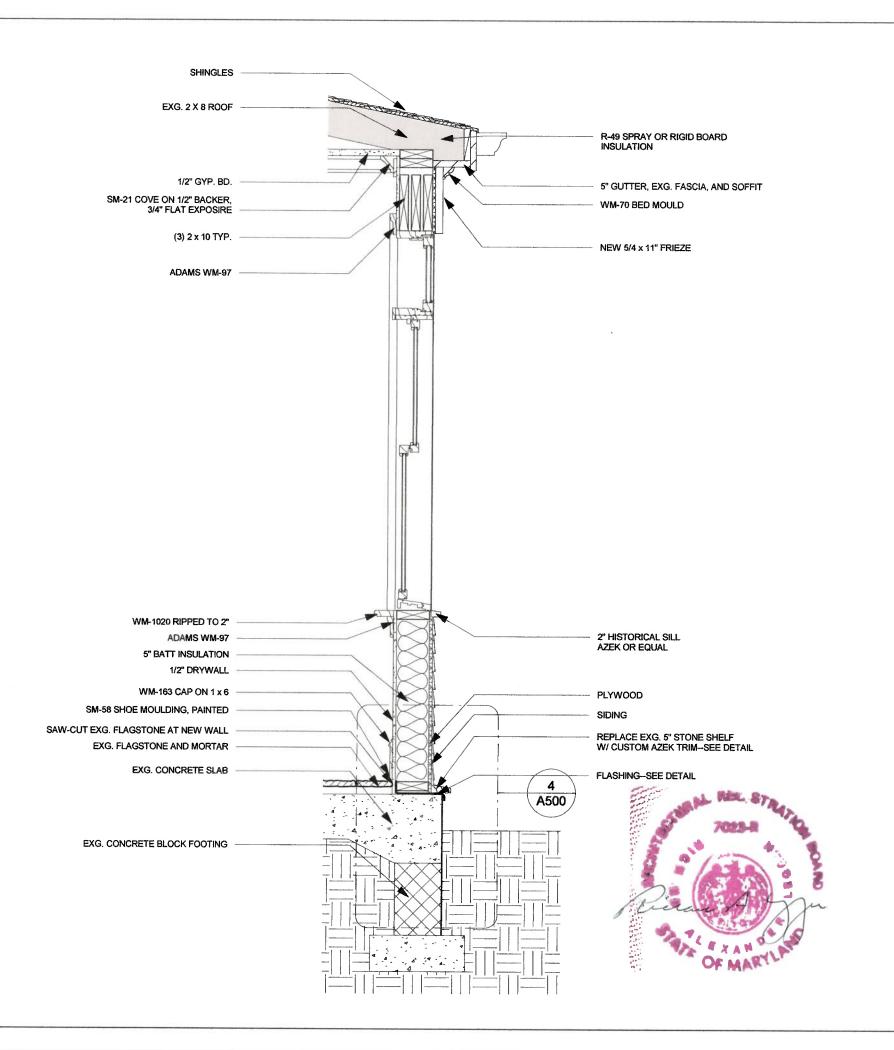

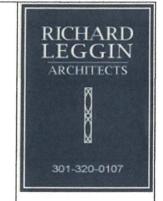

MacArthur Plaza II, Suite #210 6500 Seven Locks Road Cabin John, MD 20818

Montgomery Residence 24 WEST KIRKE STREET, CHEVY CHASE, MD, 20815

SECTION

WALL

No. Description Date

Sheet Number:

