Preliminary Consultation MONTGOMERY COUNTY HISTORIC PRESERVATION COMMISSION STAFF REPORT

Address: 13 East Melrose St., Chevy Chase Meeting Date: 3/27/2019

Resource: Contributing Resource Report Date: 3/20/2019

Chevy Chase Village Historic District

Applicant: Thomas O'Donnell and Caroline Fawcett **Public Notice:** 3/13/2019

(Vince Greene, Architect)

Review: Preliminary Consultation **Tax Credit:** N/A

Case Number: N/A Staff: Michael Kyne

PROPOSAL: Partial demolition and construction of a new rear addition; driveway replacement.

STAFF RECOMMENDATION:

Staff recommends that the applicants make any revisions based upon the HPC's comments and return for a second preliminary consultation.

ARCHITECTURAL DESCRIPTION

SIGNIFICANCE: Contributing Resource

STYLE: Dutch Colonial DATE: c. 1892-1916



Fig. 1: Subject property.

PROPOSAL:

The applicants propose the following work items at the subject property:

- Partial demolition of existing rear additions.
- Construction of a new rear two-story addition.
- Replacement of the existing aggregate concrete driveway with an interlocking concrete paver driveway in the same footprint.

APPLICABLE GUIDELINES:

When reviewing alterations and new construction within the Chevy Chase Village Historic District several documents are to be utilized as guidelines to assist the Commission in developing their decision. These documents include the historic preservation review guidelines in the approved and adopted amendment for the *Chevy Chase Village Historic District (Guidelines), Montgomery County Code Chapter 24A (Chapter 24A)*, and *the Secretary of the Interior's Standards for Rehabilitation (Standards)*. The pertinent information in these documents is outlined below.

Sec. 24A-8. Same-Criteria for issuance.

- (a) The commission shall instruct the director to deny a permit if it finds, based on the evidence and information presented to or before the commission that the alteration for which the permit is sought would be inappropriate, inconsistent with or detrimental to the preservation, enhancement or ultimate protection of the historic site or historic resource within an historic district, and to the purposes of this chapter.
- (b) The commission shall instruct the director to issue a permit, or issue a permit subject to such conditions as are found to be necessary to insure conformity with the purposes and requirements of this chapter, if it finds that:
 - (1) The proposal will not substantially alter the exterior features of an historic site or historic resource within an historic district; or
 - (2) The proposal is compatible in character and nature with the historical, archeological, architectural or cultural features of the historic site or the historic district in which an historic resource is located and would not be detrimental thereto or to the achievement of the purposes of this chapter; or
 - (3) The proposal would enhance or aid in the protection, preservation and public or private utilization of the historic site or historic resource located within an historic district in a manner compatible with the historical, archeological, architectural or cultural value of the historic site or historic district in which an historic resource is located: or
 - (4) The proposal is necessary in order that unsafe conditions or health hazards be remedied; or
 - (5) The proposal is necessary in order that the owner of the subject property not be deprived of reasonable use of the property or suffer undue hardship; [emphasis added] or
 - (6) In balancing the interests of the public in preserving the historic site or historic resource located within an historic district, with the interests of the public from the use and benefit of the alternative proposal, the general public welfare is better served by granting the permit.
- (c) It is not the intent of this chapter to limit new construction, alteration or repairs to any 1 period or architectural style.
- (d) In the case of an application for work on an historic resource located within an historic district, the commission shall be lenient in its judgment of plans for structures of little historical or design significance or for plans involving new construction, unless such plans would seriously impair the historic or architectural value of surrounding historic resources or would impair the character of the historic district. (*Ord. No. 9-4, § 1; Ord. No. 11-59.*)

Chevy Chase Historic District Guidelines

The guidelines break down specific projects into three levels of review – Lenient, Moderate and Strict Scrutiny.

"Lenient Scrutiny" means that the emphasis of the review should be on issues of general massing and scale, and compatibility with the surrounding streetscape, and should allow for a very liberal interpretation of preservation rules. Most changes should be permitted unless there are major problems with massing, scale and compatibility.

"Moderate Scrutiny" involves a higher standard of review than "lenient scrutiny." Besides issues of massing, scale and compatibility, preserving the integrity of the resource is taken into account. Alterations should be designed so that the altered structure still contributes to the district. Use of compatible new materials, rather than the original building materials, should be permitted. Planned changes should be compatible with the structure's existing design, but should not be required to replicate its architectural style.

"Strict Scrutiny" means that the planned changes should be reviewed to insure that the integrity of the significant exterior architectural or landscaping features and details is not compromised. However, strict scrutiny should not be "strict in theory but fatal in fact" i.e. it does not mean that there can be no changes but simply that the proposed changes should be reviewed with extra care.

The *Guidelines* state three basic policies that should be adhered to, including:

- Preserving the integrity of the contributing structures in the district. Alterations to contributing structures should be designed in such a way that the altered structure still contributes to the district.
- Design review emphasis should be restricted to changes that will be visible from the front or side public right-of-way, or that would be visible in the absence of vegetation or landscaping.
- Alterations to the portion of a property that are not visible from the public right-of-way should be subject to very lenient review. Most changes to rear of the properties should be approved as a matter of course.

The Guidelines that pertain to this project are as follows:

<u>Major additions</u> should, where feasible, be placed to the rear of the existing structure so that they are less visible from the public right-of-way. Major additions which substantially alter or obscure the front of the structure should be discouraged but not automatically prohibited. For example, where lot size does not permit placement to the rear, and the proposed addition is compatible with the street scape, it should be subject to moderate scrutiny for contributing resources, but strict scrutiny for outstanding resources.

Secretary of the Interior's Standards for Rehabilitation:

The Secretary of the Interior defines rehabilitation as "the act or process of making possible a compatible use for a property through repair, alterations, and additions while preserving those portions or features, which convey its historical, cultural, or architectural values." The *Standards* are as follows:

- 2. The historic character of a property shall be retained and preserved. The removal of historic materials or alteration of features and spaces that characterize a property shall be avoided.
- 9. New additions, exterior alterations, or related new construction shall not destroy historic materials that characterize the property. The new work shall be differentiated from the old and shall be compatible with the massing, size, scale, and architectural features to protect the historic integrity of the property and its environment.
- 10. New additions and adjacent or related new construction shall be undertaken in such a manner that if removed in the future, the essential form and integrity of the historic property and its environment would be unimpaired.

STAFF DISCUSSION

The subject property is a c. 1892-1916 Dutch Colonial-style Contributing Resource within the Chevy Chase Village Historic District. There is an attached below grade garage to the east (rear/right) of the house and previous additions at the rear. The existing rear additions include a one-story octagonal structure roughly centered on the rear of the house and a one-story structure to the west (left, as viewed from the front), which projects beyond the west side of the house. There is a shed dormer at the rear, which was also added in 1984.

The applicants propose to construct a new two-story rear addition, completely removing the existing octagonal rear addition and reusing portions of the existing rear addition to the west. The roof of the existing below grade garage to the east will be extended to connect to the new addition, and the westernmost portion of the existing shed dormer will be removed to accommodate the roof of the proposed addition. An existing second-floor window on the historic house will be obscured by the proposed new addition, and a new window is proposed to the east. The pitch of the proposed addition's roof will be dictated by that of the existing addition that will be reused and by the presence of the existing shed dormer. The northwest corner of the historic house's gambrel roof will be consumed by the roof of the proposed addition. Shed dormers are proposed on the east and west sides of the proposed addition to provide sufficient head height on the second-floor. The existing additions project 10' into the rear yard, and the new addition will project an additional 4' to the rear (14' total).

The Guidelines state the following regarding major additions:

Major additions should, where feasible, be placed to the rear of the existing structure so that they
are less visible from the public right-of-way. Major additions which substantially alter or obscure
the front of the structure should be discouraged but not automatically prohibited. For example,
where lot size does not permit placement to the rear, and the proposed addition is compatible with
the street scape, it should be subject to moderate scrutiny for contributing resources, but strict
scrutiny for outstanding resources.

While the proposed addition will be constructed at the rear, it will project beyond the west side of the historic house and will be visible from the public right-of-way. Staff also finds that the addition will be at least partially visible from oblique angles along East Melrose Street and from Newlands Street to the rear. Because the addition will be visible from the public right-of-way, it should be reviewed with moderate scrutiny. According to the *Guidelines*:

• "Moderate Scrutiny" involves a higher standard of review than "lenient scrutiny." Besides issues of massing, scale and compatibility, preserving the integrity of the resource is taken into account. Alterations should be designed so that the altered structure still contributes to the district. Use of

compatible new materials, rather than the original building materials, should be permitted. Planned changes should be compatible with the structure's existing design, but should not be required to replicate its architectural style.

Staff has the following concerns regarding the proposal:

- The proposed addition will project beyond the west side of the historic house and be clearly visible from the public right-of-way, where it has the potential to detract from the streetscape. While, in some respects this is an existing condition, staff finds that is an incompatible alteration that would not be approved as part of an entirely new rear addition.
- The proposed addition will introduce various complex roof forms to the structure, which are incompatible with the character of the historic house.
- Removing the westernmost portion of the existing shed dormer results in an atypical condition at the ridge of the historic house.
- Regarding materials, the applicants propose to use compatible materials (i.e., shingle tile and standing seam copper roofing, cedar shingle siding, and aluminum-clad SDL casement windows to replace existing non-historic casement windows with snap-in grilles), but staff is concerned about the compatibility of the proposed windows and doors with the style of the historic house.

Staff asks for the Commission's guidance regarding the following:

- Should the applicants explore alternatives that do not project beyond the west side of the historic house?
- Should the applicants explore alternatives with less complex roof forms?
- Should the applicants explore alternatives that do not require the existing shed dormer to be altered and/or partially removed?
- Should the applicants explore alternative windows and doors with a more compatible number and/or pattern of lites?

STAFF RECOMMENDATION

• Staff recommends that the applicant make any revisions based upon the HPC's comments and return for a second preliminary consultation.



Edit 6/21/99

HISTORIC PRESERVATION COMMISSION 301/563-3400

APPLICATION FOR HISTORIC AREA WORK PERMIT

		an @.vac vahita -t	aom	Conduct Persons	Vince Greene
Contact Email	. vin	ce@vgarchitect	.com	Baytime Phone No.:	410-366-9982
ax Account Ha.:	00)455612		Section of section services	
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THE FOLLOWING ITEMS MUST BE COMPLETED AND THE REQUIRED DOCUMENTS MUST ACCOMPANY THIS APPLICATION.

1	. W	AITTEN DESCRIPTION OF PROJECT
	4.	Description of existing structure(s) and environmental setting, including their historical features and significance;
		SEE ATTACHED PAGE - Description of existing Structure
	b.	General description of project and its effect on the historic resource(s), the environmental setting, and, where applicable, the historic district: SEE ATTACHED PAGE- General Description of Project
2.	ŞIT	EPLAN
	Site	and environmental setting, drawn to scale. You may use your plat. Your site plan must include:
		the scale, north errow, and date;
	b.	dimensions of all existing and proposed structures; and
		site features such as walkways, driveways, fences, ponds, streams, trash dumpsters, mechanical equipment, and landscaping.
		and landscaping.
3.	PLA	INS AND ELEVATIONS
	<u>You</u>	must submit 2 copies of plans and elevations in a format no larger than 11" x 17". Plans on 8 1/2" x 11" paper are preferred.
	4.	Schemetic construction plens, with marked dimensions, indicating location, size and general type of walls, window and door openings, and other fixed features of both the existing resource(s) and the proposed work.
		Elevations (facades), with marked dimensions, clearly indicating proposed work in relation to existing construction and, when appropriate, context. All materials and fixtures proposed for the exterior must be noted on the elevations drawings. An existing and a proposed elevation drawing of each facade affected by the proposed work is required.
4.	MA	TERIALS SPECIFICATIONS
	Gen desi	eral description of materials and manufactured items proposed for incorporation in the work of the project. This information may be included on your gn drawings.
5.	<u>PH0</u>	TOGRAPHS
	a. (Clearly labeled photographic prints of each facade of existing resource, including details of the affected portions. All labels should be placed on the ront of photographs.
	b. (learly label photographic prints of the resource as viewed from the public right-of-way and of the adjoining properties. All labels should be placed on he front of photographs.
6.	TAEE	SURVEY
	If you must	use proposing construction adjacent to or within the dripline of any tree 6° or larger in diameter (at approximately 4 feet above the ground), you file an accurate tree survey identifying the size, location, and species of each tree of at least that dimension.
7.	ADD	RESSES OF ADJACENT AND CONFRONTING PROPERTY OWNERS

For ALL projects, provide an accurate list of adjacent and confronting property owners (not tenants), including names, addresses, and zip codes. This list should include the owners of all lots or parcels which adjoin the parcel in question, as well as the owner(s) of lot(s) or parcel(s) which lie directly across the street/highway from the parcel in question.

HAWP APPLICATION: MAILING ADDRESSES FOR NOTIFING [Owner, Owner's Agent, Adjacent and Confronting Property Owners]


Owner's mailing address	Owner's Agent's mailing address		
THOMAS O'DONNELL and CAROLINE FAWCETT 3 E MELROSE STREET CHEVY CHASE, MD 20815	Vincent Greene Vincent Greene Architects 733 W. 40th Street Suite 250-PS Baltimore, MD 21211		
Adjacent and confronting	g Property Owners mailing addresses		
FARMER CHARLES N ET AL TR 15 E MELROSE ST CHEVY CHASE MD 20815	FLANAGAN EUGENE & SONYA B 11 E MELROSE ST CHEVY CHASE MD 20815		
12 E MELROSE LLC 12 E MELROSE ST CHEVY CHASE MD 20815	WIACEK RAYMOND J & O'CONNELL NANCY 16 E MELROSE ST CHEVY CHASE MD 20815		


1(A). Description of Existing Structure

The existing house dates to 1908, and is a gambrel-roofed Craftsman clad in stained cedar shingles with a variegated flat, clay-tile roof. It is located on an 8,125 squarefoot (.187 acre) lot along the middle of the block, with a subterranean garage entrance and elevated pedestrian entrance at opposite ends of the street façade. The structure is characterized on its public side by double-hung windows with diamond-shaped muntin patterns, unique paneled shutters, decorative handrail ironwork, and a semi-circular brick stoop in radial pattern. As you move around the sides to the rear, clear evidence of subsequent additions is present, notably, a onestory rear addition measuring 27' wide and projecting 10' into the rear yard, designed by Abel & Weinstein in 1984. Some of the windows have snap-in grilles, lite patterns and proportions change, the base of the building shows simple parging, and there are places where the skirting roofs are interrupted by crickets and other modern intrusions. At the top rear of the house, a long shed dormer was added as part of the 1984 work to provide light for a Third Floor studio. This dormer actually reaches across the main house ridge, and is slightly evident from the street side. Finally, there is an extension of a prefabricated chimney on the East side, that is clad in cedar shingles instead of masonry. There are no other obvious historic structures on the property, although an in-ground swimming pool and shed of unknown date are both present.

1(B). General Description of Project

There are no design changes planned for the streetside façade. The proposed improvements include the replacement of the 1984 rear addition mentioned above. with a two-story version that adds 112 s.f. of site footprint. This volume creates a new Kitchen/Dining area on the First Floor and a Master Suite under-roof above. The new footprint projects into the rear yard an additional 4.0 feet. Roof forms have been chosen to appear as though the new addition could have been part of the original, with existing skirt roof planes wrapping around to the rear. Existing slates will be harvested and re-used with additional matching material to create a continuous effect. The planned shed dormers will be capped in standing seam copper. to match the existing Third-Floor dormer and reduce the amount of clay tiles needed. New windows shall be aluminum-clad with simulated divided lites, in an exterior color to match the existing historic units. Existing "snap-in" grids found along the East and North sides shall be replaced with SDL units as well. Shingle detailing along the rakes will match the same details on the existing house, as will fascias, soffits, and casings. New windows shown with panels below will be made from cementitious material, bordered in painted mouldings to create a recessed panel effect. Crown mouldings with copper caps are shown on the rear window sets to provide better overall proportions on that face. Gutters and downspouts will be natural copper to match those on the existing street façade. New shutters will be paneled and colored to match existing, and will be of a thickness that matches the originals. (The cutouts will be omitted to keep clear what was new versus original.) We also ask permission to repair the existing aggregate concrete driveway and curbing that leads from the street surface, across the sidewalk, and down to the subterranean garage entry. The proposed replacement material is Techo-Bloc "Venetian" pavers, as described in the materials description. Our opinion is that the planned architectural design does a great deal to simplify the rear massing of the house, while at the same time respecting the original historic materials and silhouette. A large quantity of functional square footage has been added to the floor plans with very little external effect, using architectural elements that, in most cases, already exist on the building. Even adjustments to the 1984 third-floor shed dormer have been minimized, limiting any visual changes to the street side of the dwelling, and lending the original dormer narrower proportions. The new addition does not infringe upon any setbacks, conforms to coverage limitations, and is barely visible from the public right-of-way. No trees greater than 6" in diameter are slated for removal.

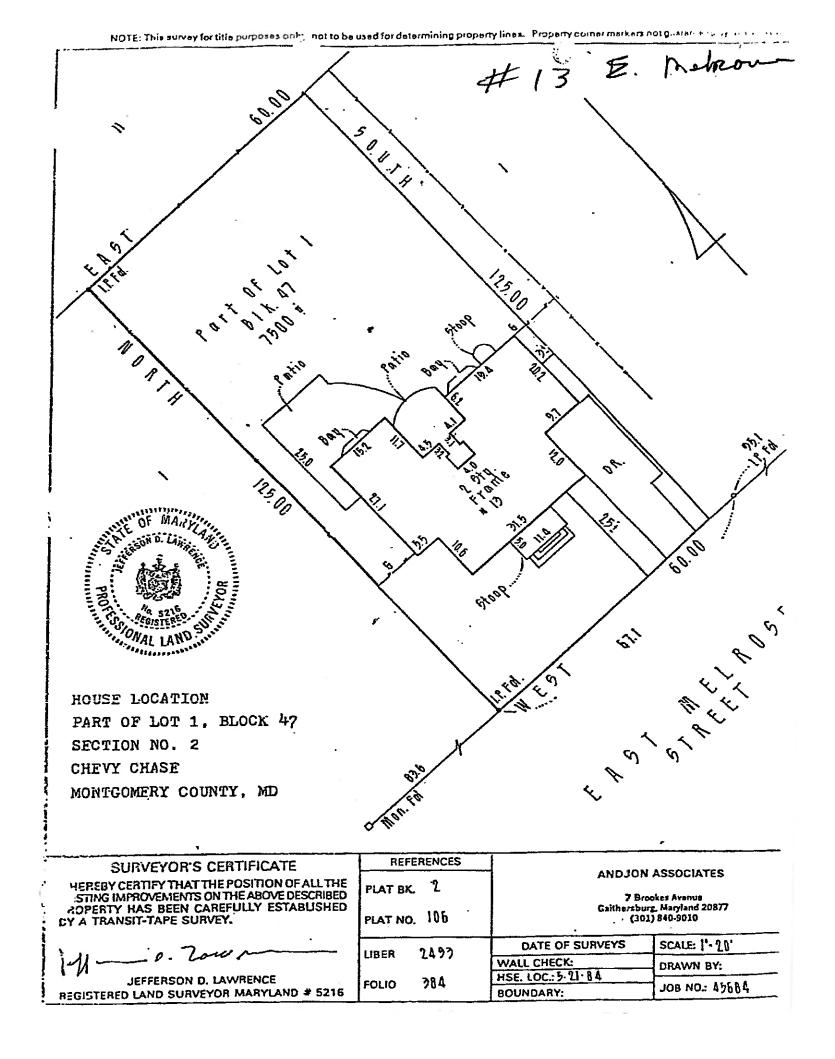

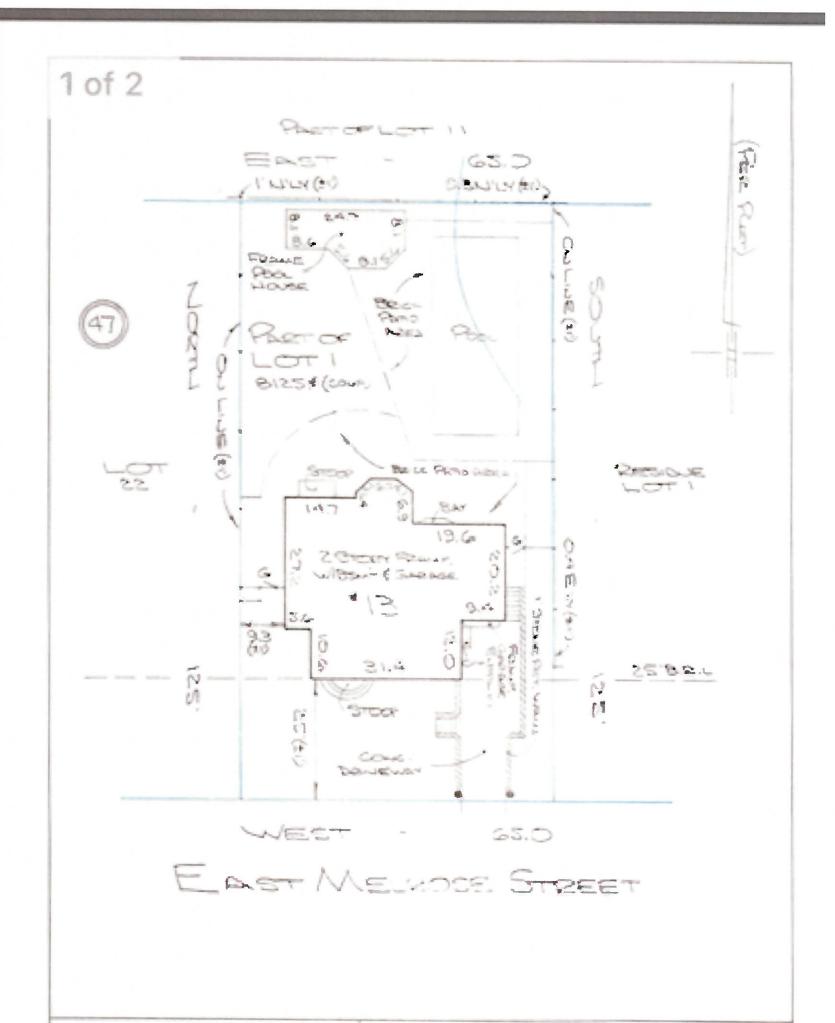


Capitol Surveys, Inc.


10762 Rhode Island Avenue Beltsville, Maryland 20705 Phone 301-931-1350 Fax 301-931-1372 In Title Plat is of benefit to a consumer only insofar as it is required by a tender or a title integrance company or its agent in connection with contemplated transfer. Engaging or refine only, the plat is not to be raised upon for the establishment or location of location, purpose, buildings, or other studies of force improvements, and the plat does not provide for the accurate destablishment of property boundary lines, but such identification stary not be required for the transfer of title and securing financing or refinancing.


LOCATION DRAWING
BLOCK AT
SECTION MO. 2
CHEVY CLUDGE
MONTGOMERY COUNTY, MARYLAND

I hereby cominy this locations drawing was prepared in accordance with the minimum standards of practice for the State of Many and and is correct to the best of my best of what can be visually and accessibly observed.

LPZ.

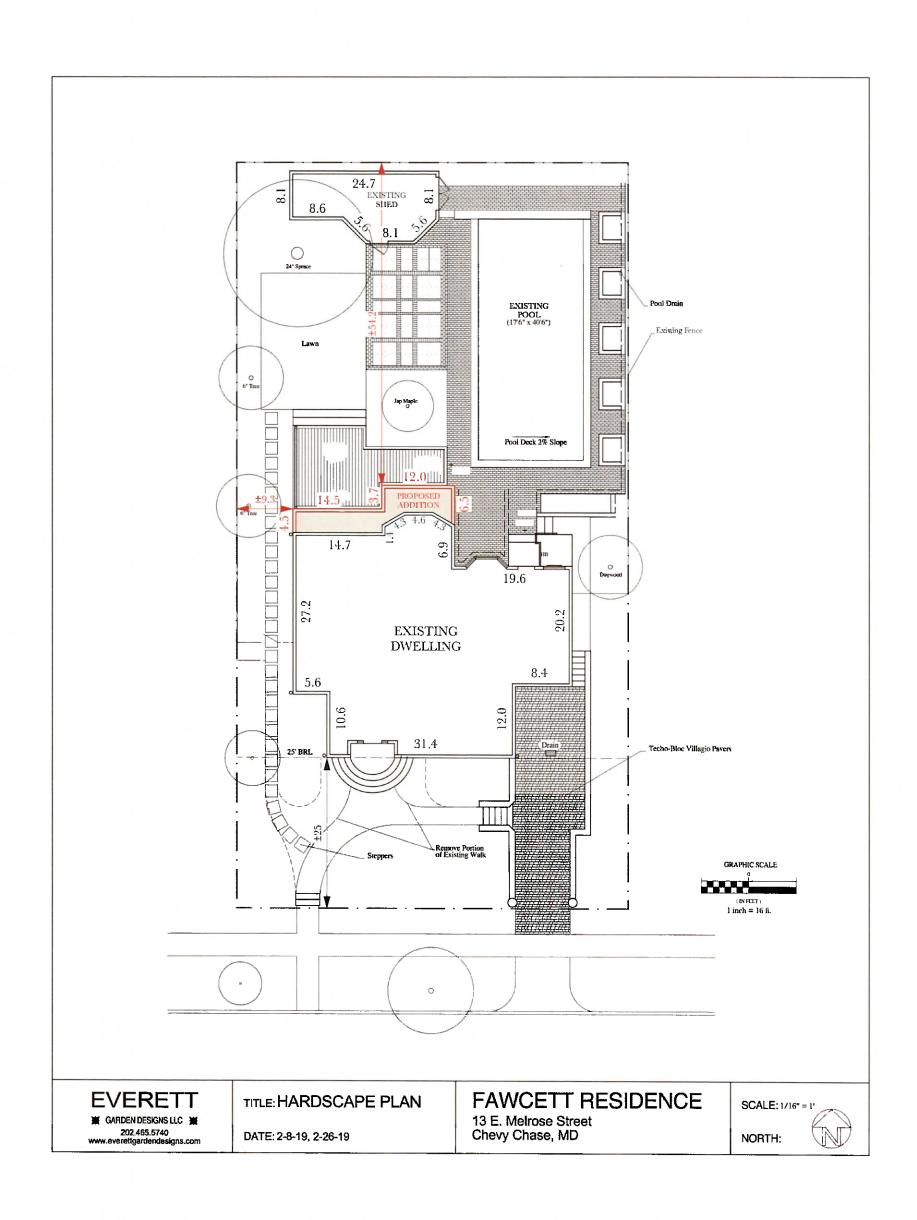

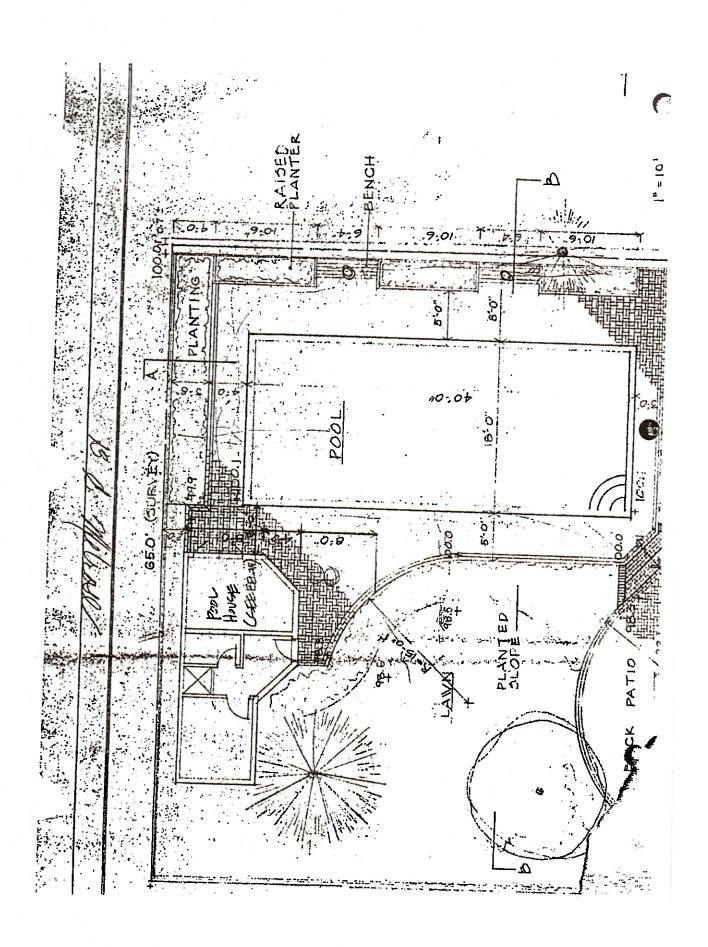


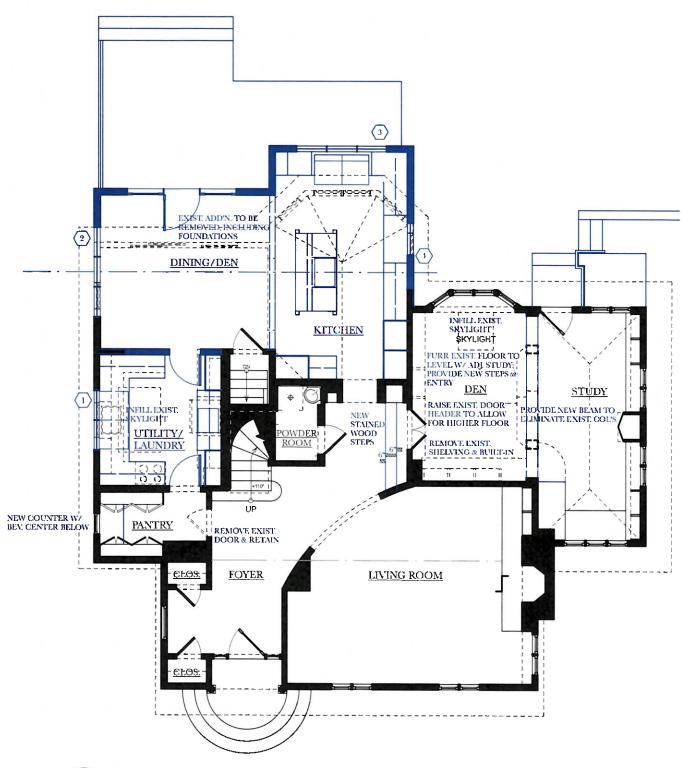


PROPOSED FIRST FLOOR PLAN

SCALE: 1/8" = 1'-0"

PROJECT NAME:	DRAWING TITLE:	© 2019 GREENEARCH	DATE:	DRAWING #:
FAWCETT/O'DONNELL RESIDENCE 13 E. MELROSE STREET CHEVY CHASE, MARYLAND 20815	PROPOSED FIRST FLOOR PLAN	SGALE: 1/8" = 1'-0"	CREATED: 01/16/2019 REVISED: 03/06/2019	A-101 15

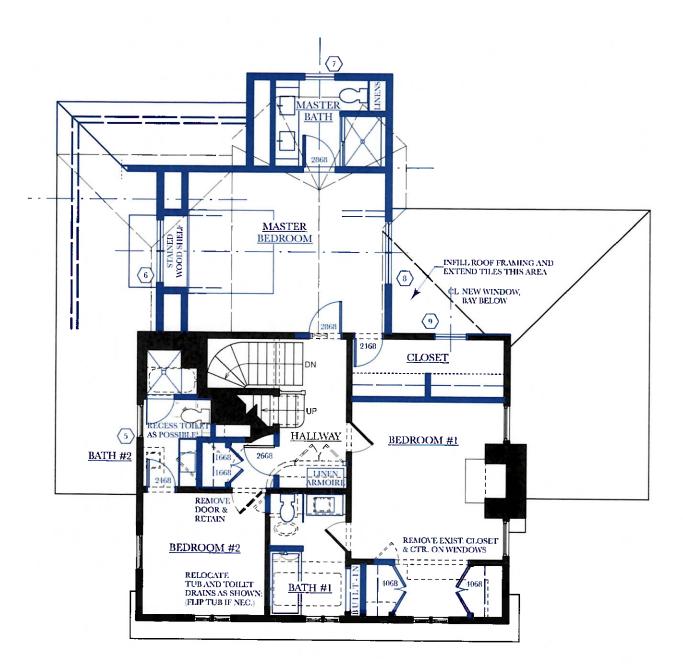


1 PROPOSED SECOND FLOOR PLAN SCALE: 1/8" = 1'-0"

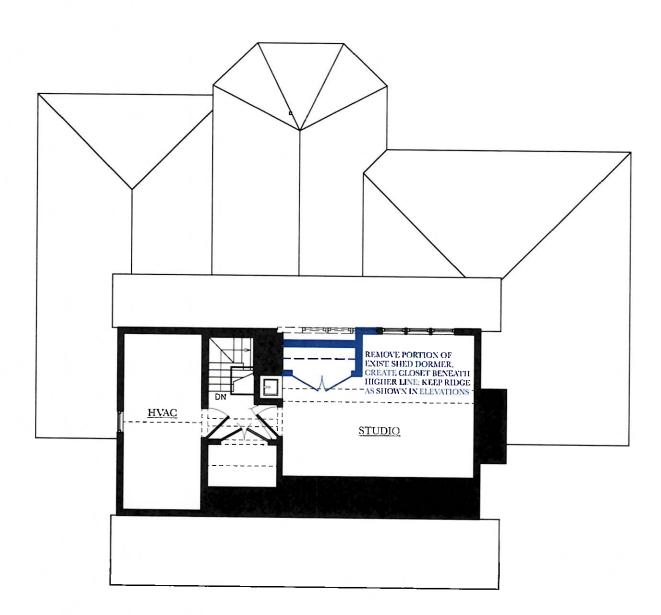

2 PROPOSED THIRD FLOOR PLAN SCALE: 1/8" = 1'-0"

PROJECT NAME:	DRAWING TITLE:	© 2019 GREENEARCH	DATE:	DRAWING #:
FAWCETT/O'DONNELL RESIDENCE 13 E. MELROSE STREET CHEVY CHASE, MARYLAND 20815	PROPOSED FLOOR PLANS	SCALE: 1/8" = 1'-0"	CREATED: 01/16/2019 REVISED: 03/06/2019	A-102 16

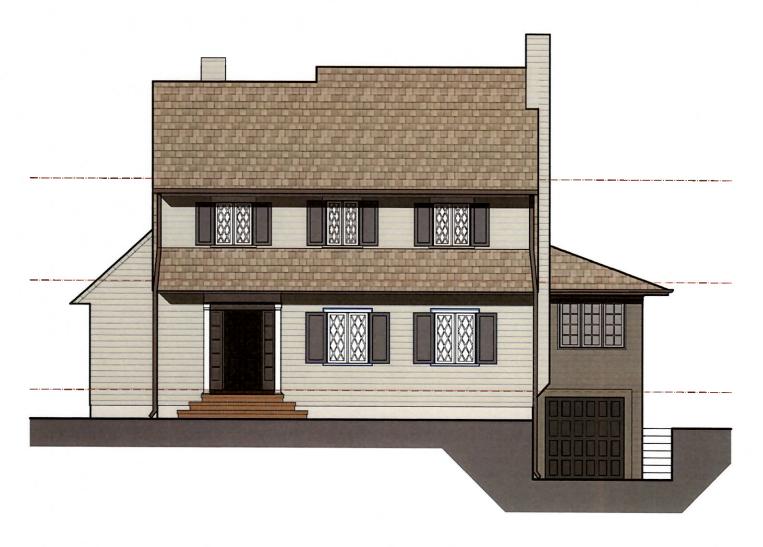

PROJECT NAME:	DRAWING TITLE:	© 2019 GREENEARCH	DATE:	DRAWING #:
FAWCETT/O'DONNELL RESIDENCE 13 E. MELROSE STREET CHEVY CHASE, MARYLAND 20815	FRONT ELEVATION (SOUTH)	SCALE: 1/8" = 1'-0"	CREATED: 01/16/2019 REVISED: 03/06/2019	A-200



16-OUNCE HAND-TURNED NATURAL COPPER W/ 1" STANDING SEAMS

BORAL TRU-WOOD PAINTED RUNNING TRIM TO MATCH EXISTING, W BORAL TRU-WOOD PAINTED TONGUE-AND-GROOVE BEADED SOFFITS AND RAKES

STAINED WRC SHINGLES IN GRADE/ EXPOSURE, TO MATCH EXISTING

SIMULATED DIVIDED LITE, ALUMINUM CLAD WHITE WINDOW; LITE PATTERNS AS SHOWN

NON-OPERATIONAL PREFINISHED COMPOSITE SHUTTER, "TIMBERLANE" OR EQUAL, WITH SHUTTER DOGS

SALVAGED CERAMIC NORMAN TILE IN VARIEGATED COLOR TO MATCH EXISTING



-SIMULATED DIVIDED LITE,
ALUMINUM CLAD WHITE WINDOW;
LITE PATTERNS AS SHOWN. SHUTTER
TO BE NON-OPERATIONAL
COMPOSITE, "TIMBERLANE" OR
EQUAL, WITH SHUTTER DOGS

-STAINED WRC SHINGLES IN GRADE/ EXPOSURE, TO MATCH EXISTING

BORAL TRU-WOOD PAINTED
RUNNING TRIM TO MATCH EXISTING,
-W/BORAL-TRU-WOOD PAINTED
TONGUE-AND-GROOVE BEADED
SOFFITS AND RAKES

-SALVAGED CERAMIC NORMAN TILE IN VARIEGATED COLOR TO MATCH EXISTING

> —COPPER GUTTERS AND DOWNSPOUTS TO MATCH EXISTING

-SIMULATED DIVIDED LITE, ALUMINUM CLAD WHITE DOOR PANELS; LITE PATTERNS AS SHOWN.

-NEW BRICK STEPS TO MATCH EXISTING

SIMULATED DIVIDED LITE,
ALUMINUM CLAD WHITE WINDOW/
DOOR IN EXISTING LOCATIONS; LITE
PATTERNS AS SHOWN


COPPER GUTTERS AND DOWNSPOUTS TO MATCH EXISTING


RECESSED FLAT PANEL IN PAINTED CEMENTITIOUS SMOOTH MATERIAL, W/ OVOLO BEAD AROUND INTERIOR SHOULDER

SIMULATED DIVIDED LITE, ALUMINUM CLAD WHITE WINDOW; LITE PATTERNS AS SHOWN


2 PROPOSED REAR ELEVATION (NORTH)
SCALE: 1/8" = 1'-0"

PROJECT NAME: DRAWING TITLE: © 2019 GREENEARCH DRAWING #: SCALE: 1/8" = 1'-0" CREATED: 01/16/2019 FAWCETT/O'DONNELL EXISTING/PROPOSED REVISED: 03/06/2019 RESIDENCE REAR ELEVATION A-202 13 E. MELROSE STREET (NORTH)CHEVY CHASE, MARYLAND 20815 18

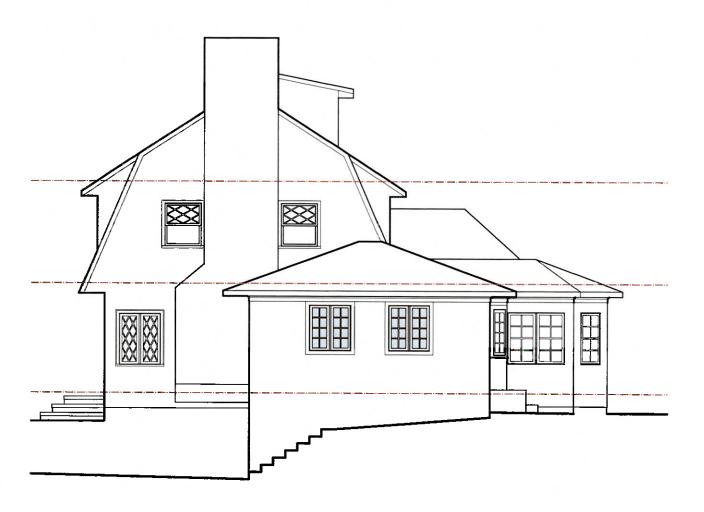


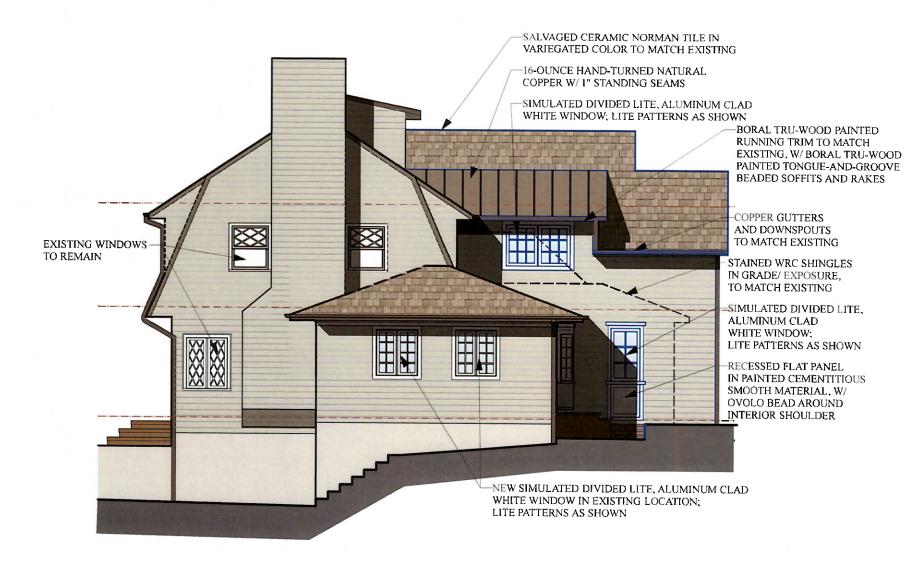

PROJECT NAME: DRAWING TITLE: © 2019 GREENEARCH DRAWING #: DATE: SCALE: 1/8" = 1'-0"CREATED: 01/16/2019 FAWCETT/O'DONNELL EXISTING/PROPOSED REVISED: 03/06/2019 RESIDENCE SIDE ELEVATION A-201 13 E. MELROSE STREET (EAST)CHEVY CHASE, MARYLAND 20815 19

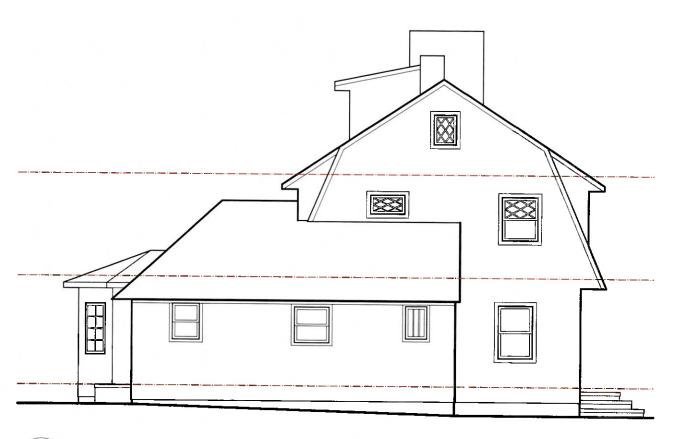

 $1 \quad \frac{\text{EXISTING SIDE ELEVATION (WEST)}}{\text{SCALE: } 1/8" = 1'-0"}$

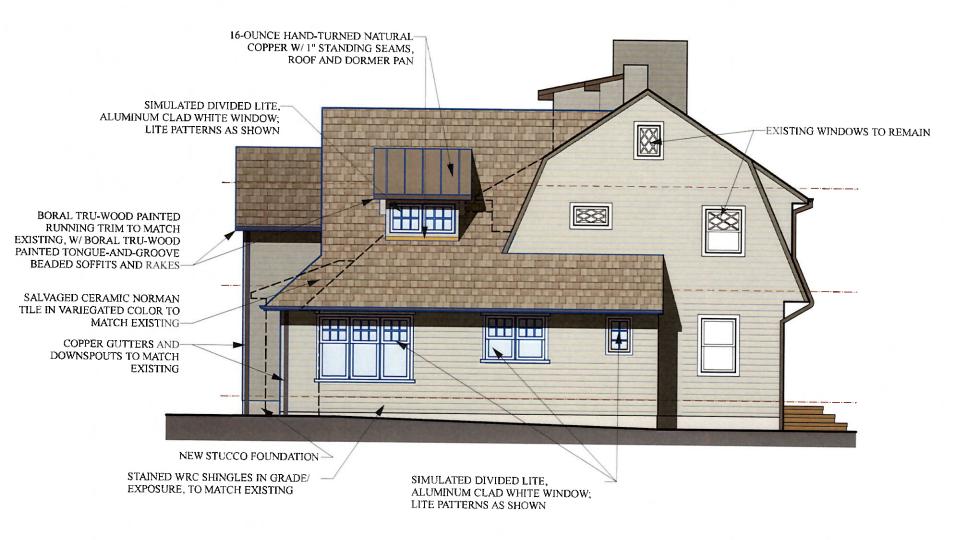

PROJECT NAME:	DRAWING TITLE:	© 2019 GREENEARCH	DATE:	DRAWING #:
FAWCETT/O'DONNELL RESIDENCE 13 E. MELROSE STREET CHEVY CHASE, MARYLAND 20815	EXISTING/PROPOSED SIDE ELEVATION (WEST)	SCALE: 1/8" = 1'-0"	CREATED: 01/16/2019 REVISED: 03/06/2019	A-203 20

Existing Property Condition Photographs (duplicate as needed)



Detail: Front Elevation



Detail: Front Elevation

Existing Property Condition Photographs (duplicate as needed)



Detail: Rear Elevation



Detail:_

Rear Elevation

March 11, 2019

Michael Kyrne Montgomery County Planning Department 8787 Georgia Avenue Silver Spring, MD 20910

RE: Exterior Material Specification 13 East Melrose Chevy Chase, MD 20815

Mr Kyrne,

Per your request, below are the exterior material specifications for the above referenced property. Supplemental specifications with more detail are enclosed. Please let us know if you need any additional information

Sincerely,

David Myers Vincent Greene Architects

Windows

Manufacturer: Marvin Type: Ultimate Casement

Material: Aluminum clad exterior; painted pine interior

Color: Stone White

Glazing: Low E2 with Argon

Options: 7/8" simulated divided lites with stainless steel spacer bar between glass

Doors

Manufacturer: Marvin

Type: Ultimate Swinging French Door

Material: Aluminum clad exterior; painted pine interior

Color: Stone White

Glazing: Low E2 with Argon Hardware: Oil Rubbed Bronze

Options: 7/8" simulated divided lites with stainless steel spacer bar between glass

Tile Roofing

Manufacturer: Ludowici

Type: Shingle Tile - Greenwich

Material: Terra Cotta

Color: Custom blend to best match existing. Custom variation of "Aged Copper"

* Architect intends to salvage/reuse existing roofing removed from existing house and reuse to maximum extent possible.

Metal Roofing

Manufacturer: N/A

Type: Standing Seam Metal Material: 16oz Red Copper

Installation type: Hand-turned, 1" standing seam, 16"o.c., double lock

Wall Shingles

Manufacturer: N/A

Type: Wood wall shingles

Material: Certigrade Western Red Cedar; Number 1 Blue Label; non-rebutted/rejointed

Color: Solid stain; match existing Exposure: 6"/match existing

Shutters

Manufacturer: Timberlane

Type: Endurian
Material: Composite
Color: match existing

Profile: FP1

Hardware: "S" Style Tiebacks and pintels to match existing

1. Manufactured Units

Description: Factory-assembled Aluminum Clad Ultimate Casement/Awning, operating exterior swing window on Casement as manufactured by Marvin Windows and Doors, Warroad, Minnesota.

2. Frame Description

- A. Interior: Non Finger-Jointed Pine
- B. Frame exterior aluminum clad with 0.050 inch (1.3mm) thick extruded aluminum
- C. Frame thickness: 1 3/16" (30mm)
- D. Frame depths for full frame units have an overall 5 21/32" jamb (144mm). 4 9/16" (116mm) jamb depth from the nailing fin plane to the interior face of the frame for new construction.

3. Sash Description

- A. Interior: Non Finger-Jointed Pine
- B. Sash exterior aluminum clad with 0.050" (1.3mm) thick extruded aluminum
- C. Sash thickness: 1 5/8" (41mm) and 1 7/8" (48mm) for full frame units.
- D. Stiles and Rails: 2 1/16" (52mm)
- E. Sash Option: Optional tall bottom rail: 3 9/16" (90mm)
- F. Interior Sash Sticking: Ogee

4. Glazing

- A. Select quality complying with ASTM C 1036. Insulating glass SIGMA/IGCC certified to performance level CBA when tested in accordance with ASTM E 2190
- B. Glazing method: Insulating glass
- C. Glazing seal: Silicone bedding at interior and exterior
- D. Glass Type: Low E2 with Argon

5. Finish

Exterior: Aluminum clad. Fluoropolymer modified acrylic topcoat applied over primer. Meets or exceeds AAMA 2605 requirements.

Aluminum clad color: Stone White

6. Hardware

Casement operating hardware:

- Locks: Multi-point sequential concealed locking system in the jamb opposite the hinge side for casement units. Lock handles are removable, non-handed and are available in the same finishes as the handles. Standard tie bars, cams and keepers – steel coated with E-Gard ™. Keeper features a roller for reduce average lock force and does not easily disengage with the cam even under severe loading. Stainless steel packages are available for coastal application.
- Handles: Standard operating handle is a folding handle, zinc painted with the standard folding cover being molded plastic. Available colors: standard is Satin Taupe (painted), White (painted), Bronze (painted), Matte Black (painted), Satin Chrome (plated), Satin Nickel (plated), Oil Rubbed Bronze (plated), Brass (plated), Antique Brass (plated)
- 3. Hinges: One at the sill to bottom rail, one at the head jamb to top rail. Hinges are steel coated with E-Gard™. Hinge track is stainless steel. Unit with a frame OM of 20 inches (508mm) and greater use an 18 inch (457mm) wash/egress hinge to allow the sash to slide across the frame opening which causes the sash exterior to rotate towards the user for easy wash ability. Units under a frame OM of 20 inches (508mm)width use a standard 2 bar hinge which will position the sash when fully open to 90degrees for the user to wash but does not include the feature of sliding the sash across the opening and rotating the exterior towards the user.
- 4. Factory Installed Window Opening Control Device (WOCD): Minimum frame OSM 26" (660mm) x 19 ¼" (489mm); Maximum frame OSM 40" (1016mm) x 92" (2337mm) if frame is less than 36" than 36" (914mm) x 96 1/8" (2442mm). WOCD locking assembly: Factory installed. Die Cast. Color: Satin Taupe, Bronze, White, Matte Black, Oil Rubbed Bronze, Brass, Satin Nickel, Antique Brass, Polished Chrome, and Satin Chrome. WOCD tether assembly: Factory installed. Glass filled nylon. Color: E-Gard™ color match.

7. Weather Strip

A. Weather strip at the frame is a hollow-foamed material bent around 90 degree corner to allow for seamless corner joints

Color: Beige

B. Sash weather strip bulb shaped glass filled material

Color: White

8. Insect Screen

A. Crank Out

1. Aluminum frame finish: Stone White

2. Screen mesh: Charcoal Fiberglass

10. Simulated Divided Lites (SDL)

- A. 7/8" (22mm) wide
- B. Exterior muntins: 0.055" (1.4mm) thick extruded aluminum
- C. Interior muntins: Pine
- D. Muntins adhere to glass with closed-cell copolymer acrylic foam tape
- E. Sticking: Ogee
- F. Patterns: Per Elevations
- G. Finish exterior matches exterior aluminum clad colors, interior matches' interior wood species and color

1. Manufactured Units

A. Description: Factory-assembled Aluminum Clad Ultimate Inswing / Outswing French Door manufactured by Marvin Windows and Doors, Ripley, Tennessee.

2. Frame Description

- A. Interior: Non Finger-Jointed Pine
- B. Frame exterior aluminum clad with 0.050" (1.3mm) thick extruded aluminum
- C. Frame width: 4 9/16" (116mm); 6 9/16" (167mm)
- D. Frame thickness: 1 1/16" (27mm)
- E. Inswing French Door Sill: A single pultrusion of Fiber Reinforced Plastic (FRP), also known as Ultrex®, provides superior thermal performance
 - 1. An integral weep system is part of a water management system that directs any incidental moisture to the exterior
 - 2. Sill depth is 5 5/8" (143mm) for 4 9/16" (116mm) wall application and 7 5/8" (194mm) for 6 9/16" (167mm) jambs
 - 3. Finish: bronze

3. Panel Description

- A. Interior: Non Finger-Jointed Pine
- B. Panel exterior aluminum clad with 0.050" (1.3mm) thick extruded aluminum
- C. Panel thickness: 1 3/4" (44mm)
- D. Top rail and stile width: 4 3/4" (121mm)
- E. Sidelite stile width: 3" (76mm)
- F. Traditional French Door bottom rail height: 8 1/8" (206mm)

4. Glazing

- Select quality complying with ASTM C 1036; Shall comply with 16 CFR 1201 Safety Standard for Architectural Glazing Materials
- B. Glazing Method: Tempered Insulating Glass (altitude adjusted)
- C. Standard interior wood cope sticking: Ogee
- D. Glass Type: Low E2 with Argon
- E. Glazing Seal: Silicone bedding, exterior

5. Finish

- A. Exterior: Aluminum Clad. Fluoropolymer modified acrylic topcoat applied over primer. Meets AAMA 2605 requirements.
 - 1. Aluminum clad color options: Stone White
 - 2. Custom colors: Contact your Marvin representative
- B. Interior Finish Options:

Prime: Factory-applied enamel primer. Available on Pine product only. Meets WDMA TM-11 requirements.

6. Hardware

- A. Adjustable Hinges:
 - 1. 4 ¼" x 3 ¾" with 3/8" radius corners. Adjustment is 3/16" for horizontal and vertical of panels in frame.
 - 2. Rectangular doors have three adjustable hinges on 6-6, 6-8, 7-0 and 8-0 heights; optional four hinges on 7-0 and 8-0 heights
 - 3. Arch top doors have three adjustable hinges up to 80" (2032mm). Units greater than 84" (2134mm) have four hinges
 - 4. Finish: Satin Taupe with steel substrate
 - a. Optional powder coat finish: Gold tone, Dark Bronze, Silver Frost, White
 - 5. Optional metal finish: Brass PVD, Oil Rubbed Bronze PVD, Satin Nickel PVD, Antique Brass, Satin Chrome, Oil Rubbed Bronze, or Polished Chrome.
- B. Traditional Handle Set:

Metal finish: Oil Rubbed Bronze

- D. Locking System:
 - 1. Active panel: Marvin exclusive concealed multi-point locking system. Stainless steel head and shoot bolts operated from lever set. One inch dead bolt.
 - 2. Inactive panel: Manual stainless steel head and shoot bolts with dummy handle. Optional Stainless steel head and shoot bolts operated with inactive handle.

8. Weather Strip

- A. Inswing: Head jamb and side jambs to have 2 rows of bulb weather strip maintaining contact with door panel. Color: black
- B. Inswing and Outswing: Threshold to have bulb weather strip maintaining contact with bottom of panel. Color: black

C. Inswing: Vinyl panel drip applied to bottom rail. Color: black

11. Simulated Divided Lites (SDL)

A. 7/8" (22mm) wide

B. Muntins: Pine interior, aluminum clad exterior

C. Muntins adhere to glass with double coated acrylic foam tape

D. Sticking:

1. Standard: Ogee

2. Optional: Square

E. Pattern: Rectangular, Cottage, Custom lite layout

F. Finish: Match panel finish


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PRODUCTS COLORS & TEXTURES PROJECTS & GALLERY THE LUDOWICI DIFFERENCE

RESOURCES CONTACT

GREENWICH



ROOF TILE

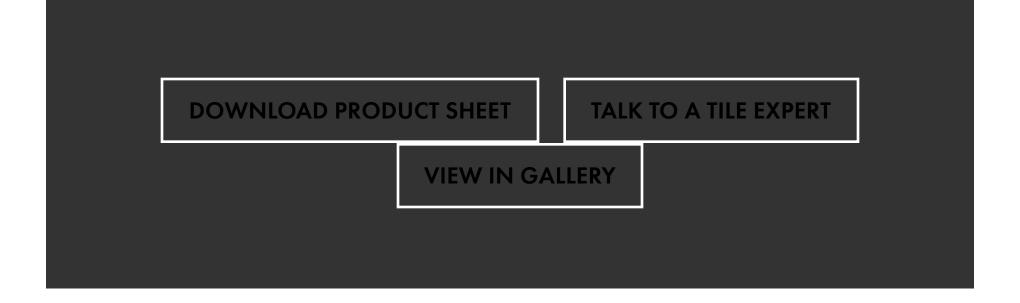OVERVIEW DETAILS ACCESSORIES COLORS & TEXTURES

BARREL TILE

SHINGLE TILE

INTERLOCKING TILE

SHAKE TILE

SLATE TILE

GRADUATED & TAPERED

TILE

CUSTOM TILE

IMPORTED TILE

ROOF

ACCESSORIES

HIP & RIDGE SYSTEMS

DECORATIVE

ACCESSORIES

UNDERLAYMENT &

FASTENERS

FLOOR TILE

TESTING & CERTIFICATIONS

Greenwich is a ½" thick flat slab shingle tile with a battered surface and a rounded distressed bottom edge. This historic tile provides a charming, aged appearance to any structure, without losing the security of a solid terra cotta roof. Greenwich shingle tiles are available in standard and custom matte colors, mists and blends.

Ludowici's Greenwich clay shingle tile is covered by a 75-year material warranty.





QUARRY TILE

WALL CLADDING &	CHARACTERISTIC	SPECIFICATION
SOLAR SHADES	WEIGHT PER SQUARE	1575 lbs.
	PIECES PER SQUARE	317 pcs.
	OVERALL SIZE	7" x 15" x 1/2"
	EXPOSURE	7" x 6-1/2"
	INSTALLED BARREL HEIGHT OFF DECK	N/A
	MINIMUM SLOPE	5:12
	BASE TEXTURE	Pitted

SAMPLES & PRICING

Contact Ludowici today to order samples, review pricing and more.

ORDER NOW

CONTACT

IMPORTANT LINKS NEWSLETTER

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New Lexington, Ohio

43764

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Opportunities

SIGN UP

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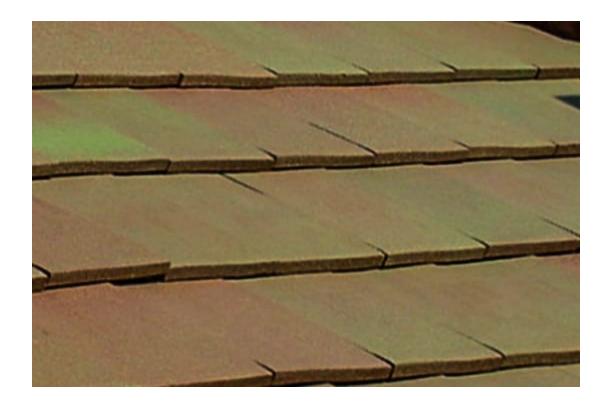
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SALES TEAM LOGIN

TERMS & CONDITIONS

PRIVACY

SITEMAP



CERTIGRADE® WESTERN CEDAR SHINGLES_

Number 1 Blue Label®





The premium grade of shingles for sidewalls and roofs. These top-grade shingles are 100% heartwood, 100% clear and 100% edge grain. Available in 16" or 18" or 24" lengths.

Number 2 Red Label





A good grade for many applications. Not less than 10" clear on 16" shingles, 11" clear on 18" shingles and 16" clear on 24" shingles. Flat grain and limited sapwood are permitted in this grade.

Number 3 Black Label





A utility grade for economy applications and secondary buildings. Not less than 6" clear on 16" and 18" shingles, 10" clear on 24" shingles.

Number 4 Undercoursing





A utility grade for undercoursing of double coursed sidewalls only. Not a roofing material and not to be used as a starter course for roofs.

CERTI-LABEL WESTERN CEDAR SHAKES

Certi-Split® Handsplit Shakes





These shakes have split faces and sawn backs. Cedar logs are first cut into desired lengths. Blanks or boards of proper thickness are split and then run diagonally through a bandsaw to produce two tapered shakes from each blank. Available in Premium Grade (100% edge grain) or Number 1 Grade (Up to 20% flat grain allowed in each bundle).

Certi-Sawn® Tapersawn Shakes





These shakes are sawn both sides. Premium and Number 1 Grades are the most common. Premium Grade is 100% edge grain, 100% clear and 100% heartwood. Number 1 Grade allows up to 20% flat grain in each bundle. Number 2 and 3 Grades are also available.

TIMBERLANE **ENDURIAN®**

Elegant, Versatile, Maintenance-Free Shutters

CHOOSE FROM 29 PROFILES

Timberlane Endurian® Shutters can be milled to create a wide variety of panel and louver profiles and offer the option to be modified in almost every fashion that our Premium Wood line can. Your Timberlane Expert will be happy to assist you with all of your selections; from color, to shape, to size, and more! Customize your Endurian® Shutters to get the perfect design for your home.










VENETIAN

DESCRIPTION: Step Overlay System TEXTURE: Slate

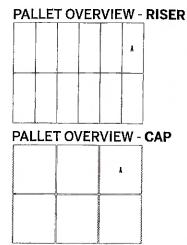



NOTES

Techo-Bloc always recommends gluing the caps with concrete adhesive to ensure stability and safety.

See 215 for more technical information.

*Mojave beige and Harvest gold are only available in Midwestern USA. See page 15 for list of Eastern and Midwestern States.

•	ecifications per pallet	шре	Imperial		tric
RISER	Cubing	48 ι	48 units 64 lin. ft 801 lbs 1.33 lin. ft 4 16 lin. ft		units
	Linear coverage per pallet	64 li			52 lin. m
	Weight	801			3 kg
	Units	1.33			l lin. m
	Number of rows	4			The state of the s
	Linear coverage per row	16 lii			4.88 lin. m
_	Unit dir	mensions	in	mm	Units/pallet
Y	o M	Height Depth	1 ³ / ₄	45 178	48 units
	6	Length	16	406	

Sp	Specifications per pallet		Imperial		tric
S.	Cubing	48 un	48 units 64 lin. ft 1 530 lbs 1,33 lin. ft		units
	Linear coverage per pallet	64 lin.			52 lin. m
	Weight	1 530			4 kg
	Units	1.33 lii			1 lin. m
	Number of rows	8			
	Linear coverage per row	8 lin. ft		2.44 lin. m	
_	Unit di	mensions	in	mm	Units/pallet
	0	Height Depth	1 ³ / ₄ 14	45 356	48 units

Length

16

406



